

PROPOSED BUILDING ADDITIONS

22 FRIARS DRIVE HUDSON, NEW HAMPSHIRE

INDEX OF PLANS				
SHEET No.	TITLE			
1 OF 15	MASTER SITE PLAN	1"= 50'		
2 OF 15	EXISTING CONDITIONS PLAN	1"= 40'		
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4 OF 15	SITE GRADING & UTILITY PLAN	1"= 30'		
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6 OF 15	EROSION CONTROL PLAN	1" = 30"		
7-8 OF 15	UTILITY PROFILES	1"= 20" H 1"= 4" V		
9-11 OF 15	DETAIL SHEETS - GENERAL SITE			
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13 OF 15	PHOTOMETRIC SITE LIGHTING PLAN	1"= 30'		
14-15 OF 15	LANDSCAPE PLANS	1"= 30'		

PURSUANT TO THE SITE REVIEW		E HUDSON, NH PLANNING BOARD
REGULATIONS OF THE HUDSON	DATE OF MEETING:	
PLANNING BOARD, THE SITE PLAN APPROVAL	CHAIRMAN:	SIGNATURE DATE:
GRANTED HEREIN	SECRETARY:	SIGNATURE DATE:
EXPIRES TWO YEARS FROM DATE	MEETING FINAL APPROVAL	WO (2) YEARS FROM THE DATE OF PLANNING BOARD FINAL APPROVAL COMMENCES AT THE PLANNING
OF APPROVAL	BOARD MEETING DATE A	IT WHICH THE PLAN RECIEVES FINAL APPROVAL.


PREPARED FOR/RECORD OWNER

INTEGRA BIOSCIENCES CORP

2 WENTWORTH DRIVE HUDSON, NEW HAMPSHIRE 03051 (603) 578-5800 www.integra-bioscience.com

27 JANUARY 2022

REVISED

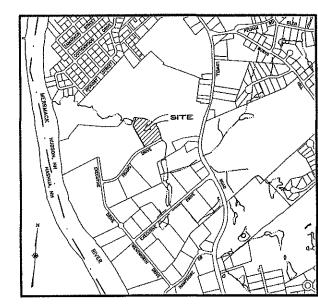

VICINITY PLAN
SCALE: 1" = 1,000'






Civil Engineers/Land Surveyors
3 Congress Street 131 Middlesex Turnpike
Nashua, NH 03062 Burlington, MA 01803
(603) 883-2057 (781) 203-1501

www.hayner-swanson.com



3/1/22



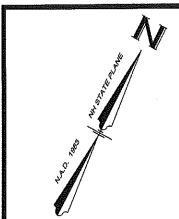

PLAN REFERENCES:

- SUBDIVISION PLAN LAND OF PRESSTEK INC., HUDSON, NH PREPARED FOR PRESSTEK PARK, SCALE; 1*-10° DATED: FEBRUARY 26, 1997 BY TFMORAN INC.
 RECORDED: HORD -PLAN No. 2866.
- SOUTHEASTERN CONTAINER INC. ADDITION No. 2 SUBDIVISION/CONSOLIDATION PLAN SCALE: 1^{∞} 100° DATED: MAY 1, 1994 BY ALLAN H. SWANSON, INC. RECORDED: HCRD-PLAN No. 26916.
- SUBDIVISION PLAN OF LAND OF DIGITAL EQUIPMENT CORPORATION PREPARED FOR PRESSTEKYINDUSTRIAL PLANT SCALE: 11° 100° DATED; JULY 25, 1995 BY TFMORAN INC. RECORDED; HORD-PLAN No. 28159.
- SUBDIVISION PLAN LAND OF PRESSTEK INC, PREPARED FOR PRESSTEK PARK SCALE: 1" =100" DATED: FEBRUARY 28, 1997 BY TFMORAN INC, RECORDED: HCRD-PLAN No. 26965.
- SITE PLAN (MAP 205, LOTS 2.4.3), 27 SHEETS), PARKING LOT ADDITIONS, 55 EXECUTIVE DRIVE & FRINGE DRIVE, HUDSON, NEW HAMPSHIRE, PREPARED FOR: FARLEY WHITE INTERESTS, RECORD OWNER: PRESSTEE, LLC, SCALE: AS SHOWN, DATE DIT MARCH 2014 WITH REVISIONS THRU 0/4/2014 AND PREPARED BY THE OFFICE.
- SITE LAYOUT PLAN, FRIARS COURT, MAP 208 LOT 1 FOR DAKOTA PARTNERS, INC. DATED APRIL 25, 2019 PREPARED BY THE DUBAY GROUP, LLC. RECORDED, NCRO. P PLAN No. 40569
- SUBDIVISION PLAN, FRIARS COURT, MAP 209 LOT 1 FOR DAKOTA PARTNERS, INC. DATED: APRIL 29, 2019 PREPARED BY THE DUBAY GROUP, LLC.
 RECORDED: LORD PLAN IN. 40568
- SITE PLAN, MATRIX TECHNOLOGIES CORPORATION, FRIARS DRIVE, HUDSON NEW HAMPSHIRE, PREPARED BY MAYNARD AND PAQUETTE, INC. DATED: JUNE 28, 1998. RECORDED: HORD PLAN MAYNARD AND PAQUETTE, INC.
- TOWN OF HUDSON PROPOSED EASEMENT ON LANDS OF: PROVINCE OF ST. MARY'S CAPUCHIN FRIARY, HUDSON NN DATED; DECEMBER 8, 1977 RECORDED: HCRO ~ PLAN No. 11023

EASEMENTS, RIGHTS AND RESTRICTIONS:

- THE PROPERTY IS SUBJECT TO TERMS AND CONDITIONS AS SET FORTH IN BK. 5874 PG. 188. THE PROPERTY HAS BENEFICIAL RIGHTS OF STORM DRAINAGE EASEMENT AS DEFINED IN BK. 5974 PG.
- THE PROPERTY IS SUBJECT TO THE 30 FT WIDE SEWER EASEMENT AS DESCRIBED IN 8K 2594, PG 290. THE PROPERTY IS SUBJECT TO THE 10 FT WIDE SEWER EASEMENT AS DESCRIBED IN 8K 2594, PG 290.

 A BIK 5574, PG 168.
- THE PROPERTY IS SUBJECT TO A DEVELOPMENT AGREEMENT WITH THE TOWN OF HUDSON IN BK. 5864 PG. 1554
- THE PROPERTY IS SUBJECT TO THE TEMPORARY EASEMENT FOR PAVED TURNAROUND AS DESCRIBED IN BK 5864, PG 1570 & BK 5674, PG 198.
- THE PROPERTY IS SUBJECT TO A DEVELOPMENT AGREEMENT WITH THE TOWN OF HUDSON AS DEFINED IN BK. 5864 PG. 1577.
- THE PROPERTY IS SUBJECT TO THE LANDSCAPE RIGHTS AND CONDITIONS AS DESCRIBED IN BK 5874, PG 188.
- REVISED WATER LINE EASEMENT LOCATE WITHIN FRIARS DRIVE AS AMENDED BY 8K, 5863 PG, 1430.
- 10. AMENDED SEWER EASEMENT PARTIALLY LOCATED WITHIN FRIARS DRIVE DEFINED IN BK. 5865 PG. 1019.

EASEMENTS, RIGHTS AND RESTRICTIONS LISTED ABOVE OR DEPICTED ON THIS PLAN ARE THOSE THAT EASEMENTS, RIGHTS AND RESTAIN LONG USING ADMOVED OF DETICIOUS OF THE POWER AND AND SECRET WERE FOUND AT THE REGISTRY OF DEEDS FOR THE PURPOSES OF THE DETERMINATION AND LOCATION OF THE PROPERTY LINES OF THE SURVEYED PREMISES, EASEMENTS, RIGHTS AND RESTRICTIONS INCLUDING BUT NOT LIMITED TO LIMINATITE RIGHTS WAY AFFECT THE PROPERTY. THE SURVEYOR MAKES NO BUARANTEE TO TITLE, RIGHTS OR OWNERSHIP OF PROPERTY.

WAIVERS REQUESTED/APPROVED:


SPR 275 - 8c (2) REQUIRED PARKING SPACES SPR 275 - 8c (6) REQUIRED LOADING SPACES

DRIVEWAY SIGHT DISTANCES:

LOOKING WEST - 400+ FT LOOKING EAST - 400+ FT LOOKING WEST - 400+ FT LOOKING EAST - 400+ FT

BUILDING INFORMATION			
USE	EXISTING	PROPOSED	TOTAL
OFFICES	13,242 SF		13,242 SF
MANUFACTURING	7,448 SF	13,437 SF	20,885 SF
WAREHOUSE	11,520 SF	34,340 SF	45,860 \$F
DOCK ADDITION		400 SF	400 SF
TOTAL	32,210 SF	48,177 SF	80,387 SF

APPROVED BY THE HUDSON, NH PLANNING BOARD PURSUANT TO THE SITE REVIEW REGULATIONS OF DATE OF MEETING: THE HUDSON GRANTED HEREIN SITE PLANS ARE VALID FOR TWO (2) YEARS FROM THE DATE OF PLANNING BOARD MEETING FINAL APPROVAL. FINAL APPROVAL COMMENCES AT THE PLANNING BOARD MEETING DATE AT WHICH THE PLAN RECIEVES FINAL APPROVAL. EYRIRES TWO OF APPROVAL

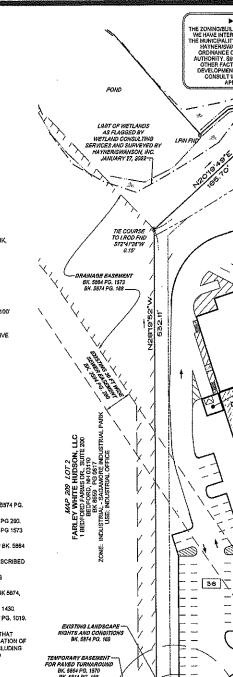

OFT WIDE SEWER

► ZONING NOTE 4

-4-

5 608 ACRES

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THE RESTRICTION OF THE PERSON OF THE PERSON

FRIARS

PERMITS/APPROVALS:

NHDES SEWER CONNECTION PERMIT No. ___

MAP 209 LOT5 HARRY M. HAYTAYAN REVOC. TRUST

NHDES ALTERATION OF TERRAIN PERMIT No. ACT-220207-027, DATED ISSUED:

3⊕

\$61'40'08"W


DRIVE

1/31/2022

DATE

80 FT WIDE

LEGEND

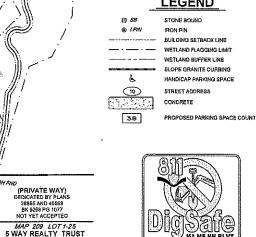

digsafe.com DIAL 811 or 1-888-DIG-SAFE 1-888-344-7233

WALTER FLOWERS PETER W. HORNE, TRUSTEES P.O. BOX 1435
NORTH HAMPTON, NH 03882
BX 9289 PQ 1084
ZONE: GENERAL
USE: VACANT LAND **CERTIFICATION**

PURSUANT TO RSA 676:18 III AND RSA 672:14

I CERTIFY THAT THIS SURVEY PLAT IS NOT A SUBDIVISION PURSUANT TO THIS TITLE AND THAT THE LINES OF STREETS AND WAYS SHOWN ARE THOSE OF PUBLIC OR PRIVATE STREETS OR WAYS ALREADY ESTABLISHED AND THAT NO NEW

FURTHER CERTIFY, TO MY KNOWLEDGE, INFORMATION AND BELIEF, THAT THIS PLAN FFURTHER CERTIFY, TO MY KNOWLEDGE, INFORMATION AND BELIEF, THAT THIS PLAN SHOWS THE RESULTS OF AN ON THE GROUND "STANDARD PROPERTY SURVEY" AND THAT SAID SURVEY MEETS THE MINIMUM PRECISION AND/OR ACCURACY MEASUREMENTS FOR SURVEY CLASSIFICATION "U" (URBAN) AS SET FORTH IN TABLE 600.1 OF THE NEW HAMPSHIRE CODE OF ADMINISTRATIVE RULES OF THE BOARD OF LICENSURE FOR LAND SURVEYORS ADOPTED 08/23/01, EFFECTIVE 01/01/09.

(PRIVATE WAY) DEDICATED BY PLAN 28865 AND 40568

LEURTHER CERTIFY THAT THIS PLAN IS THE RESULT OF AN ACTUAL FIELD SURVEY MADE ON THE GROUND AND HAS A MAXIMUM ERROR OF CLOSURE OF ONE PART IN FIFTEEN THOUSAND ON ALL PROPERTY LINES WITHIN AND BORDERING THE SUBJECT PROPERTY.

NOTES - CONT'D:

PRESENT OWNER OF RECORD-MAP 209 LOT 4 INTEGRA BIOSCIENCES CORP.

> - WETLAND BUFFER MPACT AREA

MAP 209 LOT 1 6 WAY REALTY TRUST

WATTER FLOWERS &
PETER W. HORNE, TRUSTEES
PO BOX 1436
NORTH HAMPTON, NH 03882
EX 6046 PG 1131
ZONE: GENERAL
UGE: VACANT LAND

LIMIT OF WETLANDS

AS FLAGGED BY

WETLAND CONSULTING
SERVICES AND SURVEYED

MAY 10, 2021

IMIT OF WETLANDS

SHEET 1 OF 16 SHALL BE RECORDED AT THE HILLSBOROUGH REGISTRY OF DEEDS. A COMPLETE SET OF PLANS SHALL BE ON FILE WITH THE TOWN OF HUDSON COMMUNITY DEVELOPMENT

TI SHALL BE UNLAWFUL TO MODIFY, CHANGE, OR ALTER ANY STRUCTURE OR USE SHOWN ON THIS SITE PLAN IN ANYWAY WHATSOEVER, OR CONVERT OR ALTER ANY STRUCTURE OR USE SHOWN ON THIS SITE PLAN WITH THE EXCEPTION OF DECKS AND PORCHES PROVIDED THEY CONFORM WITH THE REQUIREMENTS OF THE TOWN OF HUDSON ZONING BY-LAWS, OR CHANGE THE ABOVE USE INDICATED ON THE PLAN WATHOUT RECEIVING APPROVAL FROM THE TOWN OF HUDSON PLANNING BOARD.

TRASH PICK-UP SHALL NOT OCCUR EARLIER THAN 7:00 AM NOR LATER THAN 7:00 PM, MONDAY THRU SATURDAY ONLY.

CONSTRUCTION HOURS ARE MONDAY THRU SATURDAY, 7:00 AM TO 7:00 PM, WITH NO CONSTRUCTION ACTIVITIES OCCURRING ON SUNDAYS. IF LOT DEVELOPMENT INVOLVES BLASTING AND/OR PAMMING OF BEDROCK WATERIALS, SAID ACTIVITIES SHALL BE LIMITED TO THE HOURS OF 7:00 AM AND 5:00 PM, MONDAY THRU FRIDAY ONLY. SAID BLASTING/RAMMING ACTIVITIES SHALL BE PROHIBETED ON SATURDAY'S AND BUNDAY'S.

THE SUBJECT PARCEL IS LOCATED WITHIN AN AREA DESIGNATED AS ZONE "X" AS DETERMINED FROM THE FLOOD INSURANCE RATE MAP, HILLSBOROUGH COUNTY (ALL JURISDICTIONS), PANEL 586 OF 701, 10 WON OF HUBSON, INL, COMMUNITY NO. 330092, PREPARED BY THE FEDERAL EMERGENCY MANAGEMENT AGENCY, MAP NUMBER: 33011 C08580, DATED: SEPTEMBER 25, 2009

PRIOR TO ISSUANCE OF A FINAL CERTIFICATE OF OCCUPANCY A LICENSED LAND SURVEYOR CERTIFIED 'AS-BULL' SITE PLAN SHALL BE PROVIDED TO TOWN OF HUDSON COMMUNITY DEVELOPMENT DEPARTMENT, CONFIRMING THAT THE SITE CONFORMS WITH THE PLANNING BOARD APPROVED BITE PLAN.

SNOW REMOVAL TO BE PLAGED IN OPEN AREAS OF THE SITE AS SHOWN ON SHEET 5 OF 15, IF NEEDED, EXCESS SNOW SHALL BE REMOVED FROM THE SITE AND DISPOSED OF IN A LEGAL MANNER.

THE DEVELOPMENT AGREEMENT FOR THIS PROJECT SHALL BE PLACED ON FILE WITH THE TOWN OF HUDSON PLANNING DEPARTMENT AND RECORDED AT THE HILL SEGROUGH COUNTY REGISTRY OF DEEDS. THE INSPECTION AND MAINTENANCE PLAN FOR STORMWATER SHALL BE INCLUDED IN THE DEVELOPMENT AGREEMENT.


PRIOR TO THE ISSUANCE OF A BUILDING PERMIT, CALCULATIONS SHALL BE PROVIDED TO THE TOWN ENGINEER REGARDING THE EXISTING WATER MAINS IN FRIARS DRIVE HANDLING THE ADDITIONAL DEMAND FROM THE PROPOSED ADDITIONAL DIAMON FROM THE PROPOSED ADDITIONAL.

A CAP FEE IN THE AMOUNT OF \$ ______ SHALL BE PAID PRIOR TO ISSUANCE OF A CERTIFICATE OF OCCUPANCY.

HOURS OF OPERATION: MONDAY - FRIDAY 6:00 AM - 11:30 PM (2 SHIFTS)

THERE ARE NO HIGHWAY PROJECTS LISTED UPON THIS PROPERTY.



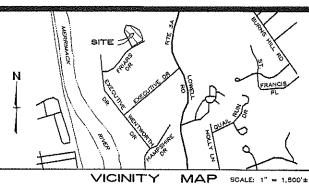

NOTES: LOT AREA: (MAP 209, LOT 4) 6.508 ACRES (244,300 SF) PRESENT ZONING: 1 - INDUSTRIAL MINIMUM LOT REQUIREMENTS: - LOT AREA - LOT FRONTAGE 30,000 SF 150 FT MINIMUM BUILDING SETBACKS REQUIREMENTS
- FRONT YARD 50 FT - FRONT YARD
- SIDE YARD
- REAR YARD
MAXIMUM BUILDING HEIGHT: 15 FT 50 FT LOT NUMBERS REFER TO THE TOWN OF HUDSON ASSESSORS MAP 209. SITE IS CURRENTLY SERVICED BY MUNICIPAL WATER AND MUNICIPAL SEWER, GAS AND OVERHEAD ELECTRIC AND TELECOMMUNICATION UTILITIES. PURPOSE OF PLAN:

TO SHOW PROPOSED BUILDING ADDITIONS ALONG WITH ACCOMPANYING LOADING AND SITE IMPROVEMENTS. REQUIRED: 1 SPACE/600 SF X 80,387 SF (INDUSTRIAL) = 134 SPACES
PROVIDED: (INCLUDES 4 ACCESSIBLE SPACES) = 83 SPACES *
WAIVER REQUESTED

REQUIRED: PROVIDED:

BUILDING HEIGHT: SELI: 32 FT±
EXISTING 2-STORY OFFICE: 32 FT±
PROPOSED 2-STORY MANUFACTURING: 32 FT±
EXISTING WAREHOUSE: 170 BE RAISED TO 50 FT)
PROPOSED WAREHOUSE: 50 FT

SURVEY CONTROL: HORIZONTAL DATUM: NAD83/86* PROJECTION: NH STATE PLANE VERTICAL DATUM: NGVD29* SCALE FACTOR APPLIED: 1.000000 UNITS: US SURVEY FEET

* VERTICAL AND HORIZONTAL DATUM WAS VERIFIED USING GPS (KEYNET NETWORK) BY TAKING OBSERVATIONS ON SITE AND ON NGS (FORMERLY USOS) 'DISK D-25' LOCATED ON THE NORTHERLY SIDE OF RTE 101A APPROXIMATELY 4.5 MILES WEST OF THE NASHUA LIBRARY.

- ALL SIGNS ARE SUBJECT TO APPROVAL BY THE HUDSON PLANNING BOARD PRIOR TO THE INSTALLATION THEREOF.
- SITE IMPROVEMENTS DEPICTED ON THE PLAN SHALL CONFORM WITH TITLE III OF THE AMERICANS WITH DISABILITIES ACT (LATEST EDITION).
- SITE LIGHTING SHALL BE SHOWN ON THE PLAN, DIRECTED ONTO THE SITE, AND SHALL CONFORM WITH ALL APPLICABLE TOWN OF HUDSON ZONING REGULATIONS.

03/08/22 ADDRESS TOWN, PEER REVIEW COMMENTS

MASTER SITE PLAN (MAP 209, LOT 4)

PROPOSED BUILDING ADDITIONS 22 FRIARS DRIVE

HUDSON, NEW HAMPSHIRE

PREPARED FOR/RECORD OWNER:

INTEGRA BIOSCIENCES CORP.

WENTWORTH DRIVE HUDSON, NEW HAMPSHIRE 03051 (603) 578-5800

200 FEET


27 JANUARY 2022



Civil Engineets/Lend Surveyors

J Congress Street
Nashue, NH 03062
Street
Nashue, NH 03062
Street
St

ORANING NAME: 5734 SITE-FOST TELD BOOK: 1234 5734 1 OF 15 MNG LOC: J. \5000\5734\DWG\5734 SITE 2021

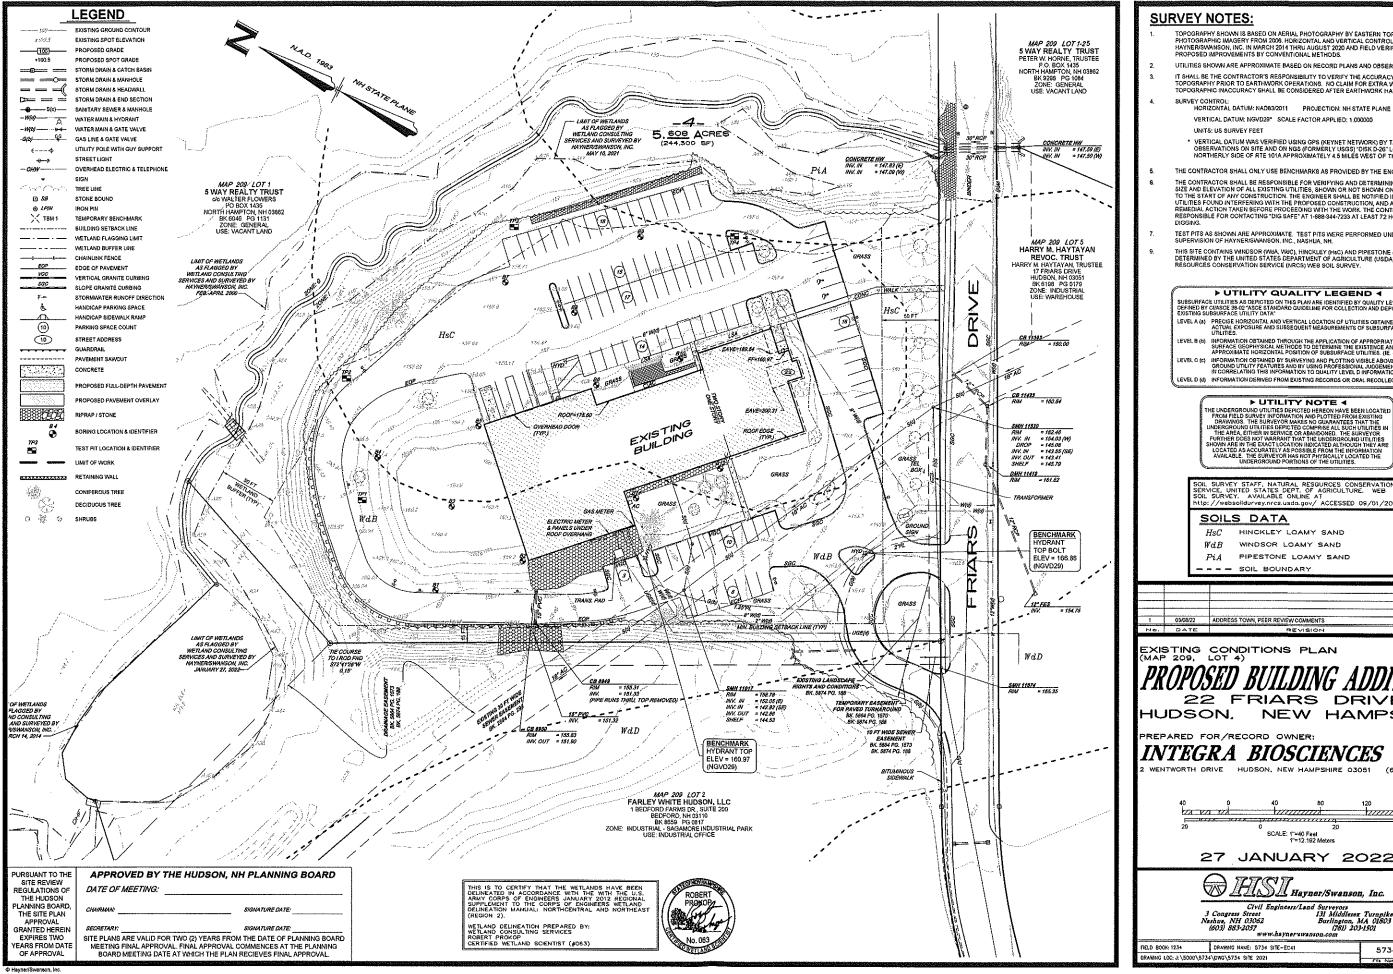

- TOPOGRAPHY SHOWN IS BASED ON AERIAL PHOTOGRAPHY BY EASTERN TOPOGRAPHIC USING PHOTOGRAPHIC IMAGERY FROM 2006. HORIZONTAL AND VERTICAL CONTROLLED BY HAYNER/SWANSON, INC. IN MARCH 2014 THRU JACUST 200 AND FIELD VERIFIED IN AREAS OF PROPOSED IMPROVEMENTS BY CONVENTIONAL METHODS.
 - UTILITIES SHOWN ARE APPROXIMATE BASED ON RECORD PLANS AND OBSERVED EVIDENCE.
- IT SHALL BE THE CONTRACTOR'S RESPONSIBILITY TO VERIFY THE ACCURACY OF THE EXISTING TOPOGRAPHY PRIOR TO EARTHWORK OPERATIONS. NO CLAIM FOR EXTRA WORK DUE TO TOPOGRAPHIC INACCURACY SHALL BE CONSIDERED AFTER EARTHWORK HAS COMMENCED.

VERTICAL DATUM: NGVD29* SCALE FACTOR APPLIED: 1.000000

- VERTICAL DATUM WAS VERIFIED USING GPS (KEYNET NETWORK) BY TAKING OBSERVATIONS ON SITE AND ON NGS (FORMERLY USGS) "DISK D-26" LOCATED ON THE NORTHERLY SIDE OF RTE 101A APPROXIMATELY 4.5 MILES WEST OF THE NASHUA LIBRARY.
- THE CONTRACTOR SHALL ONLY USE BENCHMARKS AS PROVIDED BY THE ENGINEER.
- THE CONTRACTOR SHALL BE RESPONSIBLE FOR VERIFYING AND DETERMINING THE LOCATION. THE CONTRACTOR SHALL BE RESPONSIBLE FOR VERIFYING AND DETERMINING THE LOCATION, SIZE AND ELEVATION OF ALL EXISTING UTILITIES, SHOWN OR NOT SHOWN ON THESE PLANS, PRIOR TO THE START OF ANY CONSTRUCTION. THE ENGINEER SHALL BE NOTIFIED IN WARTING OF ANY UTILITIES FOUND INTERFERING WITH THE PROPOSED CONSTRUCTION, AND APPROPRIATE REMEDIAL ACTION TAKEN SEFORE PROCEEDING WITH THE WORK. THE CONTRACTOR SHALL BE RESPONSIBLE FOR CONTACTING "DIG SAFE" AT 1-888-344-7233 AT LEAST 72 HOURS BEFORE DIGGING.
- TEST PITS AS SHOWN ARE APPROXIMATE. TEST PITS WERE PERFORMED UNDER THE SUPERVISION OF HAYNER/SWANSON, INC., NASHUA, NH.
- THIS SITE CONTAINS WINDSOR (MMA, WMC), HINCKLEY (HMC) AND PIPESTONE (PIA) SOILS AS DETERMINED BY THE UNITED STATES DEPARTMENT OF AGRICULTURE (USDA) NATURAL RESOURCES CONSERVATION SERVICE (NRCS) WEB SOIL SURVEY.

▶ UTILITY QUALITY LEGEND ◀

SUBSURFACE UTILITIES AS DEPICTED ON THIS PLAN ARE IDENTIFIED BY QUALITY LEVELS DEFINED BY CUASCE 38-02 "ASCE STANDARD GUIDELINE FOR COLLECTION AND DEPICTION OF EXISTING SUBSURFACE UTILITY DATA"

PRECISE HORZONTAL AND VERTICAL LOCATION OF UTILITIES GETAINED BY ACTUAL EXPOSURE AND SUBSEQUENT MEASUREMENTS OF SUBSURFACE UTILITIES.

UTILITIES.

INFORMATION OBTAINED THROUGH THE APPLICATION OF APPROPRIATE SUFFACE GEOPHYSICAL METHODS TO DETERMINE THE EXISTENCE AND APPROXIMATE HORIZONTAL POSITION OF SUBSUPFACE UTILITIES (IE DIG PROGRAMATION OSTAINED BY SURVEYING AND PLOTTING VISIBLE ABOVER-COOLINITY FEATURES AND BY USING POPESSIONAL JUGGEMENT IN CORRELATING THIS INFORMATION TO QUALITY LEVEL D INFORMATION. LEVEL D (d) INFORMATION DERIVED FROM EXISTING RECORDS OR ORAL RECOLLECTIONS

SOIL SURVEY STAFF, NATURAL RESQURCES CONSERVATIO SERVICE, UNITED STATES DEPT. OF AGRICULTURE. WEB SOIL SURVEY. AVAILABLE ONLINE AT ttp://websolidurvey.nrcs.usda.gov/ ACCESSED 09/01/20

SOILS DATA

HSC HINCKLEY LOAMY SAND WdB WINDSOR LOAMY SAND

PiA PIPESTONE LOAMY SAND


EXISTING CONDITIONS PLAN (MAP 209, LOT 4) PROPOSED BUILDING ADDITIONS 22 FRIARS DRIVE

HUDSON, NEW HAMPSHIRE

PREPARED FOR/RECORD OWNER:

INTEGRA BIOSCIENCES CORP.

WENTWORTH DRIVE HUDSON, NEW HAMPSHIRE 03051 (603) 578-5800

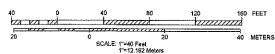


27 JANUARY 2022



Civil Engineers/Land Surveyors Street 131 Middlesex Turnpike 1 03062 Burlington, MA 01803 -2057 (781) 203-1501 3 Congress Street
Nashus, NH 03062
Builing
(603) 883-2057
www.hayner-wanson.com

DRAWING NAME: 5734 SITE-EC41 5734 2 OF 15 WING LOC: £\5000\5734\DWG\5734 SITE 2021

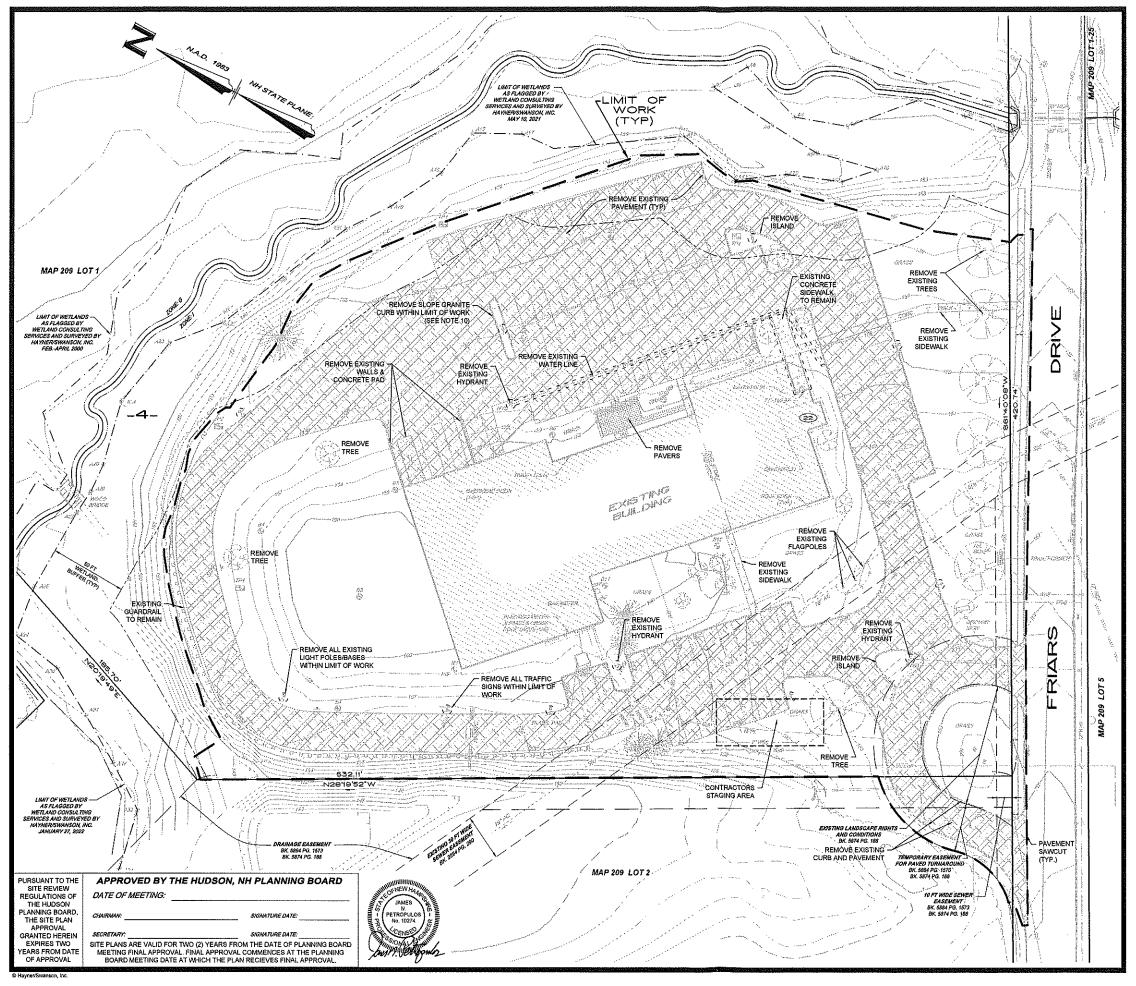

SITE DEMOLITION NOTES:

- THE CONTRACTOR IS RESPONSIBLE FOR THE DEMOLITION, REMOVAL, AND DISPOSAL IN A LOCATION APPROVED BY ALL GOVERNING AUTHORITIES, OF ALL STRUCTURES, PADS, WALLS, FOUNDATIONS, PARKING, DRIVES, DRIANGE, STRUCTURES, UTILITIES, ETC., SUCH THAT THE IMPROVEMENTS SHOWN ON THE REMAINING PLANS CAN BE CONSTRUCTED. ALL FACILITIES TO BE REMOVED SHALL BE UNDERCUT TO SUITABLE MATERIAL AND BROUGHT TO GRADE WITH SUITABLE COMPACTED FILL MATERIAL PER THE GEOTECHNICAL SPECIFICATIONS.
- THE CONTRACTOR IS RESPONSIBLE FOR REMOVING ALL DEBRIS FROM THE SIYE AND DISPOSING THE DEBRIS IN A LAWFUL MANNER. THE CONTRACTOR IS RESPONSIBLE FOR OBTAINING ALL PERMITS REQUIRED FOR SIYE DEMOLITION AND DISPOSAL.
- THE CONTRACTOR SHALL COORDINATE WITH RESPECTIVE UTILITY COMPANIES PRIOR TO THE REMOVAL AND/OR RELOCATION OF UTILITIES. THE CONTRACTOR SHALL COORDINATE WITH THE UTILITY COMPANY CONCERNING PORTIONS OF WORK WHICH MAY BE PERFORMED BY THE UTILITY COMPANY'S FORCES AND ANY FEES WHICH ARE TO BE PAID TO THE UTILITY COMPANY'S FORCES. THE CONTRACTOR IS RESPONSIBLE FOR PAYING ALL FEES AND CHARGES.
- THE LOCATIONS OF ALL EXISTING UTILITIES SHOWN ON THIS PLAN HAVE BEEN DETERMINED FROM THE BEST INFORMATION AVAILABLE AND ARE GIVEN FOR THE CONVENIENCE OF THE CONTRACTOR. THE ENGINEER ASSUMES NO RESPONSIBILITY FOR THEIR ACCURACY. PRIOR TO THE START OF ANY DEMOLITION ACTIVITY. THE CONTRACTOR SHALL NOTIFY THE UTILITY COMPANIES FOR ON SITE LOCATIONS OF EXISTING UTILITIES.
- ALL EXISTING SEWERS, PIPING AND UTILITIES SHOWN ARE NOT TO BE INTERPRETED AS THE EXACT LOCATION, OR AS THE ONLY OBSTACLES THAT MAY OCCUR ON THE SITE. THE CONTRACTOR SHALL VERIFY EXISTING CONDITIONS AND PROCEED WITH CAUTION AROUND ANY ANTICIPATED FEATURES. THE CONTRACTOR SHALL GIVE NOTICE TO ALL UTILITY COMPANIES REGARDING DESTRUCTION AND REMOVAL OF ALL SERVICE LINES AND CAP ALL LINES BEFORE PROCEEDING WITH THE WORK.
- EIECTRICAL, TELEPHONE, CABIE, WATER, FIBER OPTIC CABLE AND/OR GAS LINES NEEDING TO BE REMOYED OR RELOCATED SHALL BE COORDINATED WITH THE AFFECTED UTILITY COMPANY. ADEQUATE TIME SHALL BE PROVIDED FOR RELOCATION AND CLOSE COORDINATION WITH THE UTILITY COMPANY IS NECESSARY TO PROVIDE A SMOOTH TRANSITION IN UTILITY SERVICE. THE CONTRACTOR SHALL PAY CLOSE ATTENTION TO EXISTING UTILITIES WITHIN THE ROAD RIGHT OF WAY DURING CONSTRUCTION.
- PRIOR TO SITE DEMOLITION OCCURRING, ALL APPROPRIATE EROSION CONTROL DEVICES ARE TO BE INSTALLED.
- THE CONTRACTOR SHALL BE RESPONSIBLE FOR NOTIFYING THE YOWN OF HUDSON PRIOR TO THE START OF DEMOLITION OR CONSTRUCTION. A DEMOLITION APPROVA, PERMIT SHALL BE OBTAINED FORM THE TOWN OF HUDSON PRIOR TO THE ANY BUILDING DEMOLITION.
- FOR WORK WITHIN A PUBLIC STREET THE CONTRACTOR SHALL SUBMIT A TRAFFIC CONTROL PLAN TO THE TOWN ENGINEERING DEPARTMENT.
- THE CONTRACTOR SHALL REMOVE AND STOCKPILE EXISTING SLOPE AND VERTICAL GRANITE CURB IN A LOCATION PROVIDED BY THE COWNER'S REPRESENTATIVE. CURB THAT IS IN GOOD CONDITION AND ACCEPTABLE TO THE COWNER'S REPRESENTATIVE MAY BE REUSED IN LOCATIONS SHOWN ON THE SITE GRADING & UTILITY PLAN, SURPLUS OR UNACCEPTABLE CURB SHALL BECOME THE PROPERTY OF THE CONTRACTOR AND SHALL BE REMOVED FROM THE PROPERTY.



			-
1	03/08/22	ADDRESS TOWN, PEER REVIEW COMMENTS	JNF
70.	DATE	REVISION	9.


SITE DEMOLITION PLAN (MAP 209, LOT 4) PROPOSED BUILDING ADDITIONS 22 FRIARS DRIVE

HUDSON, NEW HAMPSHIRE

REPARED FOR/RECORD OWNER:

INTEGRA BIOSCIENCES CORP.

WENTWORTH DRIVE HUDSON, NEW HAMPSHIRE 03051 (603) 578-5800

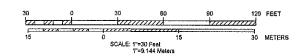

27 JANUARY 2022




Civil Engineers/Land Surveyors

Street 131 Middlesex Turnpike

4 03062 Burlington, MA 01803 3 Congress Street Nashua, NH 03062 (603) 883-2057

DRAWING NAME: 5734 SITE-DM31 FIELD BOOK: 1234 5734 3 OF 15 WING LOC: #\5000\5734\DWG\5734 SITE 2021

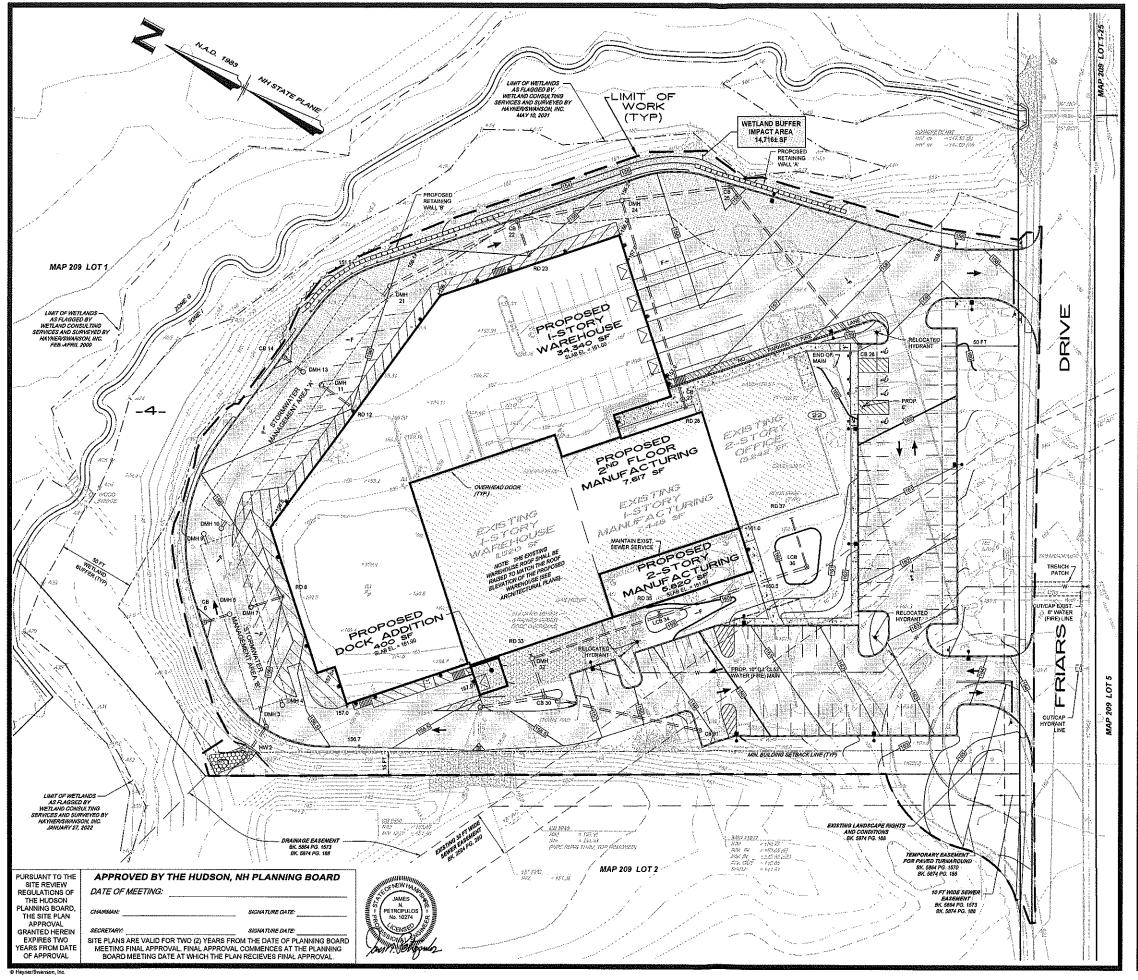

CONSTRUCTION NOTES:

- ALL WORK SHALL CONFORM TO THE APPLICABLE REGULATIONS AND STANDARDS OF THE TOWN OF HUDSON, AND SHALL BE BUILT IN A WORKMANLIKE MANNER IN ACCORDANCE WITH THE PLANS AND SPECIFICATIONS. THE STANDARD SPECIFICATIONS FOR ROAD AND BRIDDE CONSTRUCTION, STATE OF NEW HAMPSHIRE, DEPARTMENT OF TRANSPORTATION, LATEST ADDITION, ARE HEREBY INCORPORATE BUY REFERENCE.
- ROAD AND DRAINAGE CONSTRUCTION SHALL CONFORM TO THE TYPICAL SECTIONS AND DETAILS SHOWN ON THE PLANS, AND SHALL MEET THE REQUIREMENTS AND SPECIFICATIONS FOR ROAD CONSTRUCTION, PUBLIC WORKS DETT, HUDGON, NEW HAMPSHIRE, ALL DRAINAGE PIPES SHALL BE ADS N-12 (SOIL TIGHT). CATCH BASINS SHALL BE TYPED, AND HAVE 3 FT SUMPS UNLESS OTHERWINS
- THE CONTRACTOR SHALL BE RESPONSIBLE FOR VERIFYING AND DETERMINING THE LOCATION, SIZE AND ELEVATION OF ALL EXISTING UTILITIES, SHOWN OR NOT SHOWN ON THESE PLANS, PRIOR TO THE START OF ANY CONSTRUCTION. THE ENGINEER SHALL BE NOTIFIED IN WITHING OF ANY UTILITIES FOUND INTERFERING WITH THE PROPOSED CONSTRUCTION, AND APPROPRIATE REMEDIAL ACTION TAKEN BEFORE PROCEEDING WITH THE WORK, THE CONTRACTOR SHALL BE RESPONSIBLE FOR CONTACTING "DIG SAFE" AT 1-888-344-7233 AT LEAST 72 HOURS BEFORE DIGGING
- WATER (DOMESTIC), SANITARY SEWER, GAS, ELECTRIC AND TELECOMMUNICATION UTILITIES SHALL BE EXTENDED FROM THE EXISTING BUILDING TO THE PROPOSED ADDITIONS.
- EROSION AND SEDIMENT CONTROL MEASURES SHALL BE IN PLACE AND MAINTAINED THROUGH THE CONSTRUCTION PROCESS UNTIL STABILIZATION OCCURS.
- STUMPS SHALL BE DISPOSED OF OFF-SITE IN A LEGAL MANNER.
- DIMENSIONS TO CURB AND GUTTERS INDICATE EDGE OF PAYING UNLESS OTHERWISE NOTED.
- EXISTING PAVEMENT SHALL SE SAW-CUT AS NECESSARY. CONTRACTOR SHALL ENSURE A SMOOTH TRANSITION BETWEEN NEW AND EXISTING PAVEMENT.
- AN ONSITE PRE-CONSTRUCTION MEETING SHALL BE HELD WITH THE TOWN ENGINEER OR DESIGNATED REPRESENTATIVE PRIOR TO INITIATING EARTH MOVING ACTIVITIES AND AFTER PERMIETER REGISION CONTROL MEASURES, PROTECTIVE FENCING, WASTE DISPOSAL AND CONSTRUCTION ACCESS PADS HAVE BEEN INSTALLED.
- THE CONTRACTOR SHALL BE RESPONSIBLE FOR CONTROLLING, CONTAINING AND DULY REMOVING ALL CONSTITUENTS OF CONCERN BROUGHT TO THE SITE BY CONTRACTOR, SUBCONTRACTORS, SUPPLIERS OR ANYONE ELSE FOR WHOM CONTRACTOR IS RESPONSIBLE, AND FOR ANY ASSOCIATE OCSTS, AND FOR THE COSTS OF REMOVING AND REMEDIATING ANY HAZARDOUS ENVIRONMENTAL CONDITION CREATE BY THE PRESENCE OF ANY SUCH CONSTITUENTS OF CONCERN.
- THE CONTRACTOR SHALL NOT IMPORT ANY FILL OVER THE AMOUNT OF TEN CUBIC YARDS CUMULATIVE TOTAL PER SOURCE TO ANY JOB SITE IN THE TOWN OF HUDGON WITHOUT SOILS TESTING YERFYING THE ABSENCE OF ALL CONSTITUENTS OF CONCERN, AND WITHOUT PRIOR APPROVAL BY ENGINEERING DEPARTMENT STAFF, DOCUMENTATION SUCH AS TEST REPORTS, CERTIFICATIONS AND SIEVE ANALYSES OF FILL SHALL BE PROVIDED TO THE ENGINEERING DEPARTMENT FOR APPROVAL PRIOR TO TRANSPORTING THE MATERIAL TO HUDGON.

TOWN OF HUDSON CONTACTS UTILITY CONTACTS

HUDSON PLANNING DEPT

ENGINEERING DEPARTMENT

HUDSON ENGINEERING DEPT. 12 SCHOOL STREET HUDSON, NH 03051

ATT: ELVIS DHIMA, P.E. TOWN ENGINEER (503) 886-6008

FIRE DEPARTMENT

ATT: ROBERT BUXTON, FIRE CHIEF (609) 886-6021

GAS.

S: LIBERTY UTILITIES 130 ELM STREET MANCHESTER, NH 03103 ATT: ANDREW MORGAN (603) 327-5357

TELEPHONE: CONSOLIDATED COMMUNICATIONS 257 DANIEL WEBSTER HIGHWAY MERRIMACK, NH 03054 ATT: HEATHER ARUJUO (603) 296-5998

POWER:

EVERSOURCE 370 AMHERST STREET NASHUA, NH 03060 ATT: MARC GAGNON (603) 882-5894


SITE GRADING & UTILITY PLAN PROPOSED BUILDING ADDITIONS

22 FRIARS DRIVE HUDSON, NEW HAMPSHIRE

PREPARED FOR/RECORD OWNER:

INTEGRA BIOSCIENCES CORP.

WENTWORTH DRIVE HUDSON, NEW HAMPSHIRE 03051 (603) 578-5800

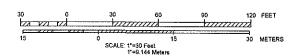



27 JANUARY 2022



Civil Engineers/Land Surveyors Street 131 Middlesox Turnpike 03062 Burlington, MA 01803 2057 (781) 203-1501 3 Congress Street Nashua, NH 03062 (603) 883-2057

FIELD 800K: 1234 DRAWING NAME: 5734 SITE-FG31 5734 4 OF 15

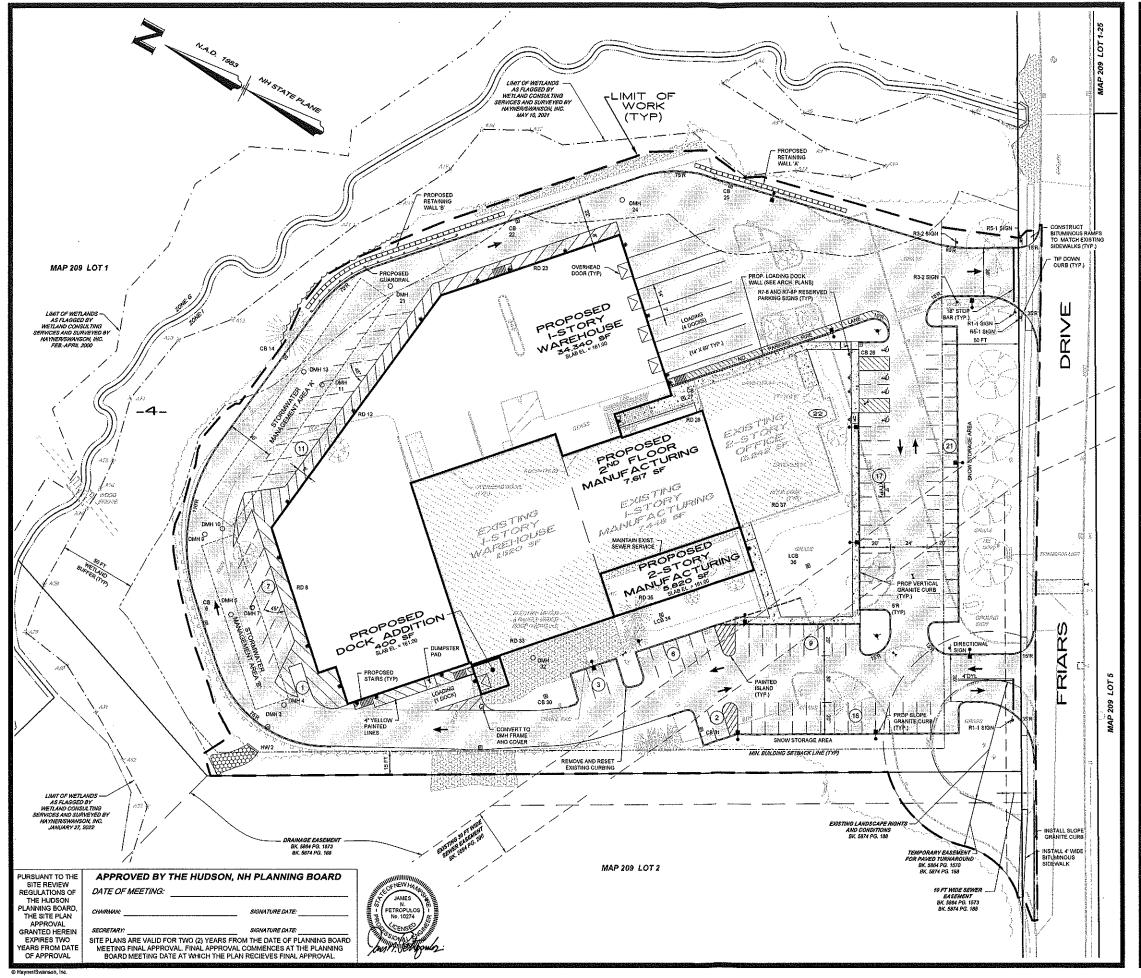

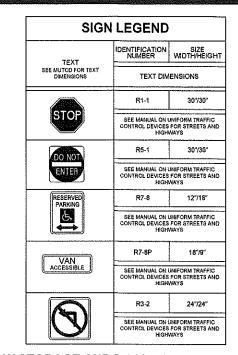

SNOW STORAGE AND DE-ICING PLAN:

- PRIOR TO FIRST STORM, ESTABLISH PLOWING SCHEDULE AND REVIEW PROPOSED MATERIALS FOR TREATMENT OF ICE/SNOW CONDITIONS.
- CONDUCT SITE VISIT TO CONFIRM SNOW STORAGE AREAS CONSISTENT WITH APPROVED SITE PLAN
- CALCIUM CHLORIDE, SAND AND NON-TOXIC ADDITIVES PRE-APPROVED BY INTEGRA WILL BE APPLIED.
- USE OF GLYCOL-CONTAINING DE-ICING PRODUCTS IS PROHIBITED.
- USE OF SODIUM CHLORIDE (AKA ROCK SALT) AND/OR SODIUM CHLORIDE BLENDS ARE PROHIBITED.
- MATERIALS ARE TO BE APPLIED TO IMPERVIOUS SURFACES ONLY; LANDSCAPING AND GRASSED AREAS ARE TO BE AVOIDED.
- PLOW LOGS TO RECORD DATE/TIME AND WORK PERFORMED WILL BE MAINTAINED BY THE CONTRACTOR AND PROVIDED TO INTEGRA. SNOW STORAGE AREAS WILL BE MONITORED; WHEN SIZE OR HEIGHT BECOMES AN ISSUE SNOW WILL BE REMOVED FROM THE SITE AS DIRECTED BY INTEGRA.
- DEPENDENT ON THE FORECAST AND IF EXTENDED COLD WEATHER OR SNOW IS ANTICIPATED, CONTRACTOR WILL PRETREAT ALL DRIVEWAYS AND SIDEWALKS PRIOR TO A STORM, AS NEEDED.
- SAND MAY BE APPLIED BY HAND, SIDEWALK SPREADER OR TRUCK SPREADER, TO PROVIDE ADDITIONAL TRACTION.

- AT NO TIME SHALL SNOW BE PLOWED TO OR STOCKPILED IN THE WETLAND BUFFER LOCATED ALONG THE NORTHERN AND EASTERN PORTION OF THE PROPERTY.

1	03/08/22	ADDRESS TOWN, PEER REVIEW COMMENTS	JNP
No.	DATE	REVISION	BY


PROPOSED BUILDING ADDITIONS 22 FRIARS DRIVE

HUDSON, NEW HAMPSHIRE

PREPARED FOR /RECORD OWNER:

INTEGRA BIOSCIENCES CORP.

WENTWORTH DRIVE HUDSON, NEW HAMPSHIRE 03051 (603) 578-5800

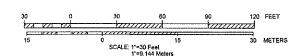



27 JANUARY 2022



Civil Engineers/Land Surveyors J J Congress Street 131 Middlesex Turnpike Nashus, NH 03062 Burlington, MA 01803 (603) 883-2057 (781) 203-1501

DRAWING NAME: 5734 SITE-FQ31 FIELD BOOK: 1234 5 OF 15 5734 DRAWING LOC: J: \5000\5734\DWG\5734 SITE 2021

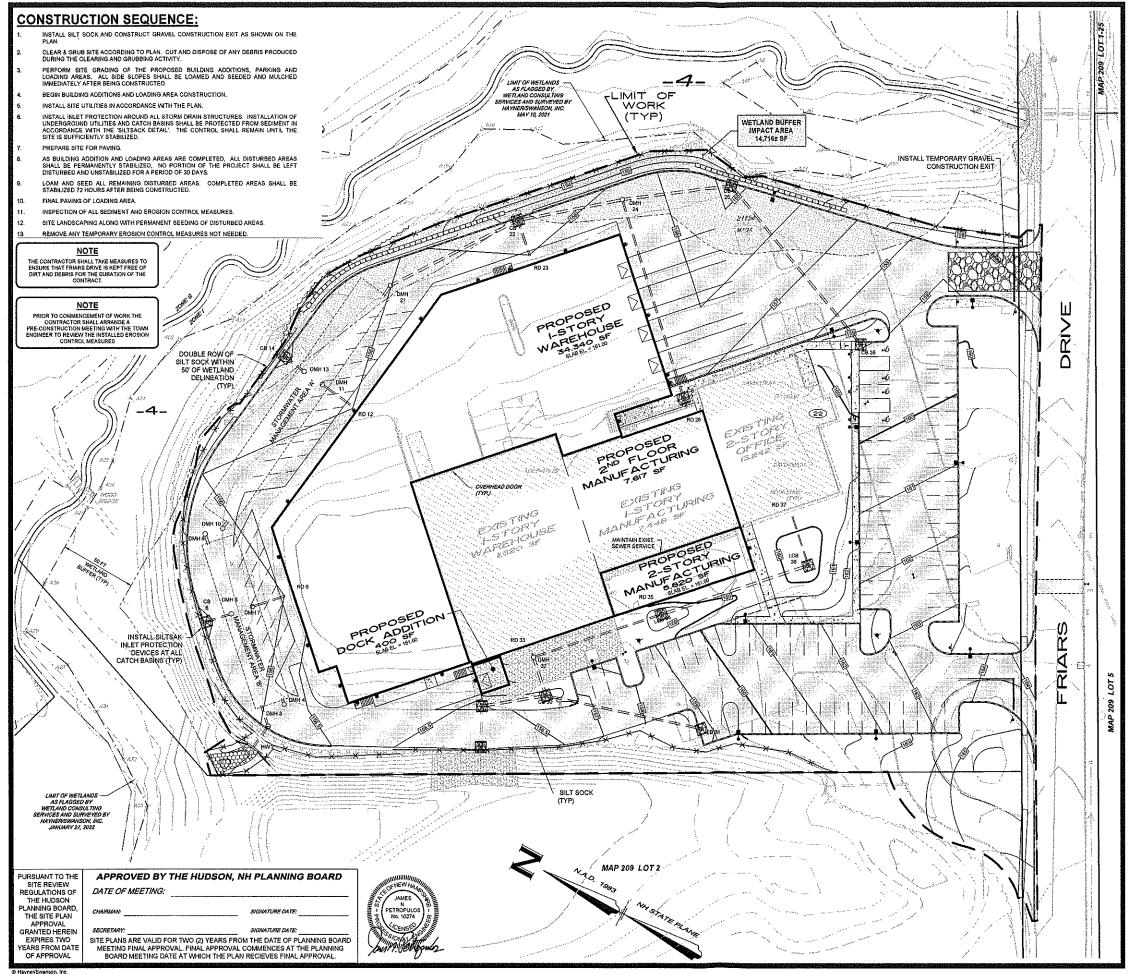

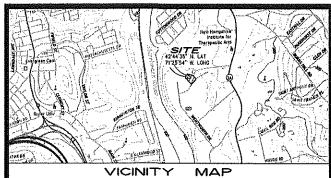

GENERAL NOTES:

ALL CONTRACTORS AND SUBCONTRACTORS INVOLVED WITH THE PROJECT SHALL OBTAIN A COPY OF THE STORMWATER POLLUTION PREVENTION PLAN (SWPPP) AND THE NATIONAL POLLUTION DISCHARGE ELIMINATION SYSTEM GENERAL PERMIT (NPDES PERMIT) AND SHALL COMPLY WITH THE TERMS OF SWPPP AND NPDES PERMIT.

- THE CONTRACTOR SHALL IMPLEMENT BEST MANAGEMENT PRACTICES AS REQUIRED BY THE SWPPP. ADDITIONAL BEST MANAGEMENT PRACTICES SHALL BE IMPLEMENTED AS DICTATED BY SITE CONDITIONS AT NO ADDITIONAL COST OF OWNER THROUGHOUT ALL PHASES OF CONSTRUCTION.
- BEST MANAGEMENT PRACTICES (BMPS) AND CONTROLS SHALL CONFORM TO FEDERAL, STATE, OR LOCAL REQUIREMENTS OR MANUAL OF PRACTICE, AS APPLICABLE, CONTRACTOR SHALL IMPLEMENT ADDITIONAL CONTROLS AS DIRECTED BY PERMITTING AGENCY OR OWNER.
- STOCKPILE AREAS SHALL BE SURROUNDED BY SILT SOCK AND RE-SEEDED IF THEY ARE LEFT UNTOUCHED FOR MORE THAN FOURTEEN (14) DAYS.
- ONTOUTED FOR MORE THAN FOURTEEN (A) DAYS.

 ALL MEASURES STATED ON THIS EROSION CONTROL PLAN, AND IN THE STORMWATER POLLUTION PREVENTION PLAN, SHALL BE MAINTAINED IN FULLY FUNCTIONAL CONDITION UNTIL NO LONGER REQUIRED FOR A COMPLETE PHASE OF WORK OR FINAL STABILIZATION OF THE SITE. ALL EROSION CONTROL MEASURES SHALL BE CHECKED BY A QUALIFIED PERSON IN ACCORDANCE WITH THE CONTRACT DOCUMENTS OR THE APPLICABLE PERMIT, WHICHEVER IS MORE STRINGENT.
- SILT SOCK SHALL BE REPAIRED TO THEIR ORIGINAL CONDITIONS IF DAMAGED
- INLET PROTECTION DEVICES AND BARRIERS SHALL BE REPAIRED OR REPLACED IF THEY SHOW SIGNS OF UNDERMINING OR DETERIORATION.
- ALL SEEDED AREAS SHALL BE CHECK REGULARLY TO SEE THAT A GOOD STAND IS MAINTAINED. AREAS SHOULD BE FERTILIZED, WATERED AND RESEEDED AS NEEDED.
- THE CONSTRUCTION EXIT SHALL BE MAINTAINED IN A CONDITION WHICH WILL PREVENT TRACKING OR FLOW OF MIDD ONTO PUBLIC RIGHT-OF WAY. THIS MAY REQUIRE PERIODIC TOP DRESSING OF THE CONSTRUCTION EXIT AS CONDITIONS DEMAND.
- THE TOWN OF HUDSON RESERVES THE RIGHT TO REQUIRE ADDITIONAL EROSION CONTROL MEASURES DURING CONSTRUCTION IF NEEDED.
- DISTURBED SOIL AREAS THAT WILL REMAIN DIE FOR MORE THAN 30 DAYS SHALL BE TEMPORARILY STABILIZED AS SCON AS PRACTICABLE BUT NO LATER THAN 50 DAYS FROM THE INITIAL DISTURBANCE WITH SEED AND MULCH. FROSION CONTROL BLANKETS OR CRUSHED STOME OR OTHER SUITABLE MEASURES APPROVED BY THE TOWN ENGINEER OR DESIGNATED REPRESENTATIVE. ALL DISTURBED SOIL AREAS THAT HAVE ACHIEVED FINAL GRADING SHALL BE PERMANENTLY STABILIZED WITHIN 3 DAYS FOLLOWING FINAL GRADING.

LEGEND

EXISTING GROUND CONTOUR PROPOSED GRADE RUNOFF DIRECTION

SILT SOCK PERIMETER BARRIER \Diamond SILT-SACK INLET PROTECTION DEVICES

GRAVEL CONSTRUCTION FXIT

TEMPORARY STONE CHECK DAM 888

1 03/08/22 ADDRESS TOWN, PEER REVIEW COMMENTS

EROSION CONTROL PLAN (MAP 209, LOT 4)


PROPOSED BUILDING ADDITIONS 22 FRIARS DRIVE

HUDSON, NEW HAMPSHIRE

PREPARED FOR /RECORD OWNER:

INTEGRA BIOSCIENCES CORP.

WENTWORTH DRIVE HUDSON, NEW HAMPSHIRE 03051 (603) 578-5800

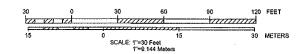


27 JANUARY 2022





Civil Engineers/Land Surveyors


3 Congress Street 131 Middlesex Turnpike
Nashua, NH 03062 Burlington, MA 01803
(603) 883-2057 (781) 203-1501 www.havoarawanson.com


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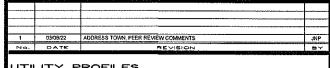


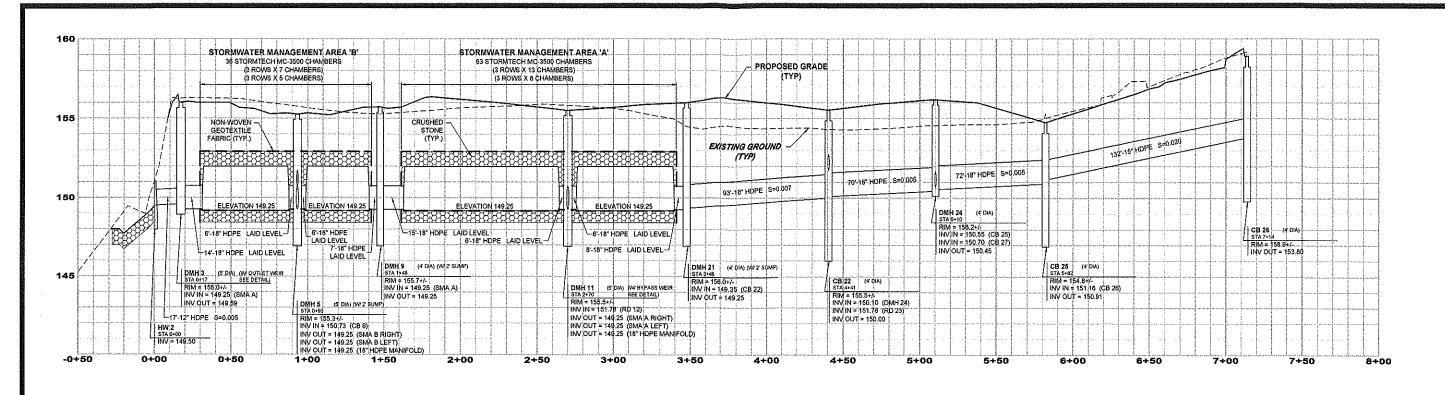

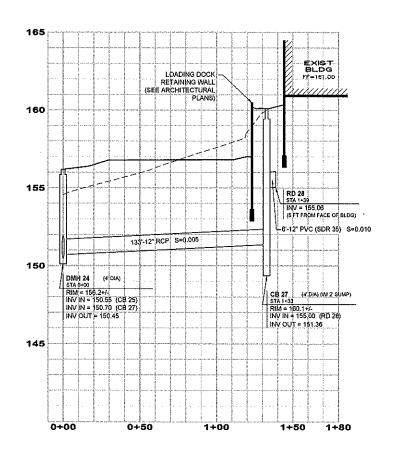

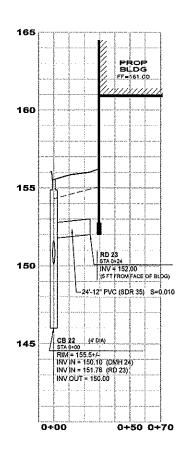NOTES

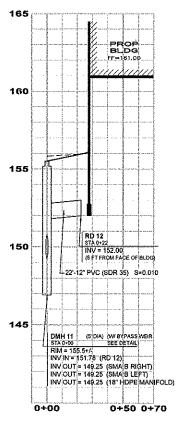- STRUCTURE DIAMETERS AS SHOWN ON DRAINAGE PROFILES ARE CONSIDERED TO BE MINIMUM RISIDE DIMENSIONS, ALL STRUCTURES SHALL BE A MINIMUM RISIDE DIAMETER OF 48" UNLESS OTHERWISE INDICATED. LARGER STRUCTURES MAY BE NECESSARY DUE TO ALIGNMENT AND/OR PIPE SIZES. STRUCTURE MANUFACTURER SHALL DETERMINE FIRMAL SIZE.
- 2. PIPE LENGTHS ARE MEASURED FROM CENTERLINE OF STRUCTURE TO CENTERLINE OF STRUCTURI
- 3. EXTERIOR FOUNDATION WALLS AND FOOTINGS AS SHOWN ARE APPROXIMATE.
- 4. VERTICAL DATUM IS NGVD29 (SEE NOTE 4 ON SHEET 2).
- 5. SEE SHEET 11 OF 15 FOR ADDITIONAL STORMWATER MANAGEMENT AREA INFORMATION.

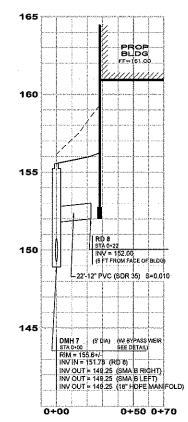

UTILITY PROFILES (MAP 209, LOT 4)


PROPOSED BUILDING ADDITIONS 22 FRIARS DRIVE

HUDSON, NEW HAMPSHIRE

PREPARED FOR/RECORD OWNER:

INTEGRA BIOSCIENCES CORP.

2 WENTWORTH DRIVE HUDSON, NEW HAMPSHIRE 03051 (603) 578-5800

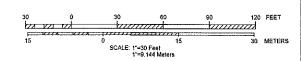

27 JANUARY 2022



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FELD BOOK: 1234 DRAWING NAME: 5734 SITE-FY21 5734 7 OF 15

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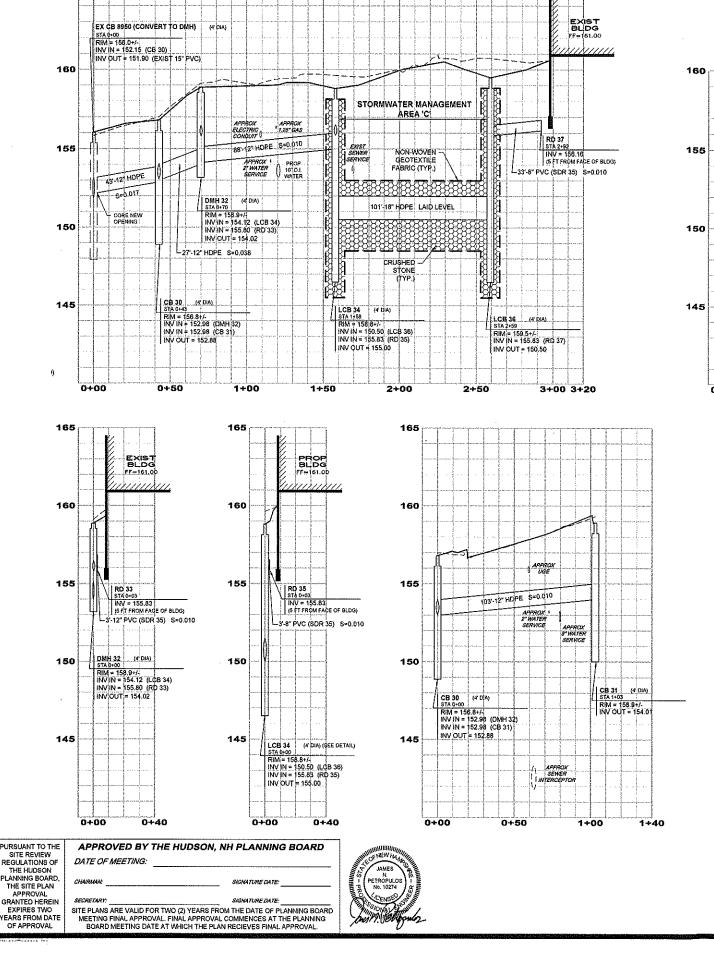
PURSUANT TO THE SITE REVIEW REGULATIONS OF THE HUDSON DATE OF MEETING:


THE SITE PLAN
APPROVAL
GRANTED HEREIN
EXPIRES TWO
(EARS FROM DATE
OF APPROVAL


CHAIRMAN: SIGNATURE DATE:
SECRETARY: SIGNATURE DATE:

SITE PLANS ARE VALID FOR TWO (2) YEARS FROM THE DATE OF PLANNING BOARD MEETING FINAL APPROVAL. FINAL APPROVAL COMMENCES AT THE PLANNING BOARD MEETING DATE AT WHICH THE PLAN RECIEVES FINAL APPROVAL.






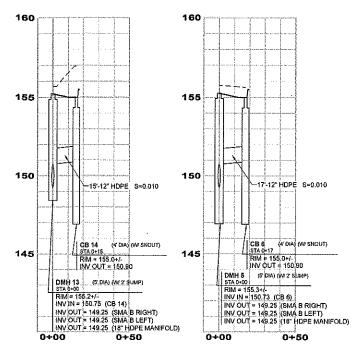

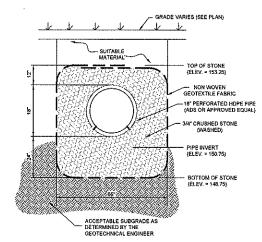



STORMWATER MANAGEMENT AREA 'C' **INFILTRATION TRENCH DETAIL**

- NOTES STRUCTURE DIAMETERS AS SHOWN ON DRAINAGE PROFILES ARE CONSIDERED TO BE MINIMUM INSIDE DIMENSIONS, ALL STRUCTURES SHALL BE A MINIMUM INSIDE DIAMETER OF 45" UNLESS OTHERWASE INDICATED LARGER STRUCTURES BAY DE NECESSARY DUE TO ALIGNMENT ANDIOR PIPE SIZES, STRUCTURE MANUFACTURER SHALL DETERMINE FINAL SIZE.
- PIPE LENGTHS ARE MEASURED FROM CENTERLINE OF STRUCTURE TO CENTERLINE OF STRUCTURE
- EXTERIOR FOUNDATION WALLS AND FOOTINGS AS SHOWN ARE APPROXIMATE
- VERTICAL DATUM IS NGVD29 (SEE NOTE 4 ON SHEET 2).
- THE CONTRACTOR SHALL VERIEY THE EXACT SIZE, LOCATION AND ELEVATION OF THE EXISTING SEWER SERVICE PIPE. THE INFORMATION SHALL BE PROVIDED TO THE ENGINEER PRIOR TO CONSTRUCTION.

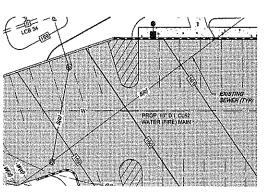

PLAN VIEW SCALE: 1" = 20'

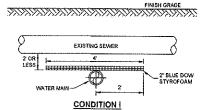


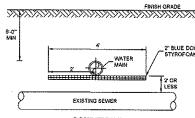

CONDITION II

PRIOR TO CONSTRUCTION THE CONTRACTOR SHALL DIG TEST PITS TO VERIFY THE EXACT LOCATION, SIZE AND ELEVATION OF THE EXISTING SANITARY SEWER LINE AND REPORT IT TO THE ENGINEER. FINAL ADJUSTMENTS TO THE WATER LINE SEWER LINE CROSSING DETAIL CAN SE MADE AT THAT TIME.

SEWER PIPE / WATER MAIN **INTERSECTION RUNS - ELEV. VIEW**

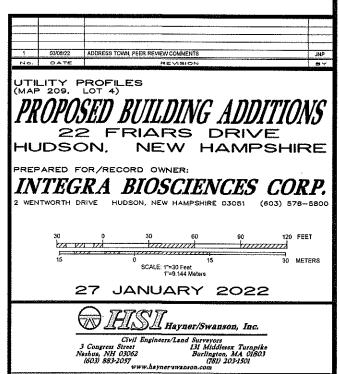


8 OF 15


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ORAWING NAME: 5734 SITE-FY21

RAWING LOC: J: \5000\5734\DWG\5734 SITE 2021


FIELD BOOK: 1234



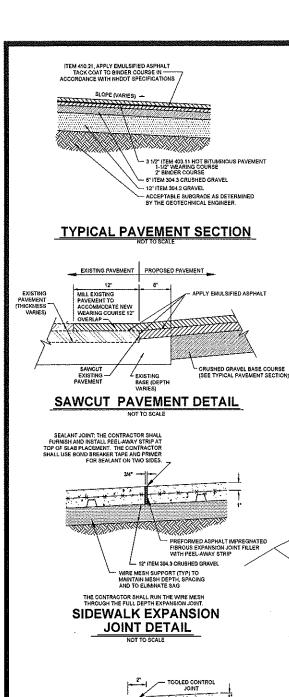


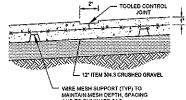JOINT DETAIL


DATE OF MEETING:

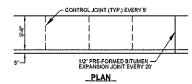



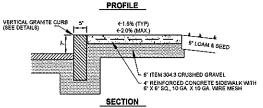


VERTICAL GRANITE CURB AND REINFORCED CONCRETE SIDEWALK DETAIL

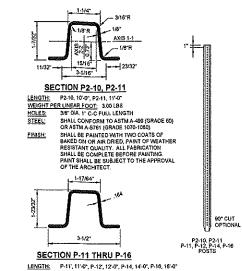


STEEL: SAME AS FOR P2-10, P2-11
FINISH: SAME AS FOR P2-10, P2-11

E SERVE




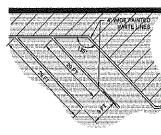


TYP. PARKING STALL DETAIL

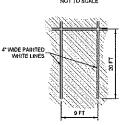


TYP. PARKING STALL DETAIL

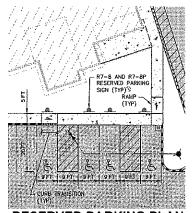



RESERVED PARKING PLAN

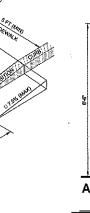

ACCESSIBLE PARKING SIGN DETAIL

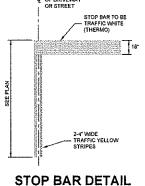

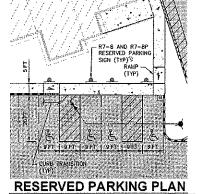

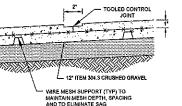

THE CONTRACTOR SHALL PROVIDE TOOLED CONTROL JOINTS @ 5-0" DIC PROVIDE FULL DEPTH EXPANSION JOINT @ 20-0" DIC AND AT ALL SIDEWALK INTERSECTIONS, T'S, L'S AND CORNERS. DO NOT USE PRE-FORMER KEY COLD, JOINTS. JOINTS SHALL ALSO LINE UP WITH BOTH SIDES OF T SLAB INTERSECTIONS.

CONCRETE CONTROL



WHERE ACCESSIBLE ROUTES ARE LESS THAN 5 FT IN WIDTH (EXCLUDING CURB) A 5 FT x 5 FT PASSING AREA SHALL BE PROVIDED AT INTERVALS NOT TO EXCEED 200 FEET.

ELIMINATE ALL CURBING AT RAMP (OTHER THAN VERTICAL CURBING, WHICH SHALL BE SET FLUSH) WHERE IT ABUTS PAVEMENT.


NOTES:

1. THE MAXIMUM ALLOWABLE SIDEWALK AND CURB RAMP CROSS SLOPES SHALL BE 1.5% (1% MIN). THE MAXIMUM ALLOWABLE SLOPE OF ACCESSIBLE ROUTE EXCLUDING CURB RAMPS SHALL BE 5%. 3. THE MAXIMUM ALLOWABLE SLOPE OF ACCESSIBLE ROUTE CURB RAMPS SHALL BE 7.5%.


4. A MINIMUM OF 3 FEET CLEAR SHALL BE MAINTAINED AT ANY PERMANENT OBSTACLE IN ACCESSIBLE ROUTE (E. HYDRANTS, UTILITY POLES, TREE WELLS, SIGNS, ETC.)

5. CURB TREATMENT VARIES, SEE PLANS FOR CURB TYPE.

BASE OF RAMP SHALL BE GRADED TO PREVENT PONDING SEE TYPICAL SIDEWALK SECTION FOR RAMP CONSTRUCTION.

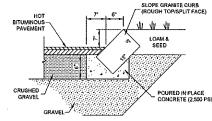

SLOPE GRANITE **CURB DETAIL**

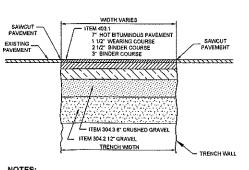

- NOTES:

 1. THE CONTRACTOR SHALL SAWCUT PAVEMENT FOR TRENCH CONSTRUCTION PER THE PLAN

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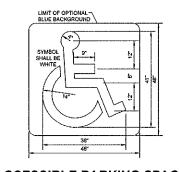
 1. THE CONTRACTOR SHALL SAWCUT PAVEMENT FOR TRENCH CONSTRUCTION PER THE PLAN

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 1. THE PLA THE CONTRACTOR SHALL INSTALL UTILITIES IN ACCORDANCE WITH THE PLANS, DETAILS AND UTILITY COMPANY/MUNICIPAL STANDARDS.
- THE CONTRACTOR SHALL BACKFILL TRENDES AS SHOWN ON THE DETAIL AND BINDER COURSE PAVEMENT THE DISTURBED TRENDES SHOWN ON THE DETAIL AND BINDER SURFACES SHALL BE FLUSH WITH THE BURROUNDING PAVEMENT AND SHALL REMAIN FOR 90 DAYS.
- 4. AFTER 90 DAYS THE CONTRACTOR SHALL MILL IS INCHES OF ASPHALT OVER THE ENTIRE WIDTH OF MYSTILE STREET AS SHOWN ON THE PLAN AND THEN FILL WITH IS INCHES OF WEARING COURSE PAVEMENT.


TRENCH PATCH DETAIL



ACCESSIBLE PARKING SPACE **PAVEMENT MARKING**

SLOPE VARIES -ACCEPTABLE SUBGRADE AS DETERMINED BY THE GEOTECHNICAL ENGINEER 6" ITEM 304.3 CRUSHED GRAVEL

> TYPICAL SECTION **BITUMINOUS SIDEWALK**

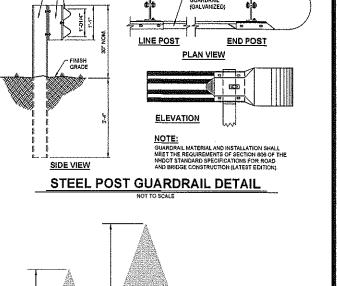

- 4"x 6" I-BEAM POST 8.5 LB./FT, OR 9.0 LB./FT. 5-9' LONG - 4" x 6" I-BEAM OFFSET BLOCK

STEEL BEAM

ALL FLOW ARROWS TO BE SOLID WHITE REFLECTIVE THERMOPLASTIC AS PER DIMENSIONS SHOWN.

2. REVERSE ARROWS FOR OPPOSITE DIRECTIONS OF FLOW

PAINTED TRAFFIC ARROWS DETAIL



DETAIL SHEET - GENERAL SITE (MAP 209, LOT 4)

PROPOSED BUILDING ADDITIONS 22 FRIARS DRIVE HUDSON, NEW HAMPSHIRE

PREPARED FOR/RECORD OWNER:

INTEGRA BIOSCIENCES CORP.

WENTWORTH DRIVE HUDSON, NEW HAMPSHIRE 03051 (603) 578-5800


SCALE AS SHOWN

27 JANUARY 2022



Civil Engineers/Land Surveyors Street 131 Middlesex Turnpike 1 03062 Burlington, MA 01803 2057 (781) 203-1501 J Congress Street Nashue, NH 03062 (603) 883-2057

DRAWING NAME: 5734 SITE-DET FIELD 800K: 1234 9 OF 15 5734

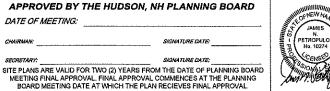

PURSUANT TO THE SITE REVIEW REGULATIONS OF


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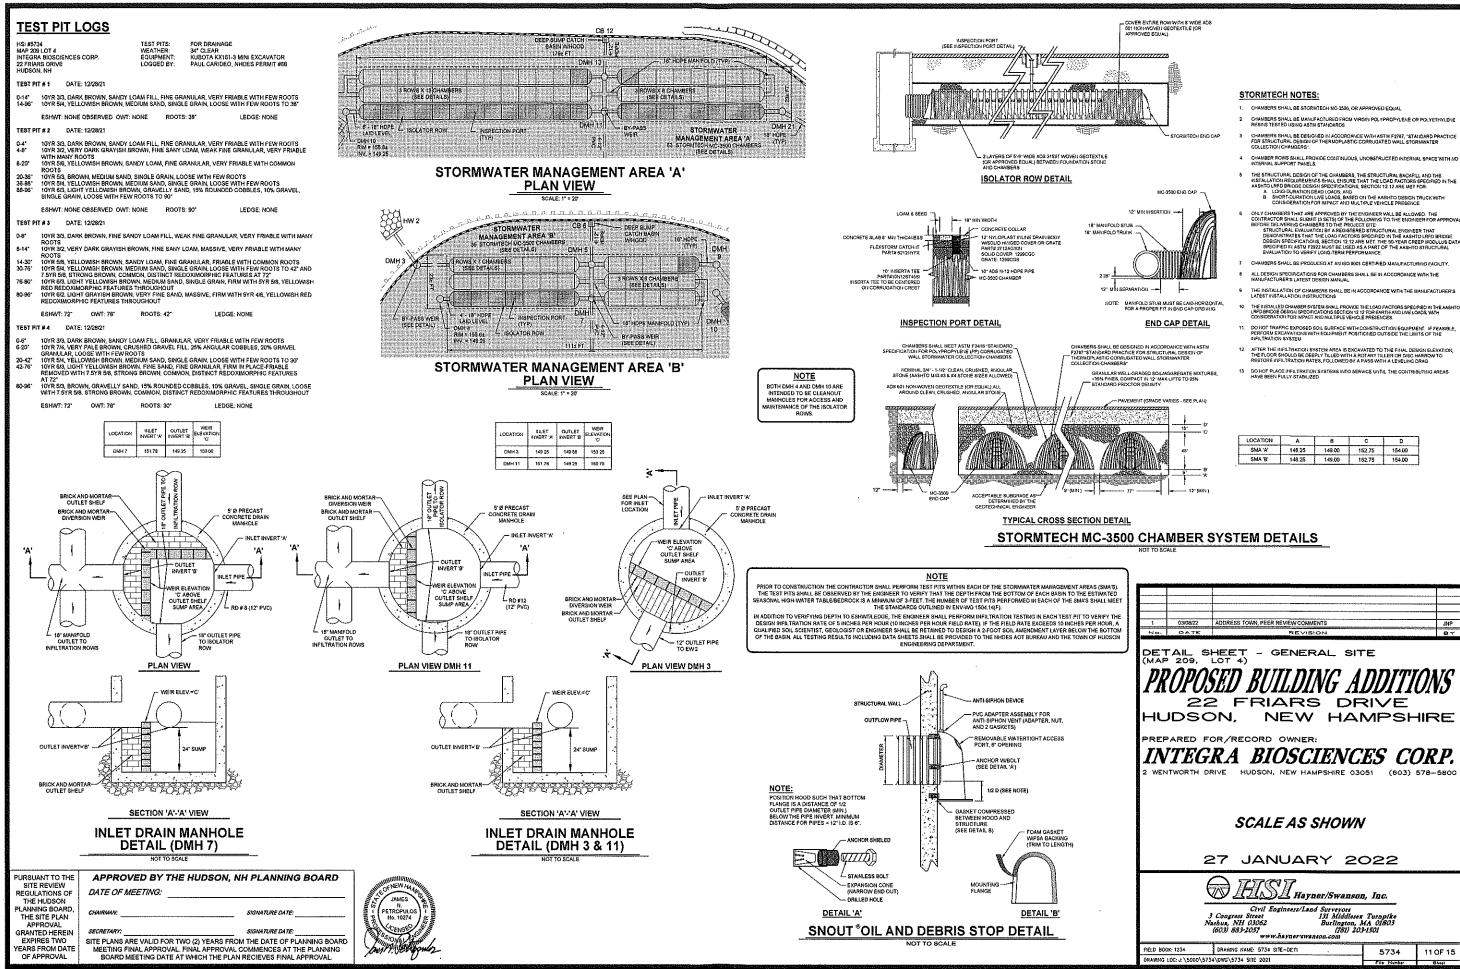
ANNING BOARD


THE SITE PLAN

GRANTED HEREIN

EXPIRES TWO



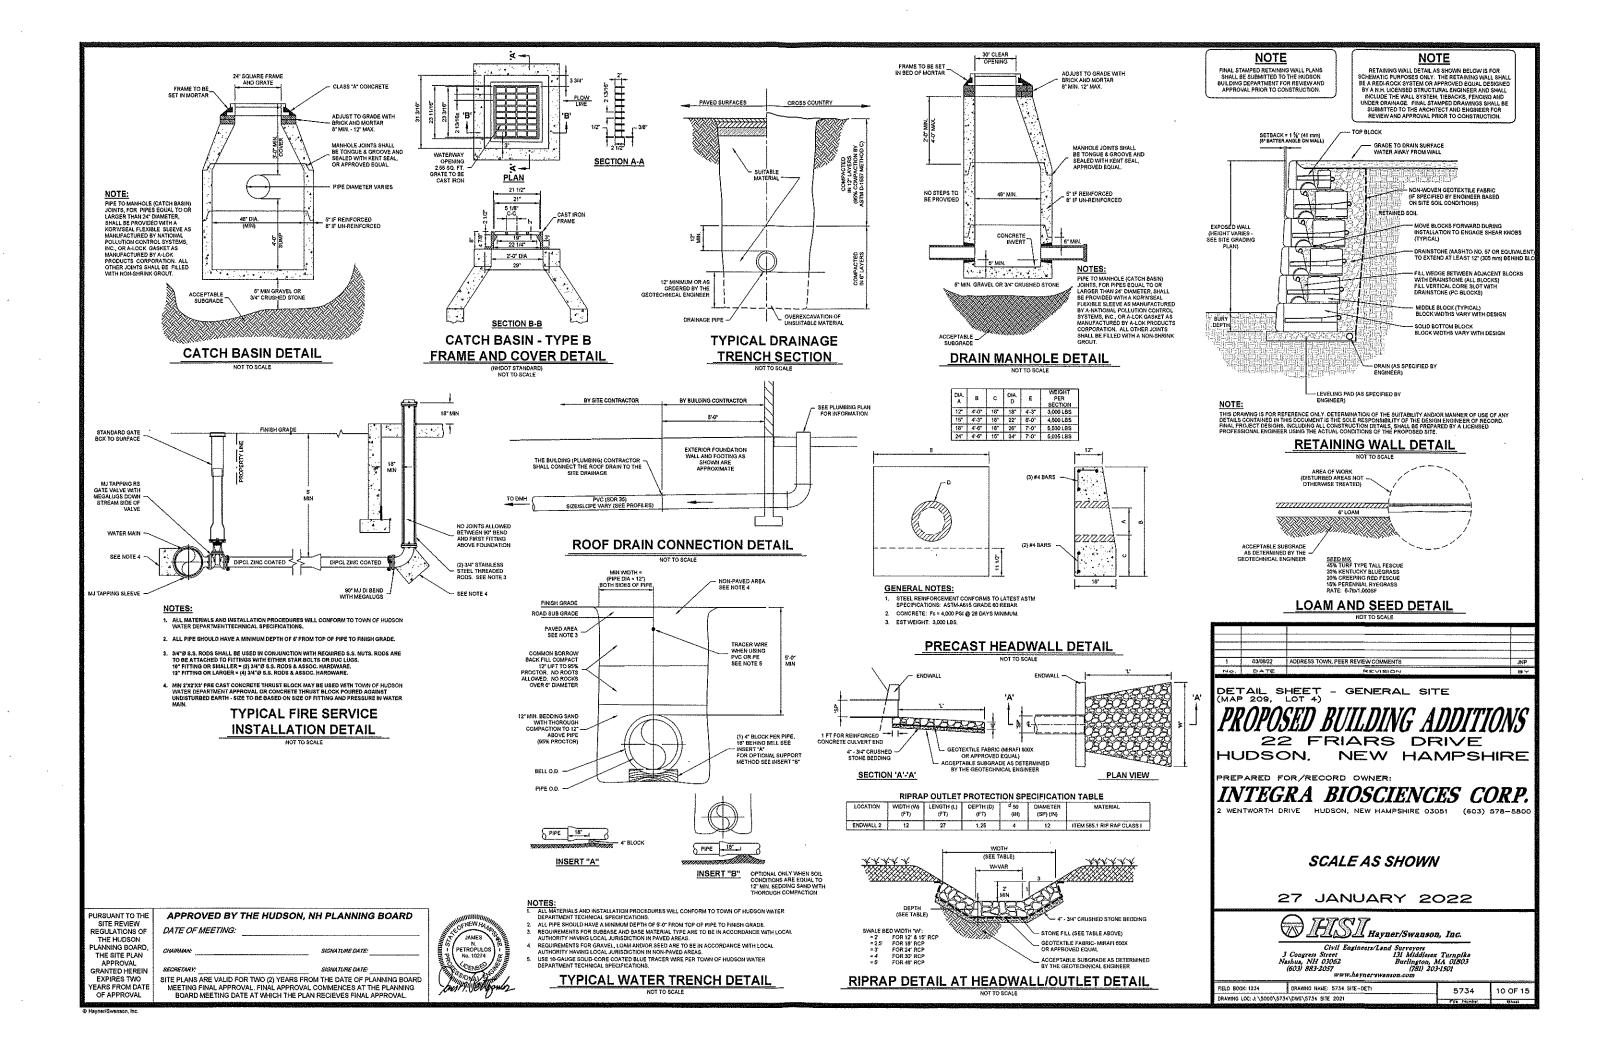

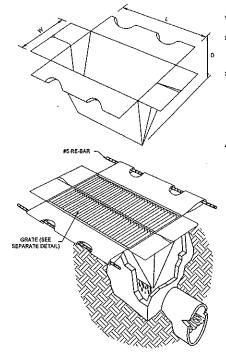

SILTSAK® NOTES:

1.0 THE SILTSAK® SHALL BE MANUFACTURED FROM WOVEN POLYPROPYLENE AND SEWN BY A DOUBLE NEEDLE MACHINE, USING A HIGH STRENGTH NYLON THREAD.

FLOW -

FLOW -

- THE SILTSAK® SEAMS SHALL HAVE A CERTIFIED AVERAGE WIDE WIDTH STRENGTH PER ASTM D-4884 STANDARDS AS FOLLOWS:
- UNTERSTANCE SEAMS STABLE HAVE A CERTIFIED AVERAGE WIDE WIDTH STRENGTH PER ASTIN A-884 STANDARDS AS FOLLOWS:

 S.R.TSAKK STYLE TEST METHOD TEST METHOD

 REGULAR FLOW ASTIM D-4894 185 OLBSIN 184 LIBSIN 184 LIBSIN
- 4.0 THE GEOTEXTILE FABRIC SHALL BE WOVEN POLYPROPYLENE FABRIC WITH THE FOLLOWING PROPERTIES:

SILTSAK® REGULAR F	LOW	
PROPERTY	TEST METHOD	TEST RESUL
GRAB TENSILE	ASTM D-4832	300 LE
GRAB ELONGATION	ASTM D-4831	20
PUNCTURE	ASTM D-4833	120 LE
AULLEN BURST	ASTM D-3786	800 P
TRAPEZOID TEAR	ASTM D-4533	120 LE


TRAPEZOID TEAR	ASTM D-4533	120 LE
UV RESISTANCE	ASTM 0-4355	80
APPARENT OPENING	ASTM D-4751	40 US SIEV
PLOW RATE	ASTM D-4491	40 GAL/MIN/FT
PERMITTIVITY	ASTM D-4491	0.55 SE
OR SILTSAK® HI-FLOW		
PROPERTY	TEST METHOD	TEST RESUL
GRAB TENSILE	ASTM D-4632	265 LE
GRAB ELONGATION	ASTM D-4632	20

20% 135 LBS PUNCTURE ASTM D-4833 MULLEN BURST ASTM D-378 420 PSI 45 L85 TRAPEZOID TEAR ASTM D-4533 UV RESISTANCE ASTM D-4355 90% APPARENT OPENING ASTM D-475 20 US SIEVE 200 GAL/MIN/FT2 FLOW RATE ASTM D-4491

ASTM D-449

1.5 SEC

SILTSAK® DETAIL

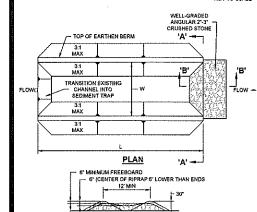

SEDIMENT TRAP INSTALLATION NOTES:

PERMITTIVITY

- SEE PLAN VIEW FOR: -LOCATION, LENGTH AND WIDTH OF SEDIMENT TRAP.
- SEDIMENT THAPS SHALL BE SIZED TO PROVIDE A VOLUME OF 3,600 PER ACRE OF CONTRIBUTING DRAINAGE AREA. SEDIMENT THAPS SHALL BE INSTALLED PRIOR TO ANY UPGRADIENT LAND-DISTURBING ACTIVITIES. SEDIMENT TAPA BERM SHALL BE CONSTRUCTED FROM MATERIAL FROM EXCAVATION. THE BERM SHALL BE COMPACTED TO 95% OF THE MAXIMUM DENSITY IN ACCORDANCE WITH ASTMEDBER.
- SEDIMENT TRAP OUTLET TO BE CONSTRUCTED OF WELL-GRADED ANGULAR 2"-3" CRUSHED STONE.
- THE TOP OF THE EARTHEN BERM SHALL BE A MINIMUM OF 8" HIGHER THAN THE TOP OF THE OUTLET STRUCTURE.
- 7. THE ENDS OF THE OUTLET STRUCTURE SHALL BE A MINIMUM OF 6" HIGHER THAN THE CENTER OF THE OUTLET STRUCTURE

SEDIMENT TRAP MAINTENANCE NOTES:

- INSPECT BMP8 EACH WORKDAY, AND MAINTAIN THEM IN BEFECTIVE OPERATING CONDITION, MAINTENANCE OF BMP8 SHOULD BE PROACTIVE, NOT REACTIVE, INSPECT BMP8 AS SOON AS POSSIBLE (AND ALWAYS WITHIN 24 HOURS) FOLLOWING A STORM THAT CAUSES SURFACE EROSION, AND PERFORM INCESSARY WAINTENANCE ARE FREQUENT OBSERVATIONS AND MAINTENANCE ARE INCESSARY TO MAINTAIN BMP8 IN EFFECTIVE OPERATING CONDITION, INSPECTIONS AND CORRECTIVE MEASURES SHOULD BE DOCUMENTED THOROUGHLY.
- SHOULD BE DOCUMENTED THOROUGHLY.
 WHERE BMPB HAVE FAILED, REPAIR OR REPLACEMENT
 SHOULD BE INITIATED UPON DISCOVERY OF THE FAILURI
- REMOVE SEDIMENT ACCUMULATED IN TRAPA SN NEEDED TO MAINTAIN THE PUNCTIONALITY OF THE BMP. TYPICALLY WHEN THE SEDIMENT DEPTH REACHES 1/2 THE HEIGHT OF THE OUTLET.
- 5. SEDIMENT TRAPS SHALL REMAIN IN PLACE UNTIL THE CONTRIBUTING DISTURBED AREA IS STABILIZED.
- WHEN SEDIMENT TRAPS ARE REMOVED. THE DISTURBED AREA SHALL BE COVERED WITH TOPSOIL, SEEDED AND MULCHED OR OTHERWISE STABILIZED.

SECTION B

DATE OF MEETING:

9

EPA

FILE THE EPA NOTICE OF INTENT (NOI) FORM AT LEAST 14 DAYS PRIOR TO

CONSTRUCTION


WELL-GRADED ANGULAR

SECTION A

SEDIMENT TRAP DETAIL

SITE PLANS ARE VALID FOR TWO (2) YEARS FROM THE DATE OF PLANNING BOARD

MEETING FINAL APPROVAL. FINAL APPROVAL COMMENCES AT THE PLANNING BOARD MEETING DATE AT WHICH THE PLAN RECIEVES FINAL APPROVAL.

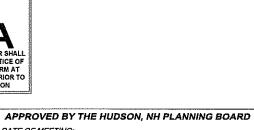

SIGNATURE DATE:



TEMPORARY OUTLET TO WASH WHEELS IF Philosoppus Philos DIVERSION RIDGE (WHERE REQUIRED) 75' MtN

(MAY BE 50' WHERE DIVERSION RIDGE IS PROVIDED)

PLAN VIEW

NOTE:

- 3"-6" OR GREATER ROADWAY SECTION 'A'-'A' VIEW

3" TO 4

SECTION VIEW

AREA TO BE PROTECTED

EROSION CONTROL FILTER

MAINTENENCE SILT SOCK BARRIER SHALL BE INSPECTED IMMEDIATELY AFTER EACH RAINFALL AND AT LEAST DAILY DURING PROLONGED RAINFALL. ANY REPAIRS THAT ARE REQUIRED SHALL BE MADE IMMEDIATELY.

If the Silt sock should decompose or become ineffective during the expected Life of the Fence, the Barrier shall be replaced promptly. SEDIMENT DEPOSITS SHOULD BE INSPECTED AFTER EVERY STORM EVENT. THE DEPOSITS SHOULD BE REMOVED WHEN THEY REACH APPROXIMATELY ONE-THIRD THE HEIGHT OF THE BARRIER.

A SCHIMENT DEPOSITS THAT ARE REMOVED OR LEFT IN PLACE AFTER THE BARRIER HAS BEEN REMOVED SHALL BE GRADED TO CONFORM WITH THE EXISTING TOPOGRAPHY AND VEGETATED.

CONSTRUCTION SPECIFICATIONS

THE FABRIC SHALL BE EMBEDDED A MINIMUM OF B INCHES INTO THE GROUND AND THE SOIL COMPACTED OVER THE EMBEDDED FABRIC

FILTER CLOTH SHALL BE FASTENED SECURELY TO THE WOVEN WIRE FENCE WITH TIES SPACED EVERY 24 INCHES AT THE TOP, MID-SECTION, AND BOTTOM.

6. FENCE POSTS SHALL BE A MINIMUM OF 36 INCHES LONG AND DRIVEN A MINIMUM OF 16 INCHES INTO THE GROUND. WOOD POSTS SHALL BE OF SOUND QUALITY HARDWOOD AND SHALL HAVE A MINIMUM CROSS SECTIONAL AREA OF 3.0 SQUARE INCHES.

7. MAINTENANCE SHALL BE PERFORMED AS NEEDED TO PREVENT BULGES IN THE SILT FENCE DUE TO DEPOSITION OF

SILT SOCK DETAIL

VIEW LOOKING UPSTREAM

SECTION A-A

TEMPORARY STONE CHECK

DAM TYPICAL SECTION

5. WHEN TWO SECTIONS OF FILTER CLOTH ADJOIN EACH OTHER, THEY SHALL BE OVERLAPPED BY 6 INCHES, FOLDED, AND STAPLED.

3. WOVEN WIRE FENCE SHALL BE FASTENED SECURELY TO THE FENCE POSTS WITH WIRE TIES OR STAPLES.

AREA TO BE PROTECTED

1. THE GEOTEXTILE FABRIC SHALL MEET THE DESIGN CRITERIA FOR SILT FENCES.

WORK AREA

EROSION CONTROL FILTER SHALL BE FILTERMITT OR SILTSOXX OR APPROVED EQUAL.

2. EROSION CONTROL FILTER SHALL BE INSTALLED IN ACCORDANCE WITH
MANUFACTURER'S RECOMMENDATIONS

3. COMPOST TO BE REMOVED OR DISPOSED ON SITE AS DETERMINED BY

NOTES:

WELL-GRADED ANGULAR 2" TO 3" STONE, 3/4" STONE ON THE UPGRADIENT FACE IS RECOMMENDED FOR BETTER FILTERING

- THE EXIT SHALL BE MAINTAINED IN A CONDITION THAT WILL PREVENT TRACKING OF FLOWING OF SEDIMENT ONTO PUBLIC RIGHT-OF-WAYS THIS MAY REQUIRE TOP DRESSING, REPAIR AND/OR CLEAN OUT OF ANY MEASURES USED TO TRAP SEDIMENT.
- WHEN NECESSARY, WHEELS SHALL BE CLEANED PRIOR TO EXITING THE SITE ONTO A PUBLIC RIGHT-OF-WAY.
- WHEN WASHING IS REQUIRED, IT SHALL BE DONE ON AN AREA STABILIZED WITH CRUSHED STONE THAT DRAINS INTO AN APPROVEI SEDIMENT TRAP OR SEDIMENT BASIN.
- CONSTRUCTION SPECIFICATIONS AND MAINTENANCE REQUIREMENTS SHOWN IN NHDES STORMWATER MANUAL VOLUME 3.

TEMPORARY GRAVEL CONSTRUCTION EXIT

GENERAL NOTES

- all soir erosion and sediment control measures shall be in accordance with Standards and Specifications thereof in New Hampshire department of Environmental Services Stormwater Mannals, Volube 7, as amelioded.
- THE WORK AREA SHALL BE GRADED, SHAPED, AND OTHERWISE DRAINED IN SUCH A MANINER AS TO MANINES SOIL PROSON, SITATION OF GRAINING CHAININES, DAMAGE TO EXISTING VEGETATION, AND DAMAGE TO PROPERTY OUTSIDE THE LIMITS OF THE WORK AREA. SIT FENCES, STRAW BALES ANDIOR DETENTION BASINS WALL BE INCESSANT OF ACCOUNTEIN THIS BIO.
- STRIPPED TOPSOIL SHALL BE STOCKPILED, WITHOUT COMPACTION, AND STABILIZED AGAINST EROSION IN ACCORDANCE WITH TEMPORARY STABILIZATION OF DISTURBED AREAS. AS OUTLINED IN NOTE No. 4.
- TEMPORARY STABILIZATION OF DISTURBED AREAS; SEED BED PREPARATION: 10-10-10 FERTILIZATION TO BE SPREAD AT THE RATE OF 7 LB9 PER 1,000 SF AND ACRICULTURAL IMPRESTORS AT ARTE OF SO ISS PER 1,000 SF AND INCORPORATED INTO THE SOIL. THE SOIL, FERTILIZER AND LIMESTORS SHALL BE TILLED TO PREPARE FOR SEEDING.
- A. REED MIXTURE: USE ANY OF THE FOLLOWING

SPECIES	RATE PER 1,000 SF	DEPTH	SEEDING DATES
WHTER RYE	2.5 LBS	1,	08/15 TO 09/15
BTAO	2.5 LBS	1-	04/15 TO 10/15
AHNUAL RYE GRASS	1.0 LBS	0.25*	08/15 TO 09/15

B. MULCHING: MULCH SHOULD BE USED ON HIGHLY ERODABLE AREAS, AND WHERE CONSERVATION OF

TYPE	RATE PER 1,000 SF	USE & COMMENTS
STRAW	70 TO 90 LBS	MAY BE USED WITH PLANTINGS, MUST BE ANCHORED TO BE USED ALONE
WOOD CHIPS OR BARK MULCH	460 TO 920 LBS	USED WITH TREE AND SHRUB PLANTINGS
FIBROUS MATTING	AS RECOMMENDED BY MANUFACTURER	MUST BE BIODEGRADABLE. USE IN SLOPE AREAS AND AREAS DIFFICULT TO VEGETATE.
CRUSHED STONE N° TO 1 N° DIA	SPREAD TO GREATER THAN M' THICKNESS	USE IN SPECIFIC AREAS AS SHOWN ON PLAN OR AS NEEDED.

- ERMANENT STABILIZATION OF DISTURBED AREAS:
 A. ALL ROADWAYS SHALL BE STABILIZED WITHIN 72 HOURS OF ACHIEVING FINISHED GRADE
 - ALL CUT AND FILL SLOPES SHALL BE SEEDED/LOAMED WITHIN 72 HOURS OF ACHIEVING PINISHED
- THE SMALLEST PRACTICAL AREA SHALL BE DISTURBED DURING CONSTRUCTION, BUT IN NO CASE SHALL EXCEED 5 ACRES AT ANY ONE TIME BEFORE DISTURBED AREAS ARE STABILIZED.
- AREA SHALL BE CONSIDERED STABILIZED IF ONE OF THE FOLLOWING HAS OCCURRED BASE COURSE GRAVELS HAVE BEEN INSTALLED IN AREAS TO BE PAVED.

 - A MINIMUM OF 5% VEGETATED GROWTH HAS BEEN ESTABLISHED.

 A MINIMUM OF 3 INCHES OF NON-EROSIVE MATERIAL SUCH AS STONE OR RIPRAP HAS BEEN INSTALLED. OR, EROSION CONTROL BLANKETS HAVE BEEN PROPERLY INSTALLED
- ALL AREAS SHALL BE STABILIZED WITHIN 45 DAYS OF INITIAL DISTURBANCE.
- SITE LOCATION:
 42° 44° 35° N. LATITUDE, 71° 25° 54° W. LONGITUDE (PER GOOGLE EARTH).
- TOTAL AREA OF DISTURBED SOILS: 170,850 SF±
- REFERENCE IS MADE TO THE LATEST EDITION OF THE FEDERAL REGISTER (63 FR 7857), ENVIRONMENTAL PROTECTION AGENCY NPDES GENERAL PERMITS FOR STORMATER DISCHARGES FROM CONSTRUCTION ACTIVITIES. FOR ADDITIONAL INFORMATION CONTACT (270) 566-586 OR WWW sea DWINDAGES/SEMPLIAND
- THE ENTIRE CONTENTS OF THE STORMWATER POLLUTION PREVENTION PLAN (SWIPP) SHALL BE RETAINED ON-SITE FOR THE DURATION OF THE CONTRACT AND BE MADE AVAILABLE TO LOCAL, STATE AND FEDERAL
- THIS PROJECT SHALL BE MANAGED TO MEET THE REQUIREMENTS AND INTENT OF RSA 430:83 AND AGR 3800 RELATIVE TO INVASIVE SPECIES; AND FUGITIVE DUST IS CONTROLLED IN ACCORDANCE WITH ENVA

WINTER CONDITION NOTES

- ALL PROPOSED POST-DEVELOPMENT VEGETATED AREAS WHICH DO NOT EXHIBIT A MINIMAM OF 85% VEGETATIVE GROWTH BY OCTOBER 15% OR WHICH ARE DISTURBED AFTER OCTOBER 15%. SHALL BE STABBLIZED BY SEEDING AND ISTALLING EROSION CONTROL BANKETS ON SLOPES GREATER THAM 3.1, AND SEEDING AND PLACING 3 TO 4 TONS OF MULCH PER ACRE, SECURED WITH AND-HORED METTING, CLESWHERE. THE PLACEMENT OF REOSION CONTROL BANKETS OR MILICH AND NETTING SHALL NOR DOCUMENT ACCUMULATED SHOW OR ON FROZEN GROUND AND SHALL BE COMPLETED IN ADVANCE O'THAW OR SPRING MET TEVENTS.
- ALL DITCHES OR SWALES WHICH DO NOT EXHIBIT A MINIMUM OF 85% VEGETATIVE GROWTH BY OCTOBER 15th, OR WHICH ARE DISTURBED AFTER OCTOBER 15th, SHALL BE STABILIZED WITH STONE OR EROSION CONTROL BLANKETS APPROPRIATE FOR THE DESIGNAT LOW CONDITIONS.
- AFTER OCTOBER 15TH, INCOMPLETE ROAD OR PARKING SURFACES SHALL BE PROTECTED WITH A MINIMUM OF 3-INCHES OF CRUSHED GRAVEL PER NHDOT ITEM 304.3.

SITE MAINTENANCE/INSPECTION PROGRAM

THE FOLLOWING PROVIDES AN ITEMIZATION OF SPECIFIC SITE MAINTENANCE PRACTICES THAT WILL BE EMPLOYED ON THE SITE TO MINIMIZE FOLLUTANT GENERATION AND TRANSPORT FROM THE SITE. THE SITE MAINTENANCE PROGRAM INCLUDES ROUTINE INSPECTIONS, PREVENTATIVE MAINTENANCE AND "GOOD HOUSEKEEPING" PRACTICES.

ROUTINE INSPECTIONS

THE CONTRACTOR SHALL INSPECT ALL CONTROL MEASURES AT LEAST ONCE A WEEK AND WITHIN TWELVE (12) HOURS OF THE BHO OF A STORM WITH RAINFALL AMOUNT GREATER THAN 6.5 MICHES. THE HISPECTIONS WILL VERBLY THAT THE STRUCTURAL BURD SECRIBED IN THE PLANS AGE IN GOOD CONDITION AND ARE MINIMAING EROSION. A MAINTENANCE INSPECTION REPORT VIIL BE MADE WITH EACH INSPECTION ACCOMPLETED INSPECTION FROM SHALL BE REPORTIVED BY THE DURATION OF THE PROJECT, FOLLOWING CONSTRUCTION, THE COMPLETED FORMS SHALL BE RETAINED AT THE CONTRACTOR'S OFFICE FOR A MINIMUM OF ONE YEAR.

PREVENTATIVE MAINTENANCE

THE CONTRACTOR SHALL BE RESPONSIBLE FOR MAINTENANCE OF ALL TEMPORARY AND PERMANENT CONTROLS THROUGHOUT THE DURATION OF THIS CONTRACT, MAINTENANCE PRACTICES SHALL INCLUDE.

- CLEANING OF CATCH BASINS TWICE PER YEAR OR MORE FREQUENTLY AS DICTATED BY QUARTERLY INSPECTIONS
- CLEANING OF SEDIMENT AND DEBRIS FROM STORMWATER MANAGEMENT AREA FOREBAY TWICE PER YEAR OR MORE FREQUENTLY AS DICTATED BY MONTHLY HISPECTIONS.
- IMPLEMENTATION OF OTHER MAINTENANCE OR REPAIR ACTIVITIES AS DEEMED NECESSARY BASED UPON WEEKLY INSPECTIONS.
- REMOVAL OF BUILT UP SEDIMENT ALONG SILT FENCES AND/OR HAY BALE BARRIERS
- REMOVAL OF BUILT UP SEDIMENT IN BOTH TEMPORARY AND PERMANENT CONTROLS SUCH AS GRASS SWALES, SEDIMENT FOREBAYS AND RECHARGE/DETENTION BASINS.
- RECONSTRUCTING THE TEMPORARY GRAVEL CONSTRUCTION EXIT IF NOT WORKING PROPERLY.
- TREATMENT OF NON-STORM WATER DISCHARGES SUCH AS WATER FROM WATER LINE FLUSHINGS OR GROUNDWATER FROM DEWATERING SECAVATIONS. SUCH FLOWS SHOULD BE DIRECTED TO A TEMPORARY SEDIMENTATION BASIN OR TOKNIMVATER MANAGEMENT ARE
- SWEEP PARKING LOTS AND DRIVES REQULARLY TO MINIMIZE SEDIMENT ACCUMULATION. FREQUENCY WILL VARY SEASONALLY ACCORDING TO SEDIMENT ACCUMULATION ON PAVE SURFACES (E.G., MORE FREQUENT SWEEPING DURING THE WINTER AND SPRING.

GOOD HOUSEKEEPING PRACTICES

- THE CONTRACTOR SHALL EMPLOY MEASURES AND PRACTICES TO REDUCE THE RISK OF SPILLS OR OTHER ACCIDENTAL EXPOSURE OF MATERIALS TO STORM AND WATER RUNOFF. THE CONTRACTOR SHALL PAY SPECIAL ATTENTION TO THE HANDLING, USE AND DISPOSAL OF MATERIALS SUCH AS PETROLEUM PRODUCTS, FERTILIZERS AND PAINTS TO ENSURE THAT THE RISK ASSOCIATED WITH THE USE OF THESE PRODUCTS IS MIRIMAZED. THE FOLLOWING "GOOD HOUSEKEEPING" FRACTICES SHALL BE FOLLOWED DURING CONSTRUCTION OF THE PROJECT:
- INSTRUCTION OF THE PROJECT:

 A. AN EFFORT SHALL BE MADE TO STORE ONLY ENOUGH PRODUCT REQUIRED TO DO THE JOB

 A. THE PROJECT OF THE PROJECT OF THE PROPERTY OF
- ALL MATERIALS STORED ON-SITE SHALL BE STORED IN A NEAT, ORDERLY MANNER IN THE APPROPRIATE CONTAINERS AND, IF POSSIBLE, UNDER A ROOF OR OTHER ENCLOSURE.
- C. PRODUCTS SHALL BE KEPT IN THEIR ORIGINAL CONTAINERS WITH THEIR MANUFACTURERS' LABELS D. WHENEVER POSSIBLE, ALL OF A PRODUCT SHALL BE USED BEFORE DISPOSING OF THE CONTAINER
- MANUFACTURERS' RECOMMENDATIONS FOR PROPER USE AND DISPOSAL SHALL BE FOLLOWER
- THE CONTRACTOR SHALL INSPECT DAILY TO ENSURE PROPER USE AND DISPOSAL OF MATERIALS

SPILL PREVENTION AND CLEANUP PRACTICES

- MANUFACTURERS' RECOMMENDED METHODS FOR SPILL CLEANUP WILL BE CLEARLY POSTED AND SITE PERSONNEL WILL BE MADE AWARE OF THE PROCEDURES AND THE LOCATION OF THE INFORMATION AND CLEANUP SUPPLIES.
- MATERIALS AND EQUIPMENT NECESSARY FOR SPILL CLEANUP WILL BE KEPT IN THE MATERIAL STORAGE AREA ON-SITE. EQUIPMENT AND MATERIAL WILL INCLUDE BUT NOT BE LIMITED TO BROOMS, DUSTPANS, MOPS, RAGS, GLOVES, GOOGLES, KUTTY LITTER, SAND, SAWDUST, AND PLASTIC AND METAL TRASH CONTAINERS SPECIFICALLY FOR THIS PURPOSE.
- ALL SPILLS WILL BE CLEANED UP IMMEDIATELY AFTER DISCOVERY
- THE SPILL AREA WILL BE KEPT WELL VENTILATED AND PERSONNEL WILL WEAR APPROPRIATE PROTECTIVE CLOTHING TO PREVENT INJURY FROM CONTACT WITH A HAZARDOUS SUBSTANCE.
- SPILLS OF TOXIC OR HAZARDOUS MATERIAL WILL BE REPORTED TO THE APPROPRIATE STATE OR LOCAL GOVERNMENT AGENCY, REGARDLESS OF THE SIZE.
- THE SPILL PREVENTION PLAN WILL BE ADJUSTED TO INCLUDE MEASURES TO PREVENT THIS TYPE OF SPILL FROM REOCCURRING AND HOW TO CLEAN UP THE SPILL IF THERE IS ANOTHER ONE. A DESCRIPTION OF THE SPILL WHAT CAUSED IT, AND THE CLEANUP MEASURES WILL ALSO BE INCLUDED.

		<u> </u>	
1	03/08/22	ADDRESS TOWN, PEER REVIEW COMMENTS	JNP
70.	DATE	REVISION	BY

DETAIL SHEET - EROSION CONTROL (MAP 209, LOT 4)

PROPOSED BUILDING ADDITIONS 22 FRIARS DRIVE HUDSON, NEW HAMPSHIRE

PREPARED FOR/RECORD OWNER:

INTEGRA BIOSCIENCES CORP.

2 WENTWORTH DRIVE HUDSON, NEW HAMPSHIRE 03051 (603) 578~5800

SCALE AS SHOWN

27 JANUARY 2022



Civil Engineers/Land Surveyors Street 131 Middleex Turnpike 1 03062 Burlington, MA 01803 3-2057 (781) 205-1501 3 Congress Street Neshua, NH 03062 (603) 883-2057 www.hayner-swanson.com

DRAWING NAME: 5734 SITE-DETI FIELD 800X: 1234 12 OF 15 5734

PURSUANT TO THE

REGULATIONS OF THE HUDSON


PLANNING BOARD


THE SITE PLAN APPROVAL GRANTED HEREI

EXPIRES TWO

ARS FROM DATE

SITE REVIEW

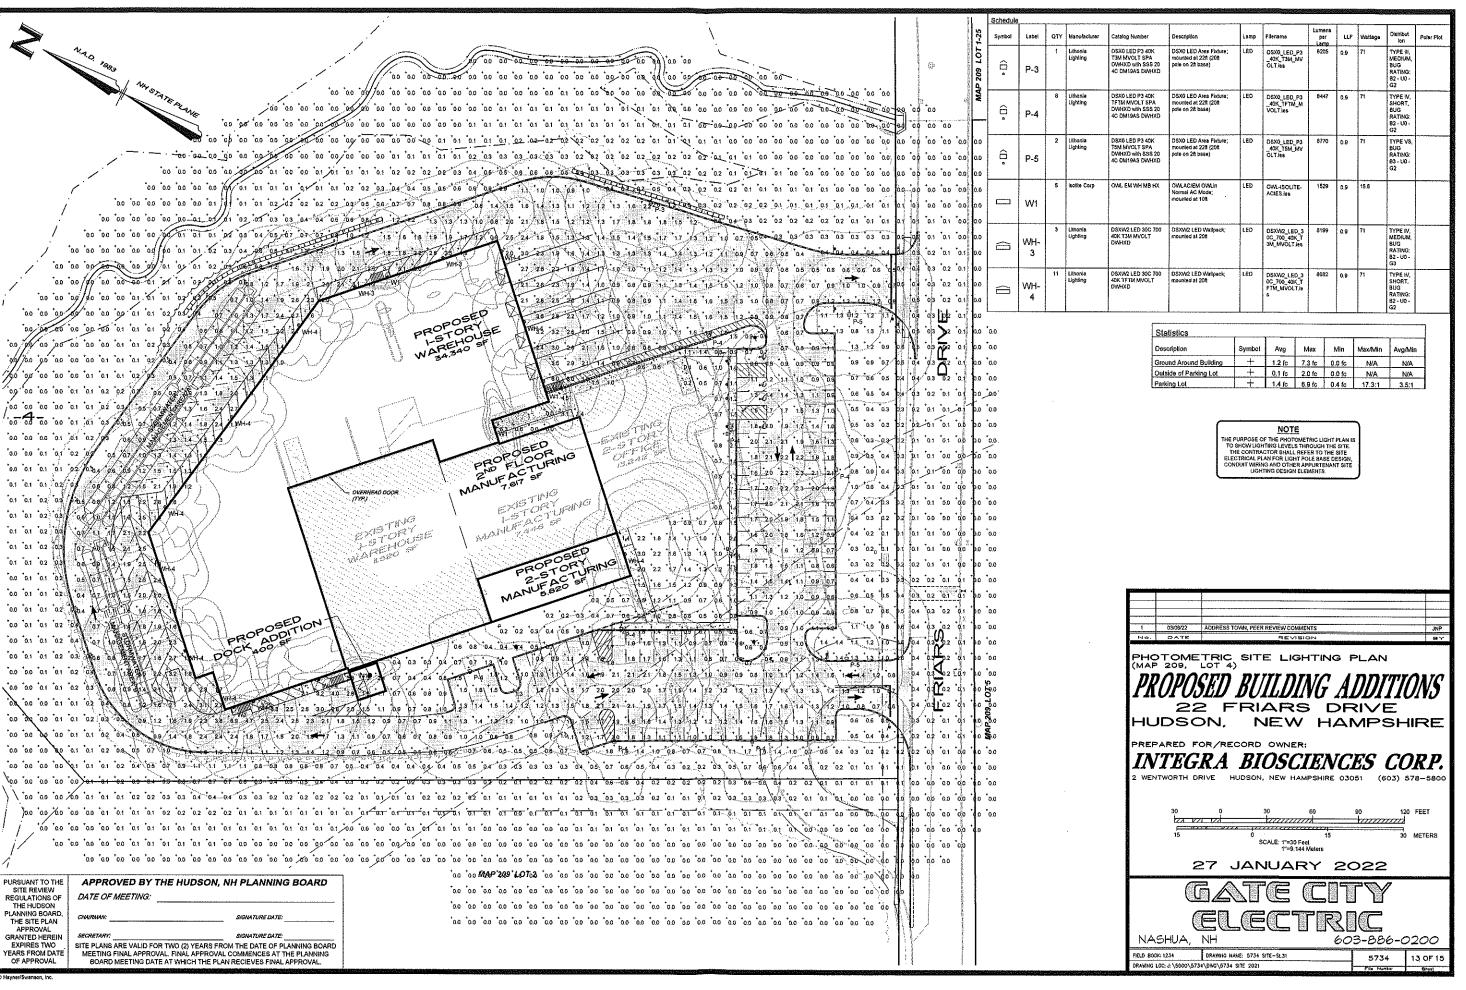

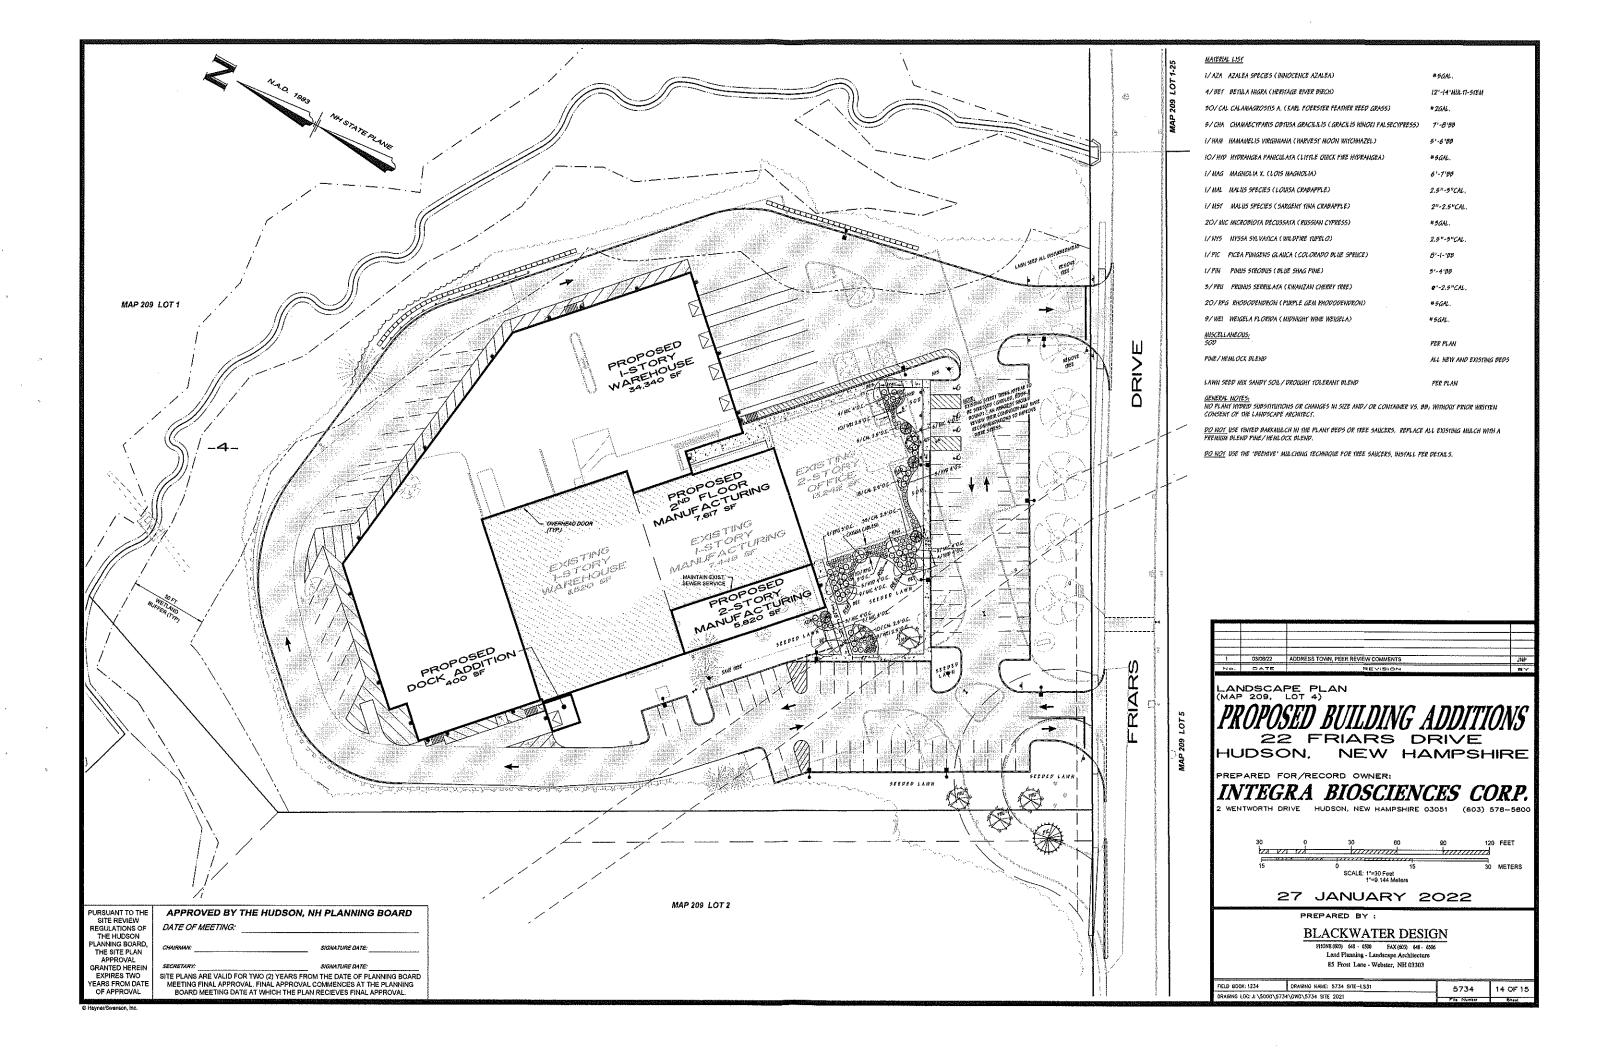


General Specifications


- The contractor shall at his expense furnish all the materials, supplies, machinery, equipment, tool, superintendent, labor, insurance, & other accessories and services necessary to complete the said project within the unit costs stated within the bid price.
- 2. The work to be done under this contract is as shown and described on the drawings. Each bidder shall make a careful examination of the plans and specifications (the plan shall dictate quantities) and acquaint himself with all conditions before making his proposal. He will be held responsible for errors in his proposal resulting from his failure to make such an examination. All bidders shall visit the site and inform themselves of all conditions.
- 3. The bids shall be based on materials and equipment complying with the drawings and the specifications. The contractor shall be responsible under this contract price, for furnishing and installing materials confirming to the bid items. Under no circumstances may a species 'hybrid' be substituted or size changed without written consent of the landscape architect.
- 4. The contractor shall be responsible for the protection of such existing utilities as water mains, sewer systems, gas mains, electrical conduits, telephone lines and any other utilities and if any damage or destruction may occur to these utilities, he shall be responsible for their repair and/or replacement at his expense.
- 5. The contractor shall make payment for all damages to bulldings, structures, trees, shrubs and/or any other property outside the construction area or located within those limits but not designated for removal or reconstructed providing such damage shall result from accident caused by negligence for which the contractor shall be legally liable.
- 6. If additional labor and/or materials is requested or required, the contractor shall submit a price to the owner. If the owner approves the price he shall prepare a change order for approval and signature. The contractor shall not proceed without a written authorization from the owner for the additional work. If the contractor proceeds with the additional work without this authorization he shall forfelt any claim for additional compensation.
- The landscape architect shall reserve the right to inspect the project work at any time deemed necessary to insure that the specifications and plans and any other contract documents are being followed.
- The L.A. shall have the right to reject any plant on-site based upon condition, size, or incorrect species or hybrid. LA must be contacted prior to install, to inspect materials delivered to the site, and to insure that soil amendments, bark mulch, roof ballust, etc. are to the written specifications.
- 9. All seeded areas shall receive a minimum 6" topsoil blanket (by site contractor) w/site preparation, raking and general clean up prior to application. Operations shall include a preemergence type herbicide, 12 -25 -12 granular fertilizer @ 10 ibs./1000 sf, and pelletized limestone @ 25 ibs./1000 sf power raked into the top 2" of soil prior to hydro-seeding. Ratios & application rates may change based upon the required soil analysis.
- Contractor is responsible for establishing a thick, weed free lawn. Seed shall be spread @ 4lbs./1000. Lawn germination shall be 95% free of noxious weeds for acceptance. Define differences in seed mixes (if applicable) with irrigation flagging until 2nd mowing. Site review by LA is required.

SITE PLANS ARE VALID FOR TWO (2) YEARS FROM THE DATE OF PLANNING BOARD MEETING FINAL APPROVAL. FINAL APPROVAL COMMENCES AT THE PLANNING BOARD MEETING DATE AT WHICH THE PLAN RECIEVES FINAL APPROVAL.

- 11. Review of the installed irrigation system by the designer is required prior to release of final payment.
- 12. Hydroseeding operations shall be a one part process with a paper fiber mulch; a tackifier shall be applied on all slopes greater than 3:1, Excelsor Drainage mat shall be applied to all 2:1 slopes and drainage swales per plan.
- Contractor shall maintain, from acceptance date, the lawn areas through the first mowing. Contractor is not responsible for the first mowing.
- All plant materials shall be installed in accordance with A.L.C.C. Trees and shrubs shall have appropriate soil mixtures, fertilizer and soil retention granules.
- 15. If the soil conditions are extremely sandy, all trees shall have a 6" layer of compacted topsoil (verify with Landscape Architect) placed in the base of the plant pit as a moisture retention layer. The plant pit sidewalls shall be over excavated by an additional 12" beyond the normal outside radius of the hole. A topsoil planting mixture shall be used to backfill as per spec # 22.
- 16. Landscape architect shall have the right to reject and have ground removed any plant material not of proper size or of weak quality, ie. thin, no lower branching, etc. Contractor must submit shipping lists (billing invoices) for verification, prior to installation.
- 17. All plant material shall be guaranteed for a period of one (1) year from date of installation. Any material which dies or does not show a healthy appearance within this time shall be replaced at the contractors expense; with same warranty requirements as the original. Warranty does not cover loss due mechanical damage, le. snow storage. Contractor should protect susceptable species from insect infestation. Use a liquid systemic application on birch, etc.
- 18. Plant beds and saucers vary in dia. (refer to dwg). Trees and shrubs shall receive a 4" (settled) covering of pine/hemlock bark mulch; saucer diameters per drawing & details. Deciduous trees shall have a 6" dia. saucer (typ.), evergreen trees shall have a sucer 2" min. beyond it's outter branches. All edges shall have a "V" groove.
- All B&B material which are encased in wire baskets shall have the wires cut loose and the top third removed prior to backfill operation.
- If road base is encountered in any plant bed areas, ie. parking islands, it shall be removed and suitable amended soil installed per drawings and specifications.
- 21. Soli planting mixture shall be a 6%-10% organic topsoli, amended with 10% wood ash, 10%%% manure, & 30%%% peatmoss or incorporate a dehydrated compost material. If planting in sand, gravel or other well drained soils, a 60% peatmoss to excavated soil. Other soil amendments shall include; Agriform tablets, Hydro-Gel or equal, and Roots growth enhancer to all trees and shrubs listed, per manufacturers specifications. All plant material pits will receive a min. 20%% in volume mix of a compost soil amendment. Submittal required. 'Roots' STEP 1 can be substituted for the individual supplements. Install per manufacturer's specs.
- Landscape contractor shall not be responsible for topsoil spreading but shall
 coordinate with the site contractor adherence to the mound grades, plant bed
 soil depths and soil type per dwgs & spec. Landscape contractor shall power
 rake-out for seed.

- Landscape contractor shall provide a soil analysis of the topsoil planting mixture. Analysis to show soil classification (min. sandy loam) and nutrients.
- 24. Contractor shall protect all B&B materials left above grade prior to installation from drying out. All plants shall be stored, covered in mulch, and irrigated until planted. Any plant left on the ground and whose outter ball surface drys out, shall be rejected by the landscape architect. Plants stored in shade and off pavement.
- 25. Plan dictates, contractor shall alert Landscape Architect if any discrepancies exist between the plan, the material list, and as-built site conditions.
- 26. Installer shall notify landscape architect prior to planting, to review plant tocations and bedline configurations. If contractor installs without the placement approval of the L.A., said architect shall have the right to relocate any installed plants at the contractor's expense.
- Installer shall notify landscape architect prior to plant installation to review all
 materials. Any plants of poor condition, improper size, or species will be
 rejected.
- Upon one year review, contractor shall straighten any trees that have shifted.
 Any weak or bare spots in lawn shall be reseeded.
- All bedfines shall have a deep 'V' groove to define lawn to mulch edge. No 'Beehlve' mounding of mulch is allowed, also keep mulch away from base of perennials.
- 30. Do not plant materials too close to the edge of bedlines. Refer to drawings for center of plant to bedline. At a minimum no outter branching of a shrub or perennial shall be closer than two feet from the bedlines. If the as-built does not comply contractor shall adjust the plant location or bedline at his expense.
- Seed mixes include: Sandy Soll Lawn Mix by: deercreekseed.com; New England Wetland Plants, Amherst, Ma. refer to planting plan for designations.
- 32. Any Items not completed to the specifications will be required at contractors expense prior to final approvals. Contractor is to bid the work according to the specifications and not to what they may do under their standard practices. Special attention will be payed to soils, amendments, guy stakes, bedline & saucer configurations, seed mixtures, etc.
- 33. Certain designated foundation edging is rood ballust (washed rounds, non-crushed, natural) Size of stone is a range of 3/4"-4.5"dia. placed to a depth of 3", upon placement apply a coating of granular Preen (preemergent).
- Any questions concerning this drawing shall be directed to Joseph Hochreir c/o Blackwater Design, 85 Frost Lane, Webster, NH 03303, 603-648-2541.

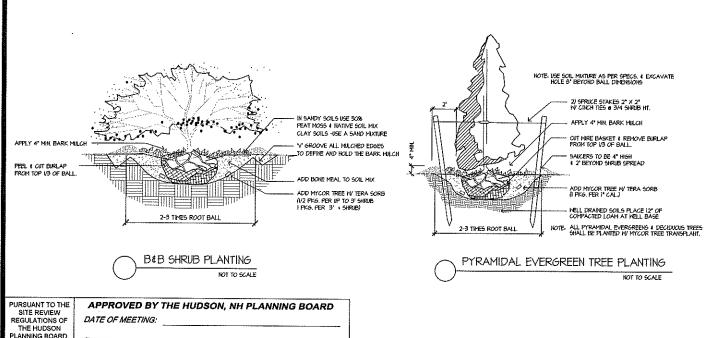

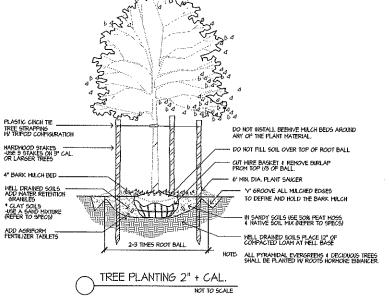

1 0308/22 ADDRESS TOWN, PEER REVIEW COMMENTS

NO. DATE PLAN
(MAP 209, LOT 4)

PROPOSED BUILDING ADDITIONS

22 FRIARS DRIVE
HUDSON, NEW HAMPSHIRE

PREPARED FOR/RECORD OWNER:

INTEGRA BIOSCIENCES CORP.

2 WENTWORTH DRIVE HUDSON, NEW HAMPSHIRE 03051 (603) 578-5800

30 0 30 60 90 120 FEET

15 0 15 30 METERS

27 JANUARY 2022

PREPARED BY:

BLACKWATER DESIGN

PRONE (663) 648 - 650 FAX (603) 648 - 5506

Land Planning - Landscape Architecture

85 Frost Lane - Webster, NH 03303

5734

15 OF 1

DRAWING NAME: 5734 SITE-LISSI

RAWING LOC: J: \5000\5734\DWG\5734 SITE 2021

FIELD BOOK: 1234

THE SITE PLAN APPROVAL

RANTED HEREI

EXPIRES TWO