



<u> </u>		
(REVISIONS:	
REV: DATE:	COMMENT:	ĐY:
1		+
		1
<u> </u>		_
		1
		1
		1
1		1
		
		ŀ
		ـــــ
		Į.
1		ŀ
		+
1		
<u> </u>		
		1
		1
	***************************************	+
		1

DEC. 17, 2021 1"=30" 469-POST-DEVELOPMENT


POST DEVELOPMENT

PROJECT #469 SHEET S2 of S2

GRANITE SUBARU EXPANSION Hudson, New Hampshire






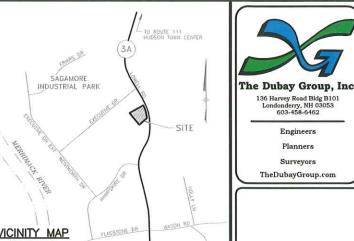

SHEET INDEX

- TITLE SHEET
- EXISTING CONDITIONS PLAN
- SITE PLAN
- GRADING, DRAINAGE, & UTILITY PLAN
- LANDSCAPE PLAN
- LIGHTING PLAN
- **EROSION CONTROL PLAN**
- SITE CONSTRUCTION DETAILS

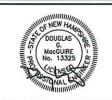

Surveyors

	REVISIONS:	
DATE:	COMMENT:	BY:
		\top
\vdash		_
\Box		\top
-		+-
		Ī
		+
\vdash		+
		_

DRAWN BY: CHECKED BY: DATE: SCALE: FILE: DEED REF: DEC. 17, 2021 NONE

H.C.R.D.: BK. 9403 PG. 2706

GRANITE SUBARU **EXPANSION**

MAP 210 LOT 1 6 EXECUTIVE DRIVE HUDSON, NH 03051

RAYMOND JAMES GRANITE PROP LLC
193 LOWELL RD
HUDSON, NH 03051


SHEET TITLE:


TITLE SHEET


PROJECT #469 SHEET 1 of 10

PURSUANT TO THE SITE REVIEW REGULATIONS OF DATE OF MEETING:

THE HUDSON PLANNING BOARD THE HUDSON, NH PLANNING BOARD THE HUDSON PLANNING BOARD, THE SITE PLAN APPROVAL GRANTED CHAIRMAN SIGN YEARS FROM DATE OF APPROVAL.

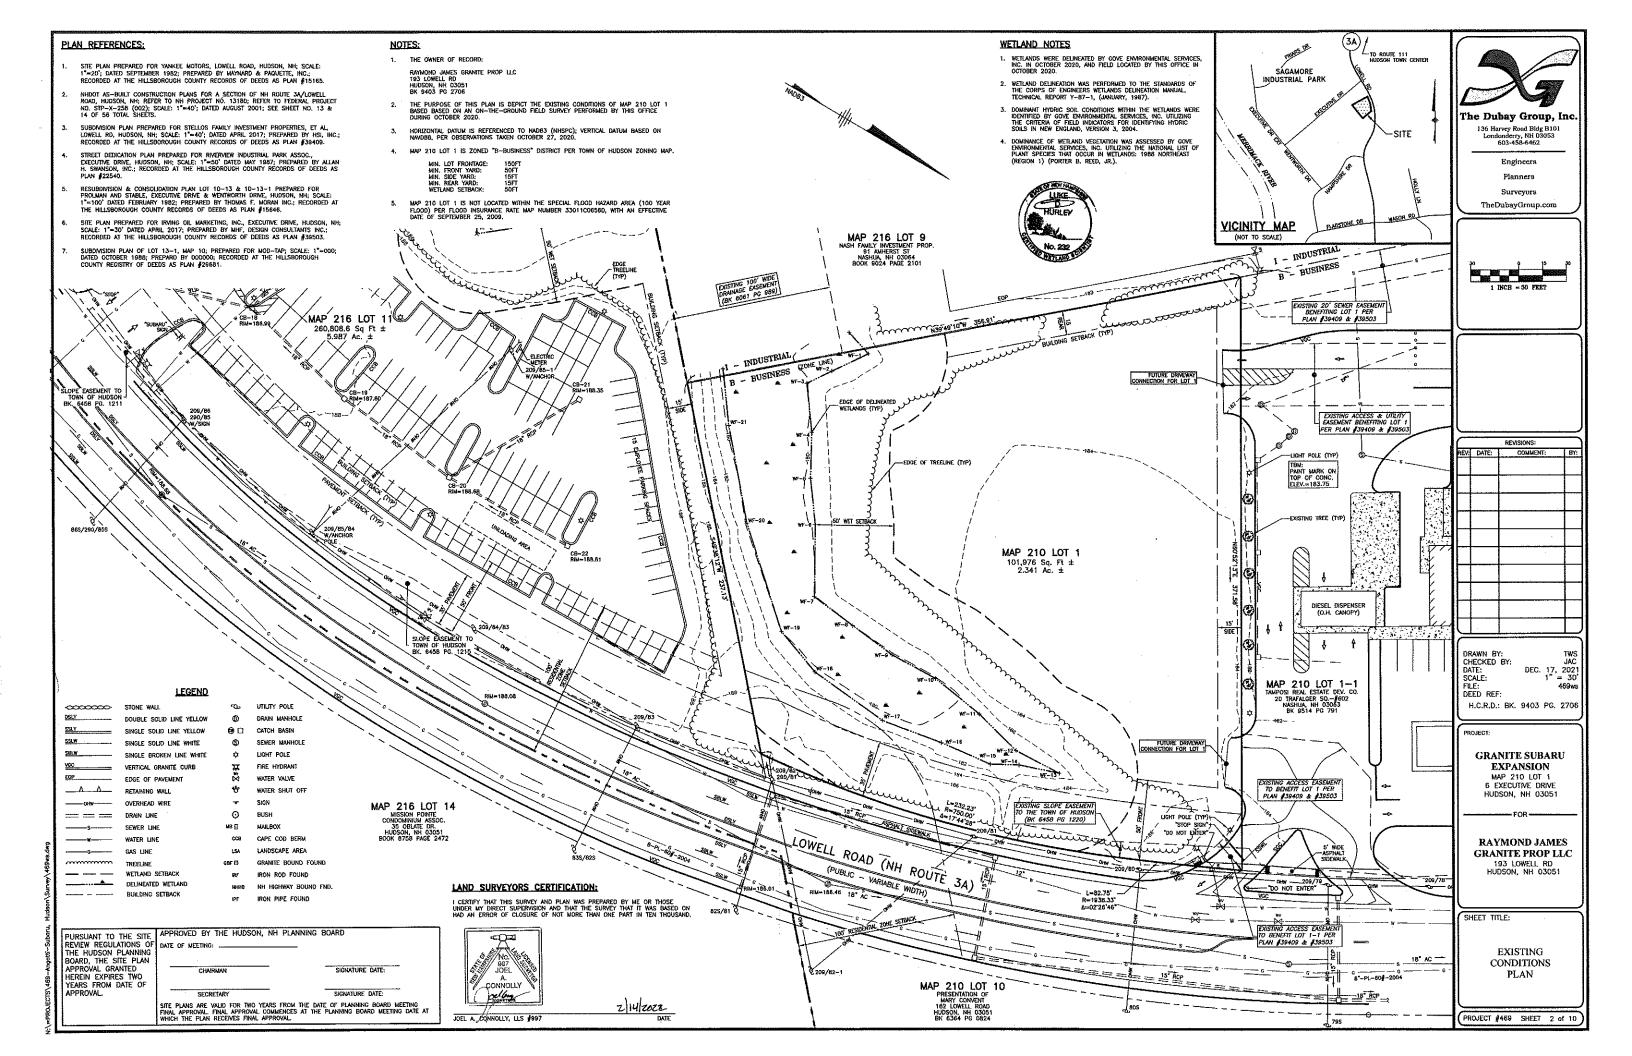


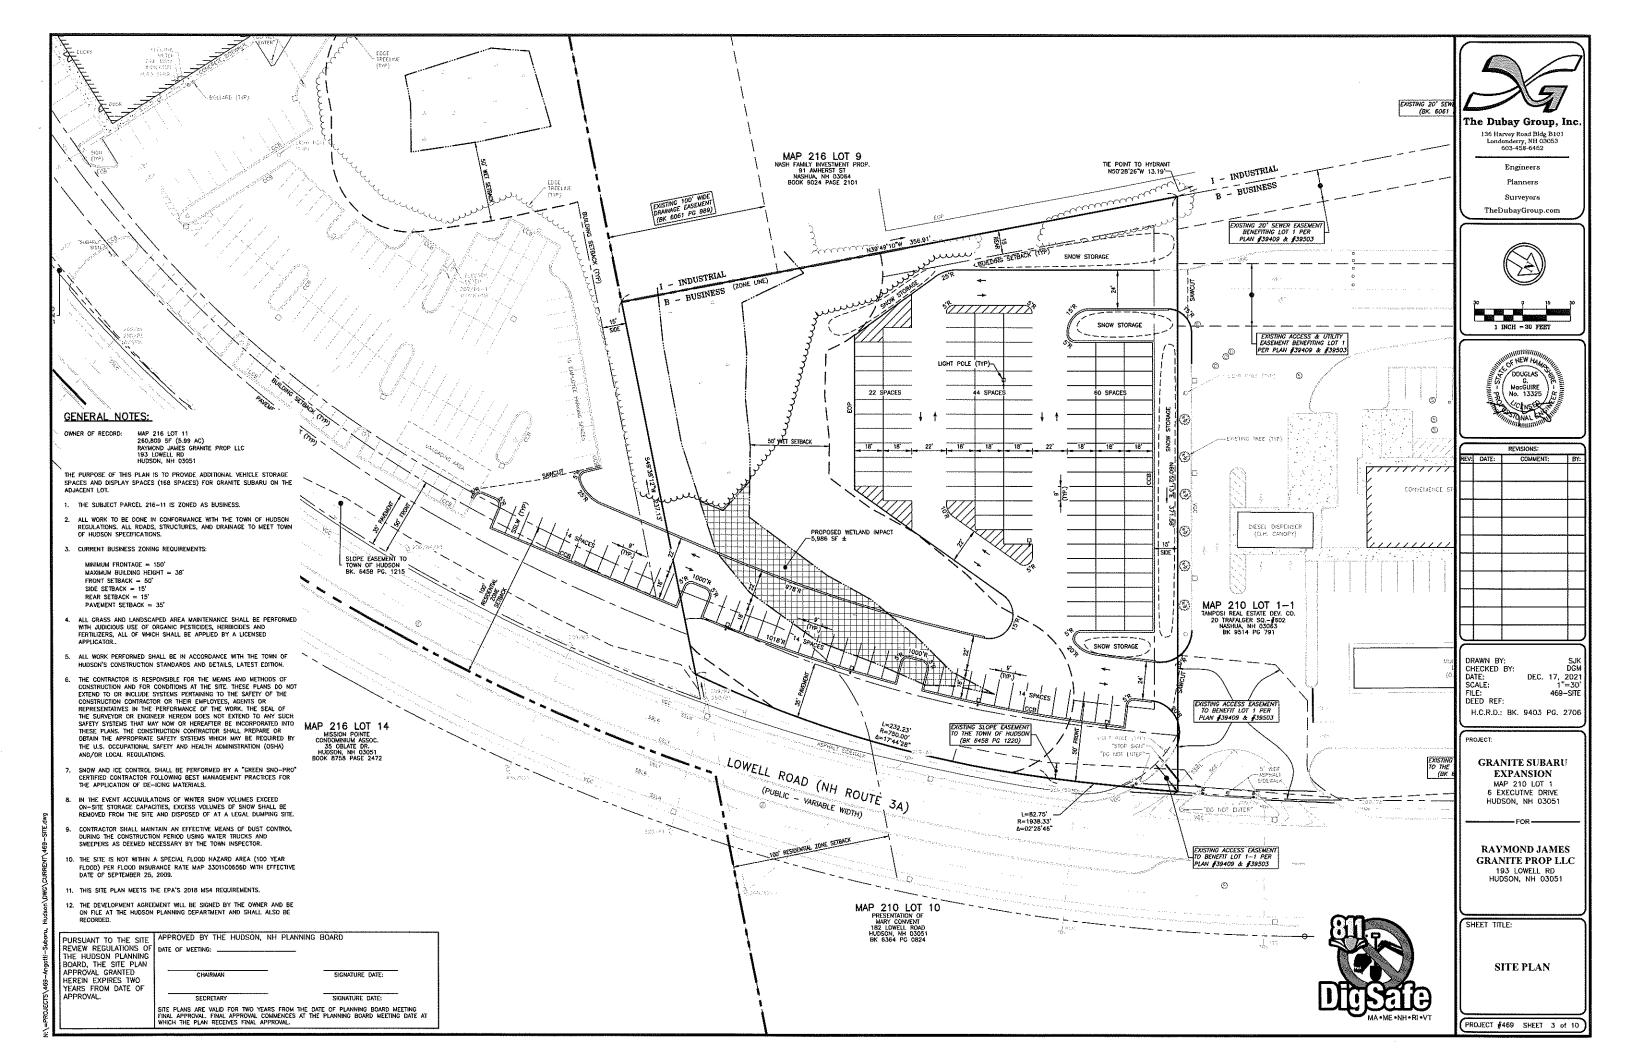

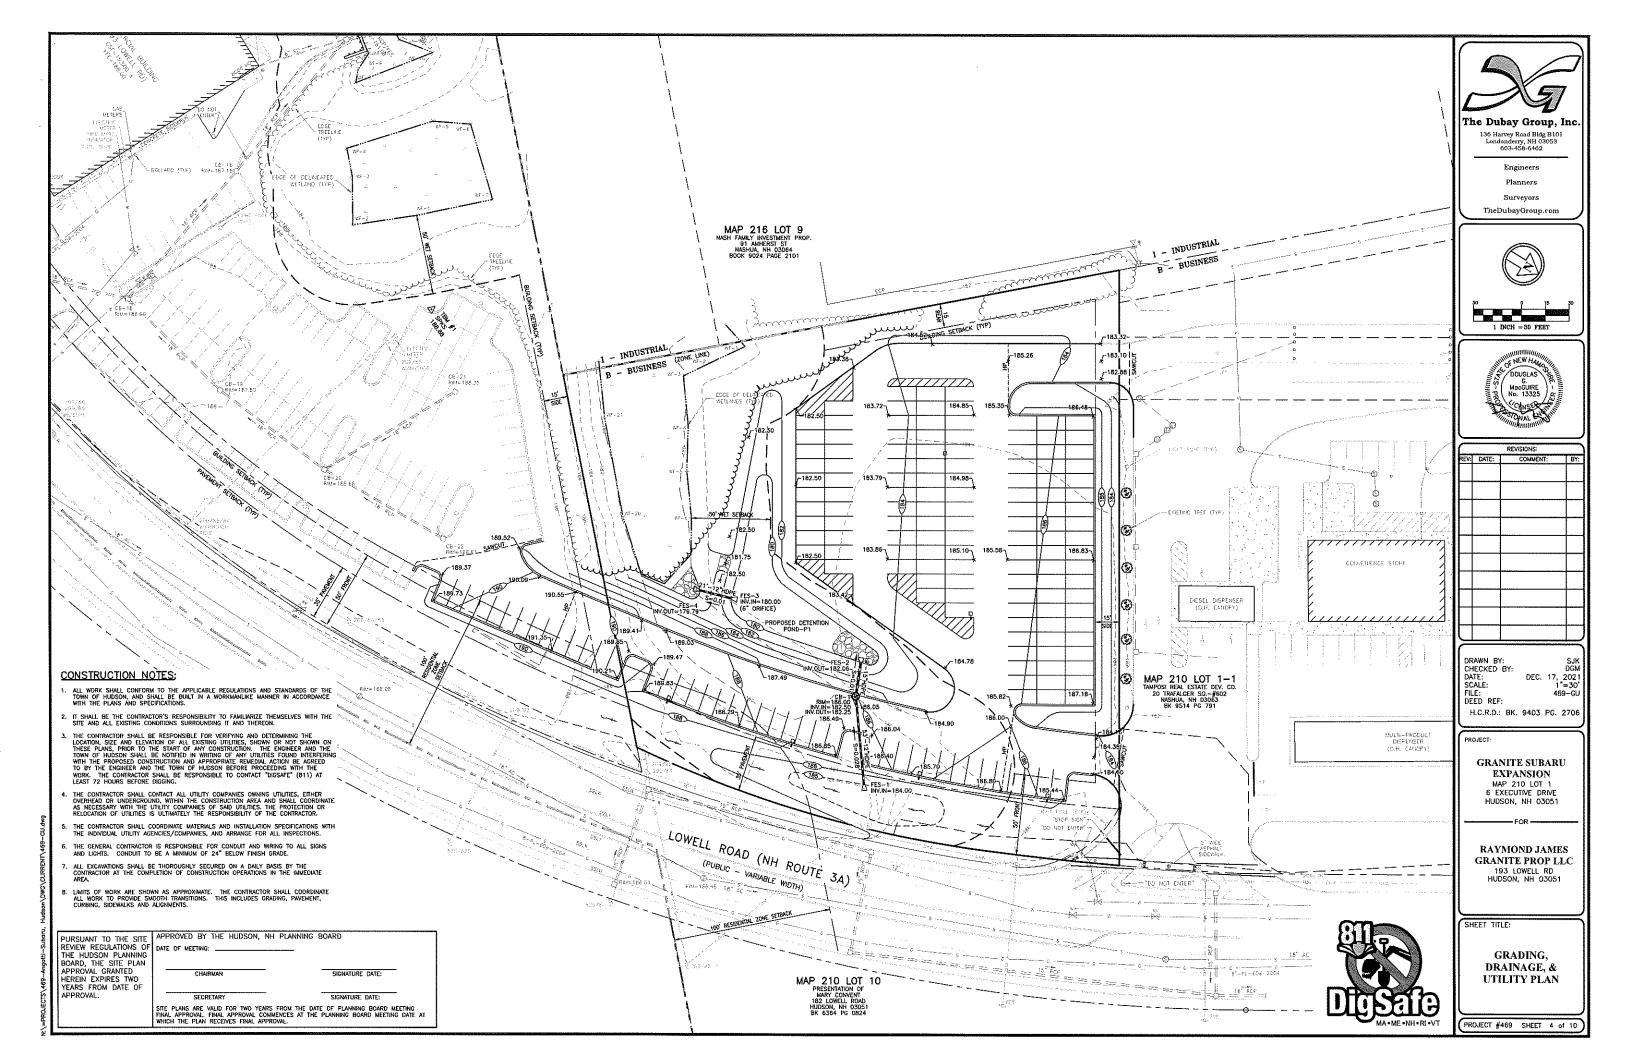

LANDSCAPE NOTES:


- 1. PRIOR TO CONSTRUCTION THE CONTRACTOR IS RESPONSIBLE FOR VERIFICATION OF ALL EXISTING AND NEWLY INSTALLED. UTILITIES AND SHALL NOTIFY THE OWNERS REPRESENTATIVE OF ANY CONFLICTS.
- 2. WHEREVER POSSIBLE EXISTING TREES SHALL BE PRESERVED AND PROTECTED DURING CONSTRUCTION, DISTURBED SIDE SLOPES SHALL BE ALLOWED TO NATURALLY VEGETATE TO SUSTAIN EXISTING WILDLIFE AND PLANT LIFE,
- 3. THE PROPOSED DECIDUOUS TREES SHALL BE A MIN. 2" CALIFER @ 4" ABOVE GRADE, WITH EVERGREENS AT 6" HT.
- 4. ALL DISTURBED AREAS SHALL BE LOAMED AND SEEDED WITH A MINIMUM OF 6° SUITABLE LOAM, EXCEPT UNDER THE MULCH BEDS. SLOPES GREATER THAN 3:1 SHALL BE PROTECTED WITH AN EROSION CONTROL BLANKET. (SEE PLANS BY ENGINEER)
- 5. PLANTS SHALL NOT BE INSTALLED UNTIL ALL GRADING AND CONSTRUCTION HAS BEEN COMPLETED WITHIN THE IMMEDIATE AREA OF THE PLANTING
- G. ALL TREES SHALL BE BALLED AND BURLAF UNLESS OTHERWISE NOTED
- 7. ANY PROPOSED PLANT MATERIAL SUBSTITUTIONS SHALL BE APPROVED BY THE DAMPR'S REPRESENTATIVE AND THE LANDSCAPE ARCHITECT.
- 8. WHERE APPLICABLE THE CONTRACTOR SHALL HAVE ALL FALL TRANSPLANTING HAZARD PLANTS DUG IN THE SPRING. THE CONTRACTOR SHALL BE RESPONSIBLE FOR PLANTING AT CORRECT GRADES AND ALIGNMENT. LAYOUT TO BE APPROVED BY OWNERS REPRESENTATIVE PRIOR TO INSTALLATION.
- 9. PLANTS SHALL BE TYPICAL OF THEIR SPECIES AND VARIETY; HAVE NORMAL GROWTH HABITS; WELL DEVELOPED BRANCHES, DEHSELY FOLIATED, VIGOROUS ROOT SYSTEMS AND BE FREE FROM DEFECTS AND INJURIES.
- 10. CONTRACTOR SHALL REPORT ANY SOIL OF DRAINAGE CONDITIONS CONSIDERED DETRIMENTAL TO THE GROWTH OF PLANT MATERIAL.
- 11. ALL PLANT MATERIAL SHALL BE GUARANTEED BY THE CONTRACTOR TO BE IN VIGOROUS GROWING CONDITION. PROVISION SHALL BE MADE FOR A GROWIN GUARANTEE OF AT LEAST ONE YEAR FROM THE DATE OF ACCEPTANCE FOR TREES AND SHRUBS. REPLACEMENTS SHALL BE MADE AT THE BEGINNING OF THE FIRST SUCCEEDING PLANTING SEASON. ALL REPLACEMENTS SHALL HAVE A GUARANTEE EQUAL TO THAT STATED ABOVE.
- 12. INSOFAR AS IT IS PRACTICABLE, PLANT MATERIAL SHALL BE PLANTED ON THE DAY OF DELIVERY. IN THE EVENT THIS IS NOT POSSIBLE, THE CONTRACTOR SHALL PROTECT STOCK NOT PLANTED. PLANTS SHALL NOT REMAIN UNPLANTED FOR LONGER THAN A THREE DAY PERIOD AFTER DELIVERY. ANY PLANTS NOT INSTALLED DURING THIS PERIOD WILL BE REJECTED.
- 13. QUALITY AND SIZE OF PLANTS, SPREAD OF ROOTS, AND SIZE OF BALLS SHALL BE IN ACCORDANCE WITH ANSI 2GO (REV. 1996) "AMERICAN STANDARD FOR NURSERY STOCK" AS PUBLISHED BY THE AMERICAN ASSOCIATION OF NURSERYMEN, INC.
- 14. ALL PLANTS SHALL BE PLANTED IH AMENDED TOP SOIL THAT IS THOROUGHLY WATERED AND TAMPED AS BACK FILLING PROGRESSES, PLANTING MIX TO BE AS SHOWN ON PLANTING DETAILS. LARGE PLANTING AREAS TO INCORPORATE FERTILIZER AND SOIL CONDITIONERS AS STATED IN PLANTING SPECIFICATIONS.
- 1.5. PLANTS SHALL NOT BE BOUND WITH WIRE OR ROPE AT ANY TIME SO AS TO DAMAGE THE BARK OR BREAK BRANCHES. PLANTS SHALL BE HANDLED FROM THE BOTTOM OF THE BALL
- 16. PLANTING OPERATIONS SHALL BE PERFORMED DURING PERIODS WITHIN THE PLANTING SEASON WHEN WEATHER AND SOIL CONDITIONS ARE SUITABLE AND IN ACCORDANCE WITH ACCEPTED LOCAL PRACTICE. PLANTS SHALL NOT BE INSTALLED IN TOPSOIL THAT IS IN A MUDDY OR PROZEN CONDITION. ALL PLANT MATERIAL SHALL BE SPRAYED WITH WILT-PRUP OR EQUAL AS FOR MANUFACTURERS INSTRUCTIONS.
- 17. NO PLANT, SHALL BE PLANTED LESS THAN 51X FEET FROM EXISTING STRUCTURES.
- 18. SET ALL PLANTS PLUMB AND STRAIGHT. SET AT SUCH LEVEL THAT, A NORMAL OR NATURAL RELATIONSHIP TO THE CROWN OF THE PLANT WITH THE GROUND SURFACE WILL BE ESTABLISHED. LOCATE PLANT IN THE CENTER OF THE PIT.
- 19. ALL PLANTING BEDS SHALL BE MULCHED WITH 4" LAYER OF DOUBLE SHREDDED HARDWOOD BARK MULCH.
- 20. NO SOIL CONTAINING ANY LIVING OR VIABLE PORTION OF PLANTS ON THE NEW HAMPSHIRE PROHIBITED INVASIVE SPECIES LIST (AGR TABLE 3800) SHALL BE TRANSPORTED TO OR FROM CONSTRUCTION SITES WITHOUT NOTIFICATION AND APPROVAL FROM THE NEW HAMPSHIRE DEPT, OF AGRICULTURE PER RSA 430:55.

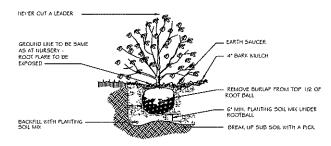

SHRUB PLANTING DETAIL

DECIDUOUS TREE PLANTING DETAIL



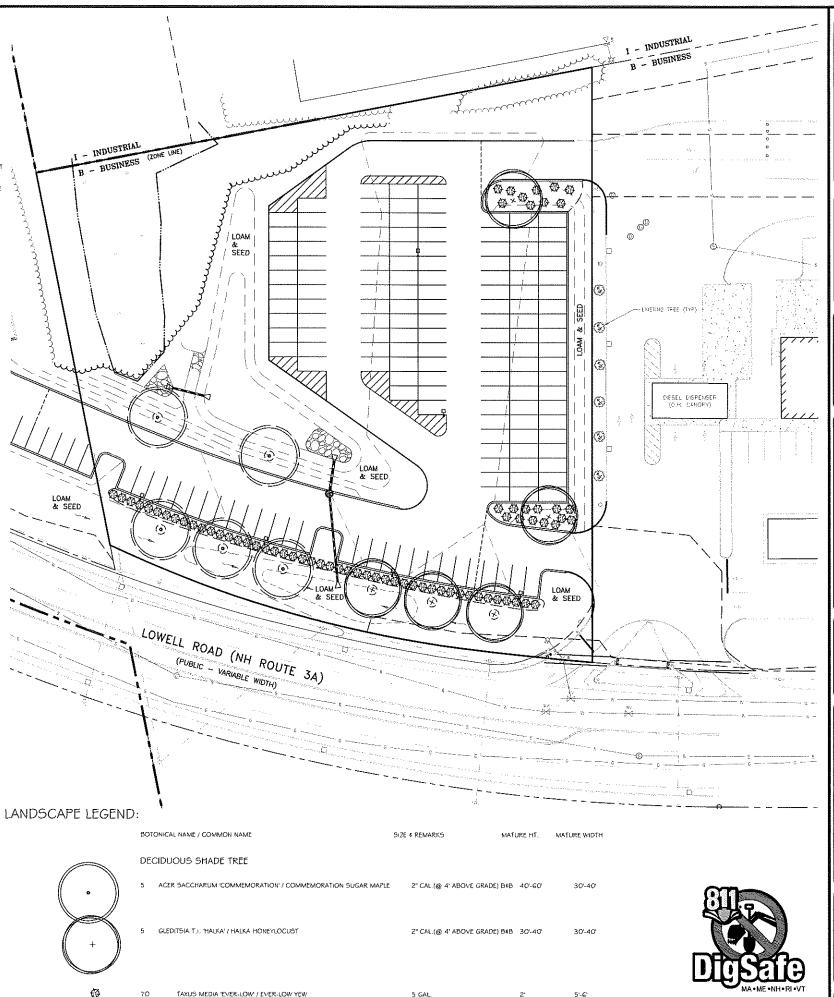



The Dubay Group, Inc

136 Harvey Road Bldg B101 Londonderry, NH 03053 603-458-6462

Engineers

Planners

Surveyors
The Dubay Group. c



30 0 15

REVISIONS: : COMMENT:

REV. DATE: COMMENT: E

DRAWN BY: REK
CHECKED BY: DEC. 17, 2021
SCALE: DEC. 17, 2021
1 = 30'

FILE: 469-LANDSCAPE DEED REF: H.C.R.D.: BK, 9403 PG, 2706

ROJECT:

GRANITE SUBARU

EXPANSION
MAP 210 LOT 1
6 EXECUTIVE DRIVE
HUDSON, NH 03051


— FOR ----

RAYMOND JAMES GRANITE PROP LLC 193 LOWELL RD HUDSON, NH 03051

SHEET TITLE:

LANDSCAPE PLAN

PROJECT #469 SHEET 5 of 10

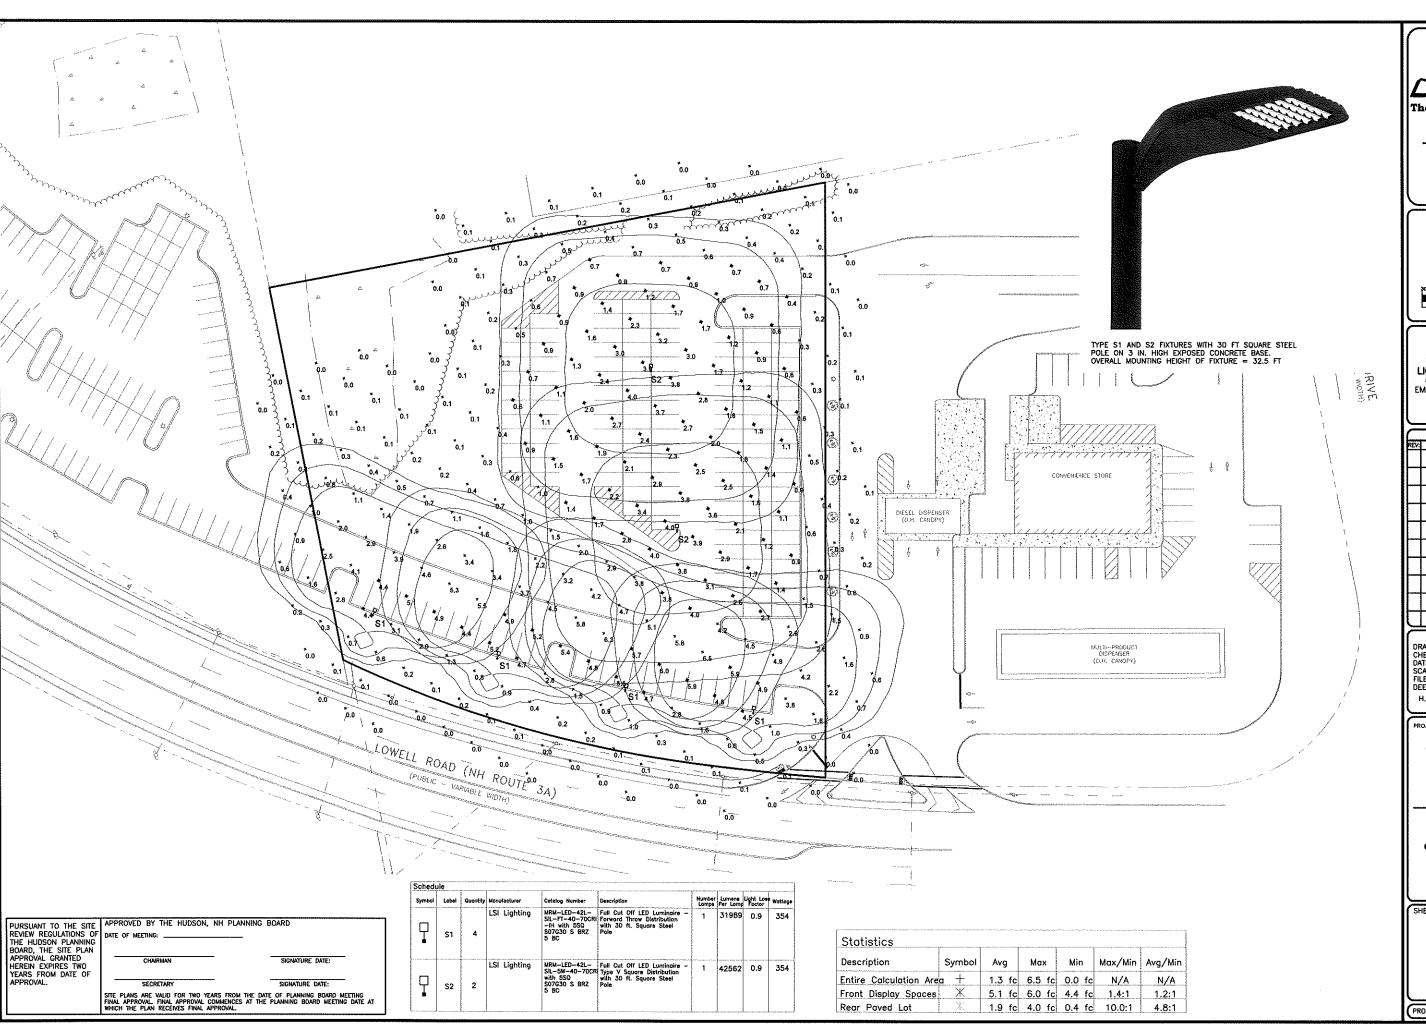



The Dubay Group, Inc

136 Harvey Road Bldg B101 Londonderry, NH 03053 603-458-6462

Engineers

Planners

Surveyors







PHILIP J. INFURNA LIGHTING CONSULTANT CELL: 774-212-7981 EMAIL: pinfurna@gmail.com

	REVISIONS:			
REV:	DATE:	COMMENT:	BY:	

DRAWN BY: SJK
CHECKED BY: DGM
DATE: DEC. 17, 2021
SCALE: 1"=30'
FILE: 469-LIGHTING
DEED REF:

H.C.R.D.; BK. 9403 PG. 2706

PROJECT:

GRANITE SUBARU EXPANSION

MAP 210 LOT 1 6 EXECUTIVE DRIVE HUDSON, NH 03051


--- FOR ----

RAYMOND JAMES GRANITE PROP LLC 193 LOWELL RD HUDSON, NH 03051


SHEET TITLE:

LIGHTING PLAN


PROJECT #469 SHEET 6 of 10

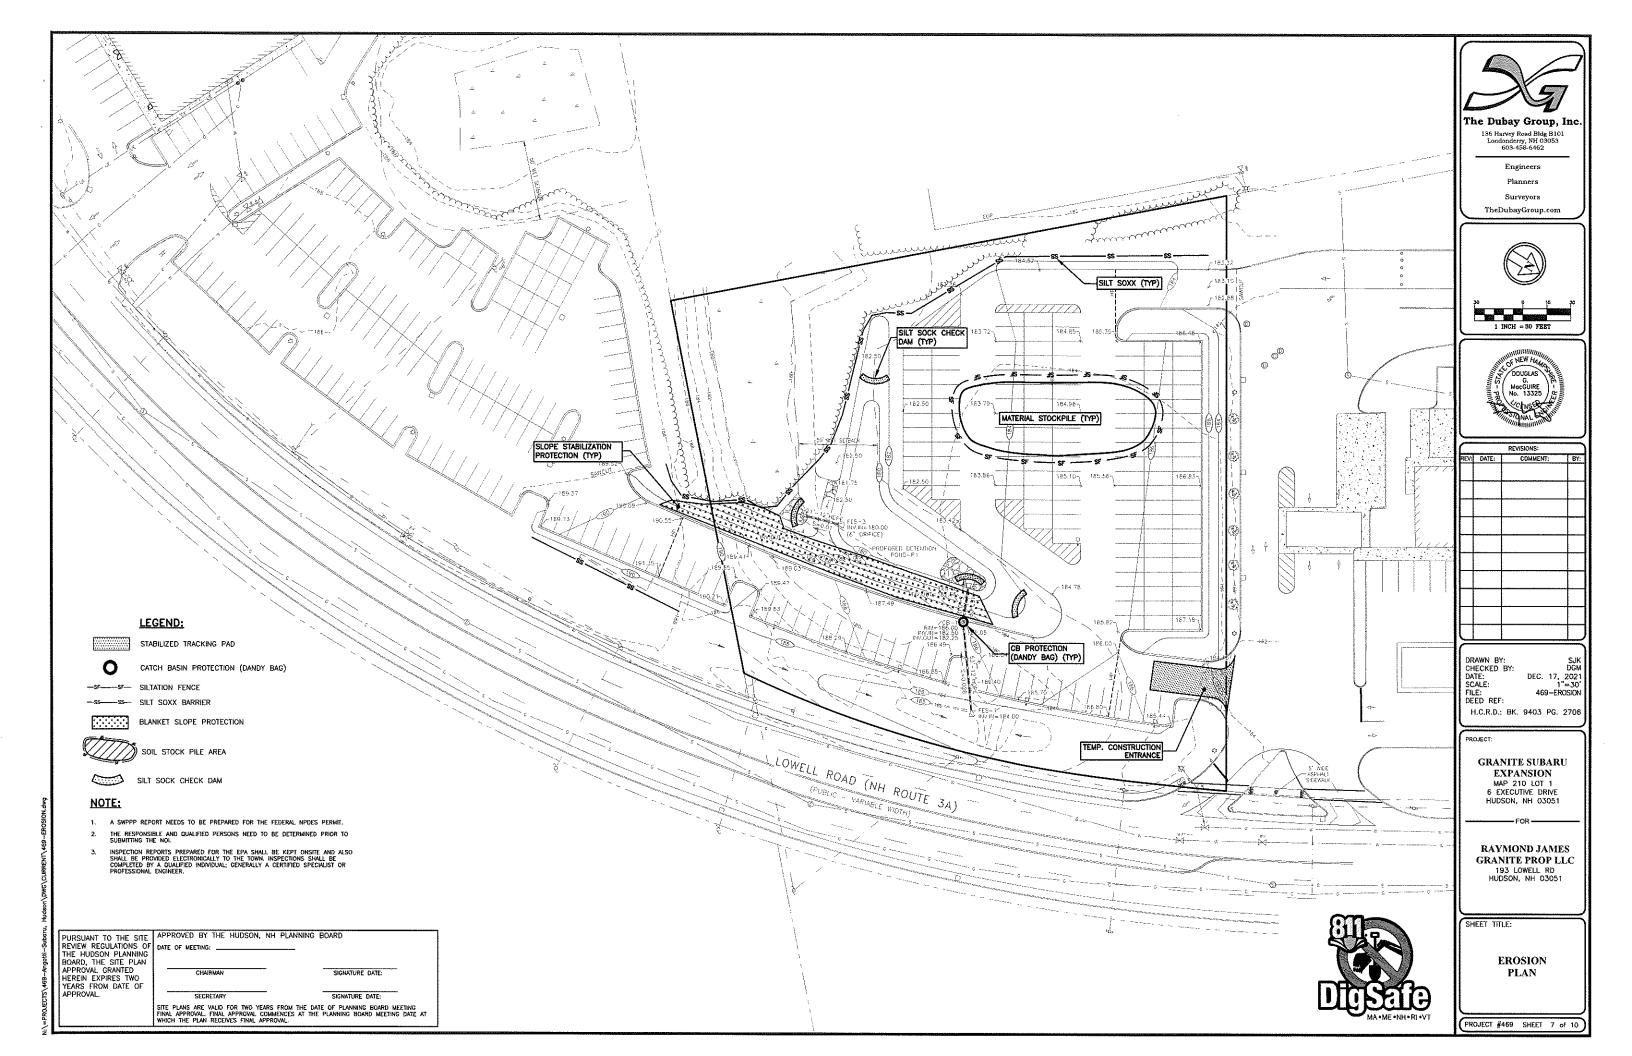

SILT SOCK DETAIL

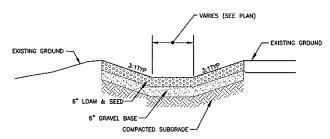

TYPICAL GRASS LINED SWALE NOT TO SCALE

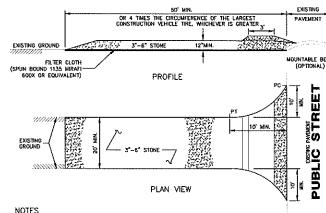


1. FILTER CLOTH - WILL SE PLACED OVER THE ENTIRE AREA PRIOR TO PLACING OF STONE SURFACE

- 3. MAINTENANCE THE ENTRANCE SHALL BE MAINTAINED IN A CONDITION WHICH WILL PREVENT TRACKING OR FLOWING OF SEDMENT ONTO PUBLIC RIGHTS-OF-MAY. THIS MAY REQUIRE PERIODIC TOP DRESSING WITH ADDITIONAL STONE AS CONDITIONS DEBAND AND REPAIR AND/OR CLEANOUT OF ANY MEASURES USED TO TRAP SEDMENT. ALL SEDMENT SPILED, DROPPED, WASHED OR TRACKED ONTO PUBLIC RIGHTS-OF-WAY MUST BE REMOVED IMMEDIATELY.
- 4. WASHING WHEELS SHALL BE CLEANED TO RELOVE SEDIMENT PRIOR TO ENTRANCE ONTO PUBLIC RIGHTS—OF—WAY. WHEN WASHING IS REQUIRED, IT SHALL BE DONE ON AN AREA STABILIZED WITH STONE AND WHICH DORAINS INTO AN APPROVED SEDIMENT TRAPPING DEVICE.
- 5. PERIODIC INSPECTION AND NEEDED MAINTENANCE SHALL BE PROVIDED AFTER EACH RAIN STORM EVENT

USDA-SCS STABILIZED TRACKING PAD


BOARD, THE SITE PLAN APPROVAL GRANTED HEREIN EXPIRES TW YEARS FROM DATE OF


PURSUANT TO THE SITE APPROVED BY THE HUDSON, NH PLANNING BOARD REVIEW REGULATIONS OF DATE OF MEETING: SIGNATURE DATE: SECRETARY SIGNATURE DATE: SITE PLANS ARE VALID FOR TWO YEARS FROM THE DATE OF PLANNING BOARD MEETING FINAL APPROVAL. FINAL APPROVAL COMMENCES AT THE PLANNING BOARD MEETING DATE AT WHICH THE PLAN RECEIVES FINAL APPROVAL.

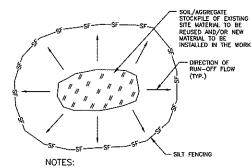

- 1. ALL EXISTING EXCAVATED MATERIAL THAT IS NOT TO BE REUSED IN THE WORK IS TO BE IMMEDIATELY REMOVED FROM THE SITE AND PROPERLY DISPOSED OF.
- 3. STOCKPILE HEIGHTS MUST NOT EXCEED 35°. STOCKPILE SLOPES MUST BE 2:1 OR FLATTER.

MATERIALS STOCKPILE DETAIL

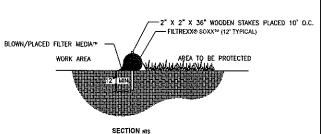

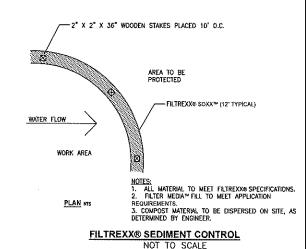



TIEM 641.04 6° ROLLED LOAM & SEED 642. LIMESTONE 643.11 FERTHIZER

LOAM & SEED DETAIL

EROSION CONTROL NOTES

CONSTRUCTION SEQUENCE

- PRIOR TO CONSTRUCTION, AN INITIAL PRE CONSTRUCTION MEETING(S) SHALL TAKE PLACE WITH THE CONTRACTOR, DWNER, AND TOWN AGENTS.
- THIS SITE WILL REQUIRE A USEPA NPDES PERMIT FOR STORMWATER DISCHARGE FOR THE SITE CONSTRUCTION SINCE THE DISTURBANCE EXCEEDS ONE ACRE. THE CONSTRUCTION SITE OPERATOR SHALL DEVELOP AND IMPLEMENT A CONSTRUCTION STORMWATER POLLUTION PREVENTION PLAN (SWPPP), WHICH SHALL REMAIN ON SITE AND MADE ACCESSIBLE TO THE PUBLIC. A COMPLETED NOTICE OF TERMINATION (NOT) SHALL BE SUBMITTED TO NPDES PERMITTING AUTHORITY WITHIN 30 DAYS AFTER EITHER OF THE FOLLOWING CONDITIONS HAVE BEEN MET: FINAL STABILIZATION HAS BEEN ACHIEVED DN ALL PORTIONS OF THE SITE FOR WHICH THE PERMITTED IS RESPONSIBLE; OR ANOTHER OPERATOR/PERMITTEE HAS ASSUMED CONTROL OVER ALL AREAS OF THE SITE THAT HAVE NOT BEEN FINALLY STABILIZED.
- INSTALL PERIMETER CONTROLS, I.E SILT FENCE AND/OR SILTSOXX AROUND THE LIMITS OF DISTURBANCE BEFORE ANY EARTH MOVING OPERATION.
- 4. CONSTRUCT TEMPORARY CONSTRUCTION EXIT.
- 5. CLEAR AND GRUB WITHIN AREAS OF DISTURBANCE UNLESS DTHERWISE NOTED.
- REMOVE AND STOCKPILE MATERIALS AS REQUIRED. STOCKPILE SHALL BE SURROUNDED WITH AN EROSION CONTROL DEVICE TO PREVENT EROSION. STOCKPILE AREAS ARE LIMITED AND THUS MANAGEMENT OF MATERIALS WILL BE REQUIRED.
- 7. SHAPE PROPOSED DRAINAGE PONDS, DITCHES AND/OR SWALES.
- 8. PERFORM ROUGH SITE GRADING, INSTALL DRAINAGE SYSTEMS AND UTILITIES.
- INSTALL UNDERGROUND UTILITIES AND PLACE EROSION CONTROL MEASURES AROUND ANY CATCH BASINS PRIOR TO DIRECTING ANY RUNOFF TO THEM. DRAINAGE SYSTEMS SHALL BE CONSTRUCTED AND STABILIZED PRIOR TO DIRECTING ANY FLOW TO THEM. ALL SIDE SLOPES SHALL BE STABILIZED WITHIN 72 HOURS.
- 10. LAYOUT AND INSTALL ALL BURIED UTILITIES AND SERVICES UP TO 10' OF THE PROPOSED BUILDING FOUNDATIONS. CAP AND MARK TERMINATIONS OR LOG SWING TIES.
- FINISH GRADE SITE, BACKFILL ROAD SUBBASE GRAVEL IN TWO, COMPACTED LIFTS. PROVIDE TEMPORARY EROSION PROTECTION TO DITCHES AND SWALES WHERE APPLICABLE, IN THE FORM OF MULCHING, JUTE MATTING OR STONE CHECK DAMS.
- 12. INSTALL EXTERIOR LIGHT POLE BASES, AND MAKE FINAL CONNECTIONS TO CONDUIT.
- 13. ANY PERMANENT DITCHES AND SWALES SHALL BE STABILIZED PRIOR TO DIRECTING RUNOFF TO THEM.
- 14. PLACE BINDER LAYER OF PAVEMENT, THEN RAISE CATCH BASIN FRAMES TO FINAL GRADE. REINSTALL BASIN INLET PROTECTION.
- 15. AFTER ALL DRAINAGE AND ROADWAY IMPROVEMENTS (NOT INCLUDING FINAL LAYER OF PAVEMENT) HAVE BEEN COMPLETED, BEGIN CONSTRUCTION OF THE BUILDING FOUNDATIONS AND CONNECT TO SITE UTILITIES. BEGIN BUILDING CONSTRUCTION.
- PLANT LANDSCAPING IN AREAS OUT OF WAY OF BUILDING CONSTRUCTION. PREPARE AND STABILIZE FINAL SITE GRADING BY ADDING TOPSOIL, SEED, MULCH AND FERTILIZER.
- 17. AFTER BUILDINGS ARE COMPLETED, FINISH ALL REMAINING LANDSCAPED WORK.
- 19. REMOVE TRAPPED SEDIMENTS FROM COLLECTION DEVICES AS APPROPRIATE, AND THEN REMOVE TEMPORARY EROSION CONTROL MEASURES UPON COMPLETION OF FINAL STABILIZATION OF THE SITE.

GENERAL CONSTRUCTION NOTES

- THE TEMPORARY BMPS ASSOCIATED WITH THIS PROJECT WILL BE THE RESPONSIBILITY OF THE CONTRACTOR AND LANDOWNER, WHO WILL BE RESPONSIBLE FOR INSPECTION, OPERATION, AND
- 2. EROSION CONTROL PROCEDURES SHALL CONFORM TO SECTION 645 OF THE "STANDARD SPECIFICATION FOR ROAD AND BRIDGE CONSTRUCTION OF THE NHIODT". EROSION CONTROL SHALL BE INSTALLED DOWNHILL OF ALL AREAS WHERE WORK WILL EXPOSE UNPROTECTED SOIL TO PREVENT SEDIMENT FROM EMPERING CATCH BASINS, DRAINAGE STRUCTURES AND/OR DRAINAGE WAYS. INSTALL TEMPORARY SEDIMENT AND EROSION CONTROL MEASURES PRIOR TO ANY EARTH MOVING OPERATIONS. THE CONTRACTOR SHALL MANGE THE PROJECT IN A MANNER THAT MEETS THE REQUIREMENTS AND INTENT OF RSA 430:53 AND CHAPTER AGR 3800 RELATIVE TO INVASIVE SPECIES.
- ALL DISTURBED AREAS WHICH ARE FINISH GRADED SHALL BE LOAMED (6" MINIMUM) AND SEEDED. SEE SEEDING AND FERTILIZER SPECIFICATION. SEE SLOPE DESIGN AND/OR LANDSCAPE PLAN FOR ADDITIONAL
- TURBED AREAS WHICH ARE TO BE LEFT TEMPORARILY, AND WHICH WILL BE REGRADED LATER BE MACHINED STRAW MULCHED AND SEEDED WITH SLOPE STABILIZATION SEED MIXTURE TO SHALL BE MACHINED STRAW MULCHED AND SEEDED WITH SLOPE STABILIZATION PREVENT EROSION. STRAW MULCH SHALL BE APPLIED AT A RATE OF 2 TONS/ACRE.
- ALL DRAINAGE SYSTEMS (DITCHES, SWALES, DRAINAGE PONDS/BASINS, ETC.) SHALL BE STABILIZED PRIOR TO DIRECTING RUNOFF TO THEM. STORMWATER FLOWS ARE NOT TO BE DIRECTED TO THESE SYSTEMS UNTIL. CONTRIBUTION AREAS HAVE ALSO BEEN FULLY STABILIZED.
- CONTRACTOR SHALL PROVIDE DUST CONTROL MEASURES IN ACCORDANCE WITH NHDES, EPA & TOWN REQUIREMENTS FOR THE DURATION OF THE PROJECT. WATER FOR DUST CONTROL SHALL BE PROVIDED ON SITE. FUGITIVE DUST IS CONTROLLED IN ACCORDANCE WITH ENV-A 1000.
- ALL EROSION CONTROLS ARE TO BE INSPECTED WEEKLY AND AFTER 0.5" OR GREATER OF RAINFALL WITHIN A 24 HOUR PERIOD.
- ALL FILLS SHALL BE PLACED AND COMPACTED TO 90% MODIFIED PROCTOR DENSITY IN LAYERS NOT EXCEEDING 18 INCHES IN THICKNESS UNLESS OTHERWISE NOTED. FILL MATERIAL SHALL BE FREE FROM STUMPS, WOOD, ROOTS, ETC. AND SHALL NOT BE PLACED ON FROZEN FOUNDATION SUBGRADE.
- 10. Silt fences and/or siltsoxx shall be periodically inspected during the life of the project and after each storm. All damaged silt fences and/or siltsoxx shall be repaired, sediment deposits shall periodically be removed and disposed in a secure location.
- 11. PAVED AREAS MUST BE KEPT CLEAN AT ALL TIMES.
- 12. ALL DEWATERING OPERATIONS MUST DISCHARGE DIRECTLY INTO A SEDIMENT FILTER AREA
- 13. THE SMALLEST PRACTICAL AREA SHALL BE DISTURBED DURING CONSTRUCTION, BUT IN NO CASE SHALL EXCEED 5 ACRES AT ANY ONE TIME BEFORE DISTURBED AREAS ARE STABILIZED, ALL DISTURBED AREAS SHALL BE STABILIZED WITHIN 72 HOURS AFTER FINAL GRADING, EXPOSURE OF UNISTABILIZED SORIS SHALL BE TEMPORABILY STABILIZED AS SOON AS POSSIBLE BUT NO LATER THAN 45 DAYS OF INITIAL DESTRUBENCE.
- 14. WINTERIZATION EFFORTS FOR AREAS NOT STABILIZED BY NOV. 1ST SHALL BE MADE BY THE APPROPRIATE USE OF MATTING, BLANKETS, MULCH AND SEEDING.
- 15. AN AREA SHALL BE CONSIDERED STABLE IF ONE OF THE FOLLOWING HAS OCCURRED: A. BASE COURSE GRAVELS HAS BEEN INSTALLED IN AREAS TO BE PAVED;

- B. A MINIMUM OF B5% VEGETATED GROWTH HAS BEEN ESTABLISHED:
- C. A MINIMUM OF 3" OF NON-EROSIVE MATERIAL SUCH AS STONE OR RIP RAP HAS BEEN INSTALLED; OR
- 16. IF, DURING CONSTRUCTION, IT BECOMES APPARENT THAT ADDITIONAL EROSION CONTROL MEASURES ARE REQUIRED TO STOP ANY EROSION ON THE CONSTRUCTION SITE DUE TO ACTUAL SITE CONDITIONS THE CONTRACTOR SHALL BE REQUIRED TO IMMEDIATELY INSTALL AND MAINTAIN THE NECESSARY EROSION

SEEDING SPECIFICATION

- 1. TEMPORARY SEED
- A. TEMPORARY VEGETATIVE COVER SHOULD BE APPLIED WHERE EXPOSED SOIL SURFACES WILL NOT BE FINAL GRADED WITHIN 45 DAYS.
- B. SEED BED PREPARATION SHALL BE IN ACCORDANCE WITH THE NHDES STORMWATER MANUAL. VOLUME 3, TEMPORARY VEGETATION SECTION.
- C. SEEDING MIXTURE

JEEDHIO MIN	13 Dist.		
MIXTURE	SPECIES	POUNDS PER ACRE	POUNDS PER 1,000 SQ.
	WINTER RYE	112	2.50
	OATS	80	2.00
	ANNUAL RYEGRASS	40	1.00
	PERENNIAL RYEGRASS	30	0.17

- A. SPRING SEEDING USUALLY GIVES THE BEST RESULTS FOR ALL SEED MIXES OR WITH LEGUMES.
- B. PERMANENT SEEDING SHOULD BE COMPLETED 45 DAYS PRIOR TO THE FIRST KILLING FROST. IF SEEDING CANNOT BE DONE WITHIN THE SPECIFIED SEEDING DATES, MULCH ACCORDING TO THE NEW HAMPSHIRE STORMWATER MANAGEMENT MANUAL, VOLUME 3, CONSTRUCTION PHASE EROSION AND SEDIMENT CONTROLS AND DELAY SEEDING WITH THE NEXT RECOMMENDED SEEDING PERIOR.
- A. STONES AND TRASH SHOULD BE REMOVED FROM LOAMED AREAS SO AS NOT TO INTERFERE WITH THE SEEDING PROCESS.
- B. WHERE THE SOIL HAS BEEN COMPACTED BY CONSTRUCTION OPERATIONS, LOOSEN SOIL TO A DEPTH OF 2 INCHES BEFORE APPLYING FERTILIZER, LIME AND SEED.
- C. IF APPLICABLE, FERTILIZER AND ORGANIC SOIL AMENDMENTS SHOULD BE APPLIED DURING THE GROWING
- D. APPLY LIMESTONE AND FERTILIZER ACCORDING TO SOIL TEST RECOMMENDATIONS. IF SOIL TESTING IS NOT FEASIBLE ON SMALL OR VARIABLE SITES, OR WHERE TIMING IS CRITICAL, FERTILIZER MAY BE APPLIED AT THE RATE OF 500 POUNDS PER ACRE OR 13.8 POUNDS PER 1,000 SOUARE FEET OF LOW PHOSPHATE FERTILIZER (N-PSOS-XZD) OR EQUIVALENT, APPLY LIMESTONE (EQUIVALENT TO 50 PERCENT CALCIUM PLUS MAGNESIUM OXIDE) AT A RATE OF 3 TONS PER ACRE (138 LB. PER 1,000 CONTENTS OF THE PSOS ACRE OF SOUARE FEET).
- E. FERTILIZER SHOULD BE RESTRICTED TO A LOW PHOSPHATE, SLOW RELEASE NITROGEN FERTILIZER
- SEED SHOULD BE SPREAD UNIFORMLY BY A METHOD MOST APPROPRIATE FOR THE SITE. METHODS INCLUDING HAND, CYCLONE SEEDER, DRILL, CULTIPACKER TYPE SEEDER OR HYDROSEEDER.
- A. INOCULATE ALL LEGUME SEED WITH THE CORRECT TYPE AND AMOUNT OF INOCULANTS.
- B. NORMAL SEEDING DEPTH IS FROM % TO % INCH. HYDROSEEDING THAT INCLUDES MULCH MAY BE LEFT
- ON SOL SUFFACE. SEEDING RATES MUST BE INCREASED 10 % WHEN HYDROSEDING.

 C. WHERE FEASIBLE, EXCEPT WHERE EITHER A CULTIPACKER TYPE SEEDER OR HYDROSEDER IS USED,
 THE SEEDBED SHOULD BE FIRMED FOLLOWING SEEDING OPERATIONS WITH A ROLLER, OR LIGHT DRAG.

MIXTURE	SPECIES	POUNDS PER ACRE	POUNDS PER 1,000 SQ. FT.
A	TALL FESCUE	45	1.04
	CREEPING RED FESCUE	45	1.04
	REDTOP	7	0,12
	TOTAL	07	2.22

- 5. ALTERNATE PERMANENT SEEDING FOR AREAS NOT RECEIVING LAWN OR LANDSCAPING SHALL BE AS FOLLOWS:
- A. THE NEW ENGLAND EROSION CONTROL/RESTORATION MIX CONTAINS A SELECTION OF NATIVE GRASSES THE NEW ENGLAND ENCISION CONTROL, RESTORATION MOX CONTAINS A SELECTION OF MATIVE GRASSES WHERE AND WILDFLOWERS DESIGNED TO COLONIZE GENERALLY MOIST, RECENTLY DISTURBED SITES WHERE QUICK GROWTH OF VEGETATION IS DESIRED TO STABILIZE THE SOIL SURFACE. THIS MIX IS PARTICULARLY APPROPRIATE FOR DETERMINEND ASSIMILATION FOR THE PLANTS IN THIS MIX CAN TOLERATE INFROUENT INJUNCATION, BUT NOT CONSTANT FLOODING. IN NEW ENGLAND, THE BEST RESULTS ARE OBTAINED WITH A SPRING OF RARLY FALL SEEDING. SUMMER AND FALL SEEDING CAN BE SUCCESSFUL WITH A LIGHT MULCHING OF WEED-FREE STRAW TO CONSERVE MOISTURE. LATE FALL AND WINTER DORMANT SEEDING REQUIRED LIGHT INCREASE IN THE SEEDING RATE. FERTILIZATION IS NOT REQUIRED UNLESS THE SOILS ARE PARTICULARLY INFERTILE.
- C. SPECIES: SWITCHGRASS (PANICUM VIRGATUM), CREEPING RED FESCUE (FESTUCA RUBRA), VIRGINIA WILD
 RYE (ELYMUS VIRGINICUS), FOX SEDGE (CAREX VULPINICIDEA), CREEPING BENTGRASS (AGROSTIS
 STOLONIFERA), SILKY WILD RYE (ELYMUS VILLOSUS), NODDING BUR-MARIGOLD (BIDENS CERNUA), SOFT RUSH (JUNCUS EFFUSIS), GRASS-LEAVED GOLDENROD (SOLIDAGO GRAMINFOLIA), SENSITIVE FERN (ONOCLEA SENSIBILIS), JOE-PYE WEED (EUPATORIUM MACULATUM), BONESET (EUPATORIUM PERFOLIATUM), FLAT-TOP ASTER (ASTER DIMBELLATUS), NEW YORK ASTER (ASTER NOVI-BELGII), BLUE VERVAIN (VERBENA HASTATA).

- 1. ALL PROPOSED VEGETATED AREAS WHICH DO NOT EXHIBIT A MINIMUM OF 85% VEGETATIVE GROWTH 1 OCTOBER 15TH, OR WHICH ARE DISTURBED AFTER COTOBER 15TH, SHALL BE STRAILUZED BY SEED AND INSTALLING EROSION CONTROL BLANKETS ON SLOPES GREATER THAN 3:1, AND SEEDING AN PLACING 3 TO 4 TONS OF MULCH PER ACRE, SECURED WITH ANCHORED NETTING, ELSEWHERE. TH INSTALLATION OF EROSION CONTROL BLANKETS OR MULCH AND NETTING SHALL NOT COCUR DVI ACCUMULATED SNOW OR ON FROZEN GROUND AND SHALL BE COMPLETED IN ADVANCE OF THAW (SPRING MELT EVENTS).
- ALL AREAS TO BE PLANTED WHICH DO NOT EXHIBIT A MINIMUM OF 85% VEGETATIVE GROWTH BY OCTOBER 15TH, OR WHICH ARE DISTURBED AFTER OCTOBER 15TH, SHALL BE STABILIZED TEMPORARILY WITH STONE OR EROSION CONTROL BLANKETS APPROPRIATE FOR THE DESIGN FLOW CONDITIONS.
- AFTER OCTOBER 15TH, INCOMPLETE SURFACES TO BE PAYED, WHERE WORK HAS STOPPED FOR THE WINTER SEASON, SHALL BE PROTECTED WITH A MINIMUM OF 3 INCHES OF CRUSHED GRAVEL PER NHDOT ITEM 304.3 OR CRUSHED STONE.

MAINTENANCE AND PROTECTION

- 1. THE CONTRACTOR SHALL TAKE WHATEVER MEASURES ARE NECESSARY TO PROTECT THE GRASS WHILE IT
- TO BE ACCEPTABLE, SEEDED AREAS SHALL CONSIST OF A UNIFORM STAND OF AT LEAST 90 PERCENT ESTABLISHED PERMANENT GRASS SPECIES, WITH A UNIFORM COUNT OF AT LEAST 100 PLANTS PER SQUARE FOOT.
- SEEDED AREAS WILL BE FERTILIZED AND RE-SEEDED AS NECESSARY TO INSURE VEGETATIVE ESTABLISHMENT.
- THE SWALES WILL BE CHECKED WEEKLY AND REPAIRED WHEN NECESSARY, UNTIL ADEQUATE VEGETATION IS ESTABLISHED.
- THE SILT FENCE AND/OR SILTSOXX BARRIER SHALL BE CHECKED AFTER EACH RAINFALL AND AT LEAST DAILY DURING PROLONGED RAINFALL.
- SILT FENCE AND/OR SILTSOXX SHALL BE REMOVED ONCE VEGETATION IS ESTABLISHED, AND DISTURBED AREAS RESULTING FROM SLIT FENCE AND/OR SILTSOXX REMOVAL SHALL BE PERMANENTLY SEEDED.



The Dubay Group, Inc

196 Harvey Road Bidg B101 Londonderry, NH 03053 603-458-6462 Engineers

Surveyors



	REVISIONS:			
	REV:	DATE:	COMMENT:	BY
	╟─┤			┼─
	Н			╅
				_
				Τ
1	_			

DRAWN RY CHECKED BY: DEC. 17, 202 SCALE: FILE: DEED REF: 469-DETAILS

H.C.R.D.: BK. 9403 PG, 2706

GRANITE SUBARU EXPANSION MAP 210 LOT 1 6 EXECUTIVE DRIVE

HUDSON, NH 03051


RAYMOND JAMES GRANITE PROP LLC 193 LOWELL RD

HUDSON, NH 03051

SHEET TITLE:

SITE **DETAILS-1**


PROJECT #469 SHEET 8 of 10

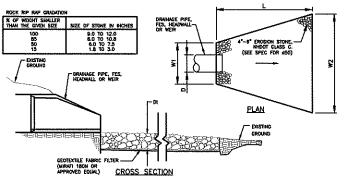


CONSTRUCTION NOTES:

- 2. THE ROCK OR GRAVEL USED FOR RIPRAP SHALL CONFORM TO THE SPECIFIED GRADATION.
- CECTEXTILE FABRICS SHALL BE PROTECTED FROM PUNCTURE OR TEARING DURING THE PLACEMENT OF THE ROCK RPRAP, DAMAGED AREAS IN THE TARRIC SHALL BE REPARED BY PLACING A PIECE OF FABRIC OVER THE DAMAGED AREA OR BY COMPLETE THE PLACEMENT OF THE FABRIC, ALL OVERLIA'S RECORDED FOR REPARS OR JOHNNIK TWO DETECS OF FABRIC SHALL BE A MINIARY OF 12 PACIFICATION.
- 4. Stone for the RPRAP MAY BE PLACED BY EQUAPMENT AND SHALL BE CONSTRUCTED TO THE PULL LAYER THICKHESS IN OHE OPERATION AND IN SUCH A MARKER AS TO PREVENT SECREGATION OF THE STONE SIZES.
- 5. THE MEDIAN STONE DAMETER FOR THE RIPRAP APRON IS 450. FIFTY PERCENT BY WEIGHT OF THE RIPRAP MIXTURE SHALL BE SMALLER THAN THE MEDIAN STONE SIZE. THE LARGEST STONE SIZE IN THE MIXTURE SHALL BE 1.5 TIMES THE 450.

STONE LINED OUTLET PROTECTION

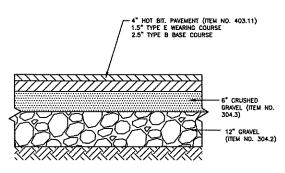


TYPICAL DRIVEWAY AND PARKING LOT SECTION NOT TO SCALE

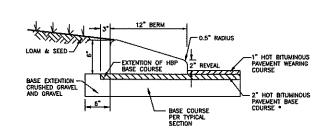

CAPE COD BERM SECTION

NOT TO SCALE

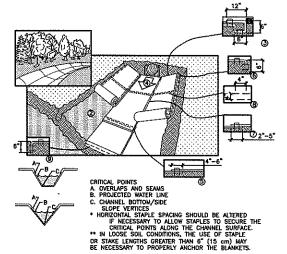

ROLLED EROSION CONTROL MATTING

CHANNEL INSTALLATION SPECIFICATIONS

1. INSTALL PRODUCT IN ACCORDANCE WITH MANUFACTURER'S SPECIFICATIONS

2. PREPARE SOIL BEFORE INSTALLING BLAIKETS, INCLUDING ANY NECESSARY APPLICATION OF LIME, FERRILIZER, AND SEED. NOTE: WHEN USING CELL-O-SEED, DO NOT SEED PREPARED AREA CELL-O-SEED MUST BE INSTALLED WITH THE PAPER SIDE DOWN.

5. PLACE CONSECUTIVE BLANKETS END OVER END (SHINGLE STYLE) WITH A 4"-6" OVERLAP, USE A DOUBLE ROW OF STAPLES STAGGERED 4" APART AND 4"(10") ON CENTER 10 SECURE BLANKETS.

6. Full-length edge of blankets at top of side slopes must be anchor with a row of staples/stargs approximately 12" apart in a 6"deep x 6" wide trench. Backfill and compact the trench after stapling.

7. ADJACENT BLANKETS MUST BE OVERLAPPED APPROXIMATELY 2"-5" (DEPENDING ON BLANKET TYPE) AND STAPLED TO ENSURE PROPER SEAM AUGMAINT, PLACE THE EDGE OF THE OVERLAPPING BLANKET (BLANKET BEING INSTALLED ON TOP) EVEN WITH THE COLORED SEAM STRICK ON THE BLANKET BEING OVERLAPPED.

THE TERMINAL END OF THE BLANKETS MUST BE ANCHORED WITH A ROW OF STAPLES/STAKES APPROXIMATELY 12" APART IN A 6"DEEP X 6"WIDE TRENCH. BACKFILL AND COMPACT THE TRENCH AFTER STAPLING.

END CAP SHALL BE WATERTIGHT OUTLET PIPE ANGLE IRON TRASH RACK FRAME (SUPERIOR CONCRETE OR APPROVED TRASH RACK DETAIL NOT TO SCALE

DRAWN BY CHECKED BY: DATE: SCALE:

FILE: DEED REF:

PROJECT:

GRANITE SUBARU EXPANSION

H.C.R.D.; BK. 9403 PG. 2706

SJK DGM DEC. 17, 2021

469-DETAILS

The Dubay Group, Inc.

136 Harvey Road Bldg B101 Londonderry, NH 03053 603-458-6462

Engineers

Planners

Surveyors The Dubay Group.com

REV: DATE: COMMENT:


MAP 210 LOT 1 6 EXECUTIVE DRIVE HUDSON, NH 03051

RAYMOND JAMES GRANITE PROP LLC 193 LOWELL RD HUDSON, NH 03051

SHEET TITLE:

SITE

PROJECT #469 SHEET 9 of 10

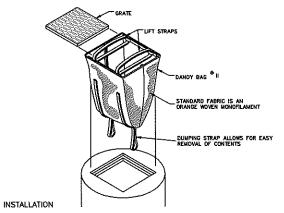

INSTALLATION: REMOVE THE GRATE FROM CATCH BASIN. IF USING OPTIONAL OIL ABSORBENTS, PLACE ABSORBENT PILLOW IN UNIT. STAND THE GRATE ONLEND. MOVE THE TOP LIFTING STRAPS OUT OF THE WAY AND PLACE THE GRATE INTO THE DAMPO BAGIN SO THAT THE GRATE IS BELOW THE TOP STRAPS AND ABOVE THE LOWER STRAPS. HOLDING THE LIFTING DEWICES, INSERT THE GRATE INTO THE INLET. MAINTENANCE

MAINTENANCE: REMOVE ALL ACCUMULATED SEDIMENT AND DEBRIS FROM YCONITY OF UNIT AFTER EACH STORM EVENT. AFTER EACH STORM EVENT AND AT REGULAR INTERVALS, LOCK INTO THE DANDY BAG 1.6 FT THE CONTAINMENT AREA IS MORE THAN 1/3 FULL OF SEDIMENT, THE UNIT MUST BE EMPTIED. TO EMPTY UNIT, IT THE UNIT OUT TO THE INLET USING THE LETTING STRAPS AND REMOVE THE GRATE. IF USING POPHONAL OL ABSORBEITS, REPLACE ASSORBENT WHEN HEAR SATURATION.

DANDY BAG®II


YEARS FROM DATE OF APPROVAL.

PURSUANT TO THE SITE REVIEW REGULATIONS OF THE HUDSON PLANNING BOARD DATE OF MEETING:

APPROVED BY THE HUDSON, NH PLANNING BOARD DATE OF MEETING:

BOARD, THE SITE PLAN APPROVAL GRANTED HEREIN EXPIRES TWO YEARS FROM DATE OF SIGNATURE DATE:

SITE PLANS ARE VALID FOR TWO YEARS FROM THE DATE OF PLANNING BOARD MEETING FINAL APPROVAL, FINAL APPROVAL, COMMENCES AT THE PLANNING BOARD MEETING DATE AT WHICH THE PLAN RECEIVES FINAL APPROVAL.

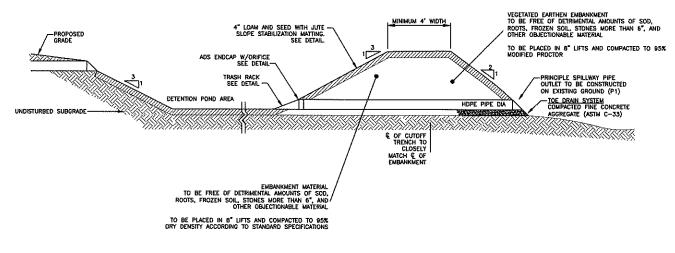


TYPICAL POND SECTION NOT TO SCALE


ORIFICE END CAP DETAIL


NOT TO SCALE


DETAILS-2

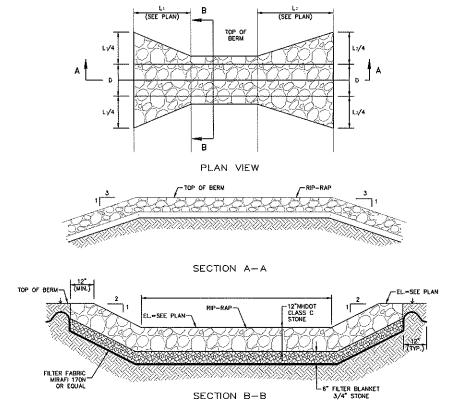

OVERFLOW SPILLWAY
NOT TO SCALE

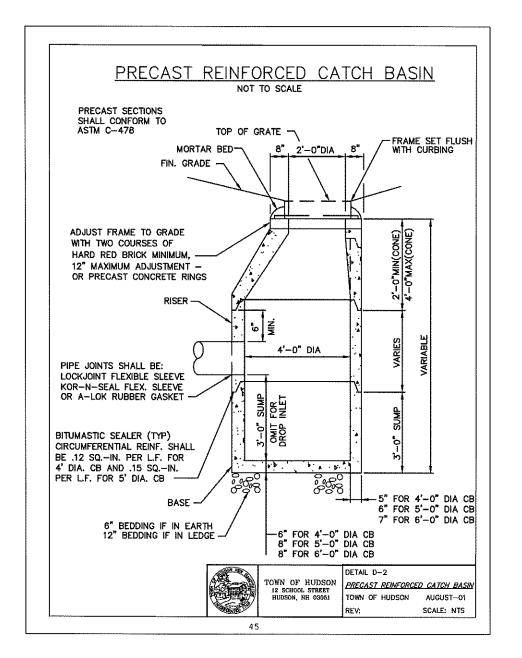

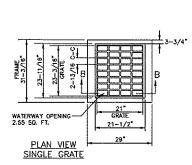

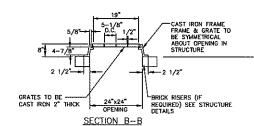

CATCH BASIN FRAME AND GRATE

NOT TO SCALE HS-20LOADING, NHDOT TYPE F (MIN)



The Dubay Group, Inc 136 Harvey Road Bidg B101 Londonderry, NH 03053 603-458-6462

Surveyors TheDubayGroup.com



\subset	REVISIONS:				
REV:	DATE:	COMMENT:	BY		
			Г		
_					

DRAWN BY: CHECKED BY: DATE: SCALE: FILE: DEED REF: DEC. 17, 2021 469-DETAILS

H.C.R.D.: BK. 9403 PG. 2706

PROJECT

GRANITE SUBARU EXPANSION

MAP 210 LOT 1 6 EXECUTIVE DRIVE HUDSON, NH 03051

RAYMOND JAMES GRANITE PROP LLC 193 LOWELL RD HUDSON, NH 03051

SHEET TITLE:

SITE **DETAILS-3**

PROJECT #469 SHEET 1D of 10

HEREIN EXPIRES TWO YEARS FROM DATE OF APPROVAL.

PURSUANT TO THE SITE REVIEW REGULATIONS OF DATE OF MEETING:

DATE OF MEETING:

DATE OF MEETING:

CHAIRMAN

CHAIRMAN SIGNATURE DATE:

SITE PLANS ARE VALID FOR TWO YEARS FROM THE DATE OF PLANNING BOARD MEETING FINAL APPROVAL, FINAL APPROVAL COMMENCES AT THE PLANNING BOARD MEETING DATE AT WHICH THE PLAN RECEIVES FINAL APPROVAL.