

# BARRETTS HILL ROAD SUBDIVISION

MAP 159 LOT 28 Hudson, New Hampshire

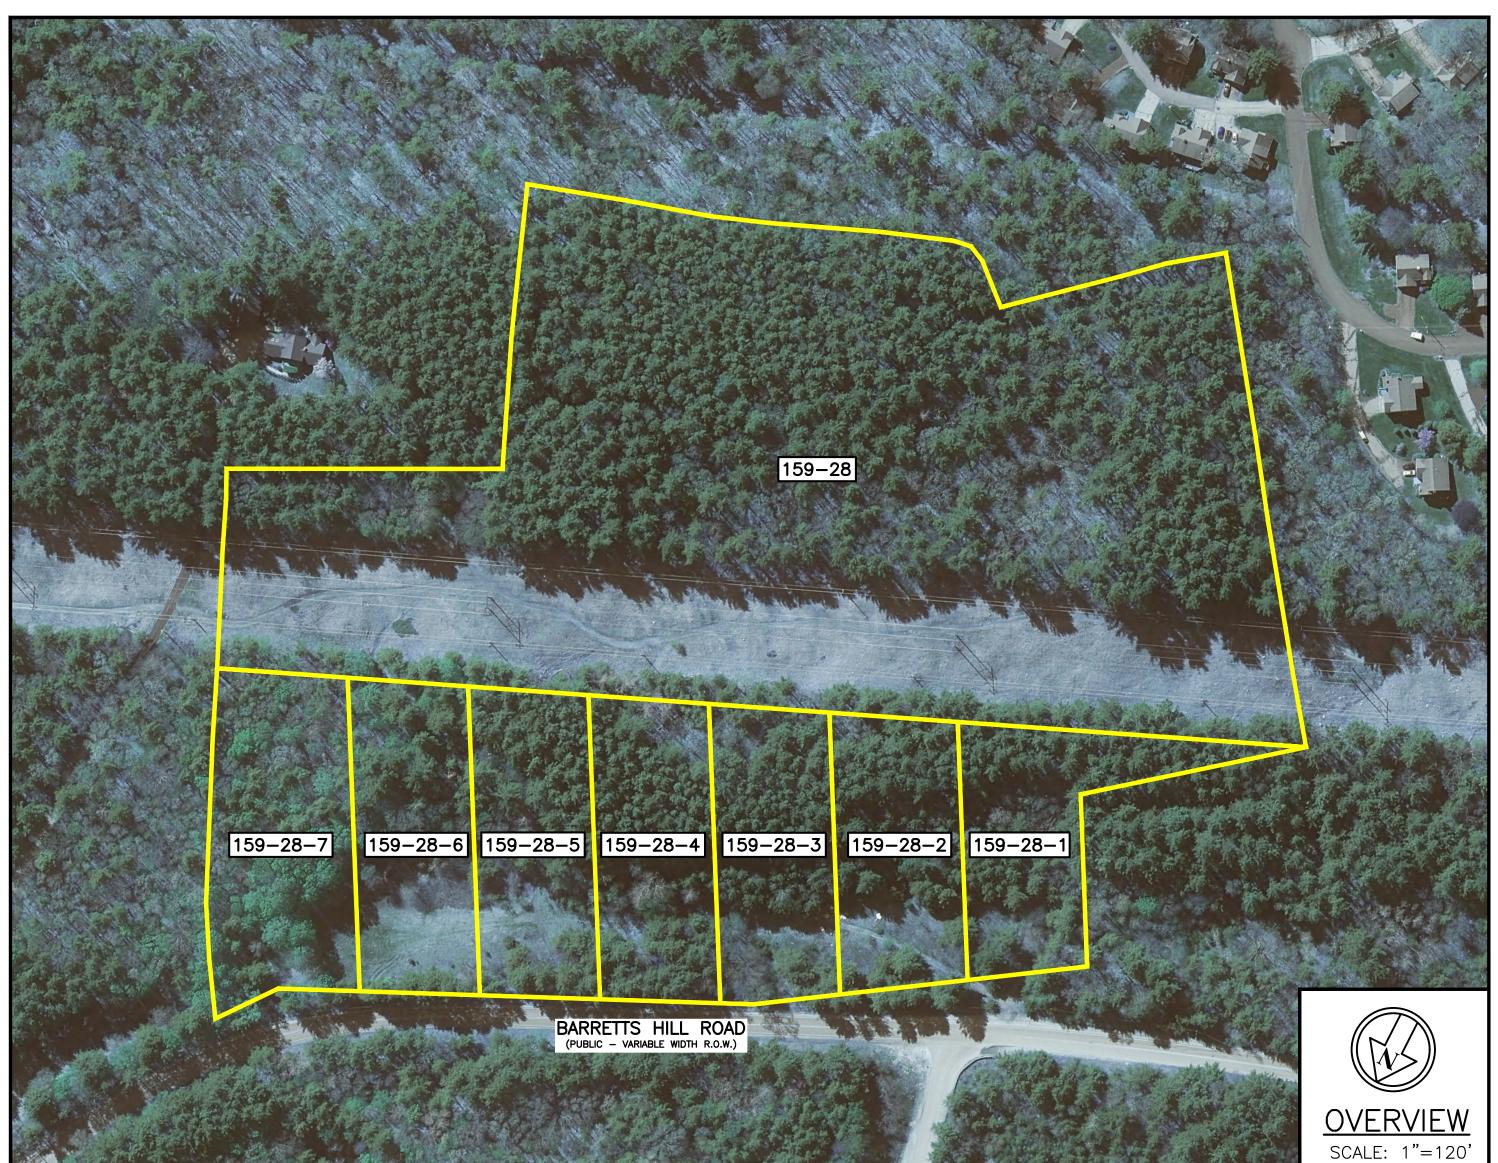

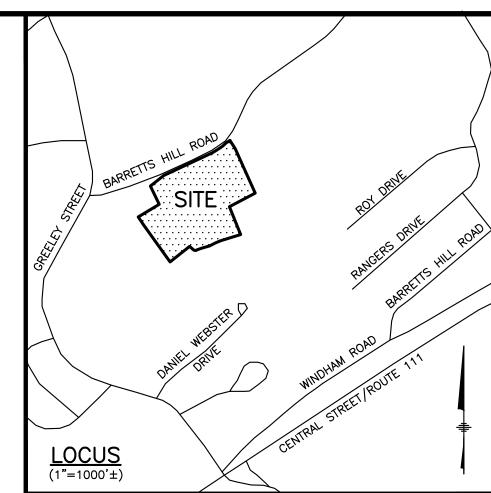

SHEET INDEX

TITLE SHEET

SUBDIVISION PLAN


CONSTRUCTION DETAILS


**EXISTING CONDITIONS PLANS** 

TOPOGRAPHIC SUBDIVISION PLAN

SIGHT DISTANCE PLAN & PROFILES

GRADING, DRAINAGE, UTILITY, & EROSION PLANS

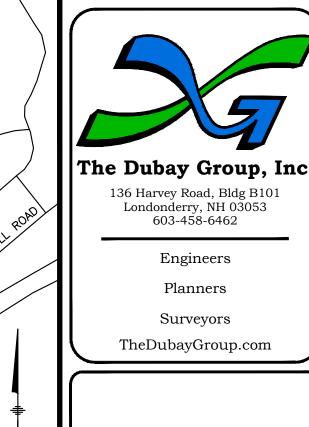

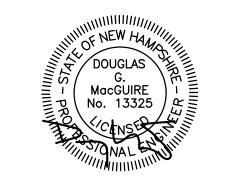

REVISIONS:				
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PROJECT:

## **MAP 159 LOT 28**

3 BARRETTS HILL ROAD HUDSON, NEW HAMPSHIRE

FOR/OWNER—

**BEOWELL, LLC** 

134 TURKEY HILL ROAD MERRIMACK, NH 03054

SHEET TITLE:

TITLE SHEET

PROJECT #649 SHEET



APPROVED BY THE HUDSON, NH PLANNING BOARD

SIGNATURE DATE:


SIGNATURE DATE: SUBDIVISIONS ARE VALID FOR TWO YEARS FROM THE DATE OF PLANNING BOARD MEETING FINAL APPROVAL. FOR AN APPLICANT TO GAIN AN EXEMPTION FROM ALL SUBSEQUENT CHANGES IN SUBDIVISION REGULATIONS, SITE PLAN REGULATIONS AND CHANGES TO THE ZONING ORDINANCE, SEE NH RSA 674:39.


OWNER'S SIGNATURE


**WAIVER REQUESTED:** 


1. WAIVER REQUESTED FROM §276-11.1.B.2, GENERAL PLAN REQUIREMENTS, TO ALLOW FOR MULTIPLE PLANS TO BE AT A SCALE OF 1"=60' WHERE A MAXIMUM OF 1"=50' IS ALLOWED. Permits & Approvals:

Permit # NHDES Subdivision Permit

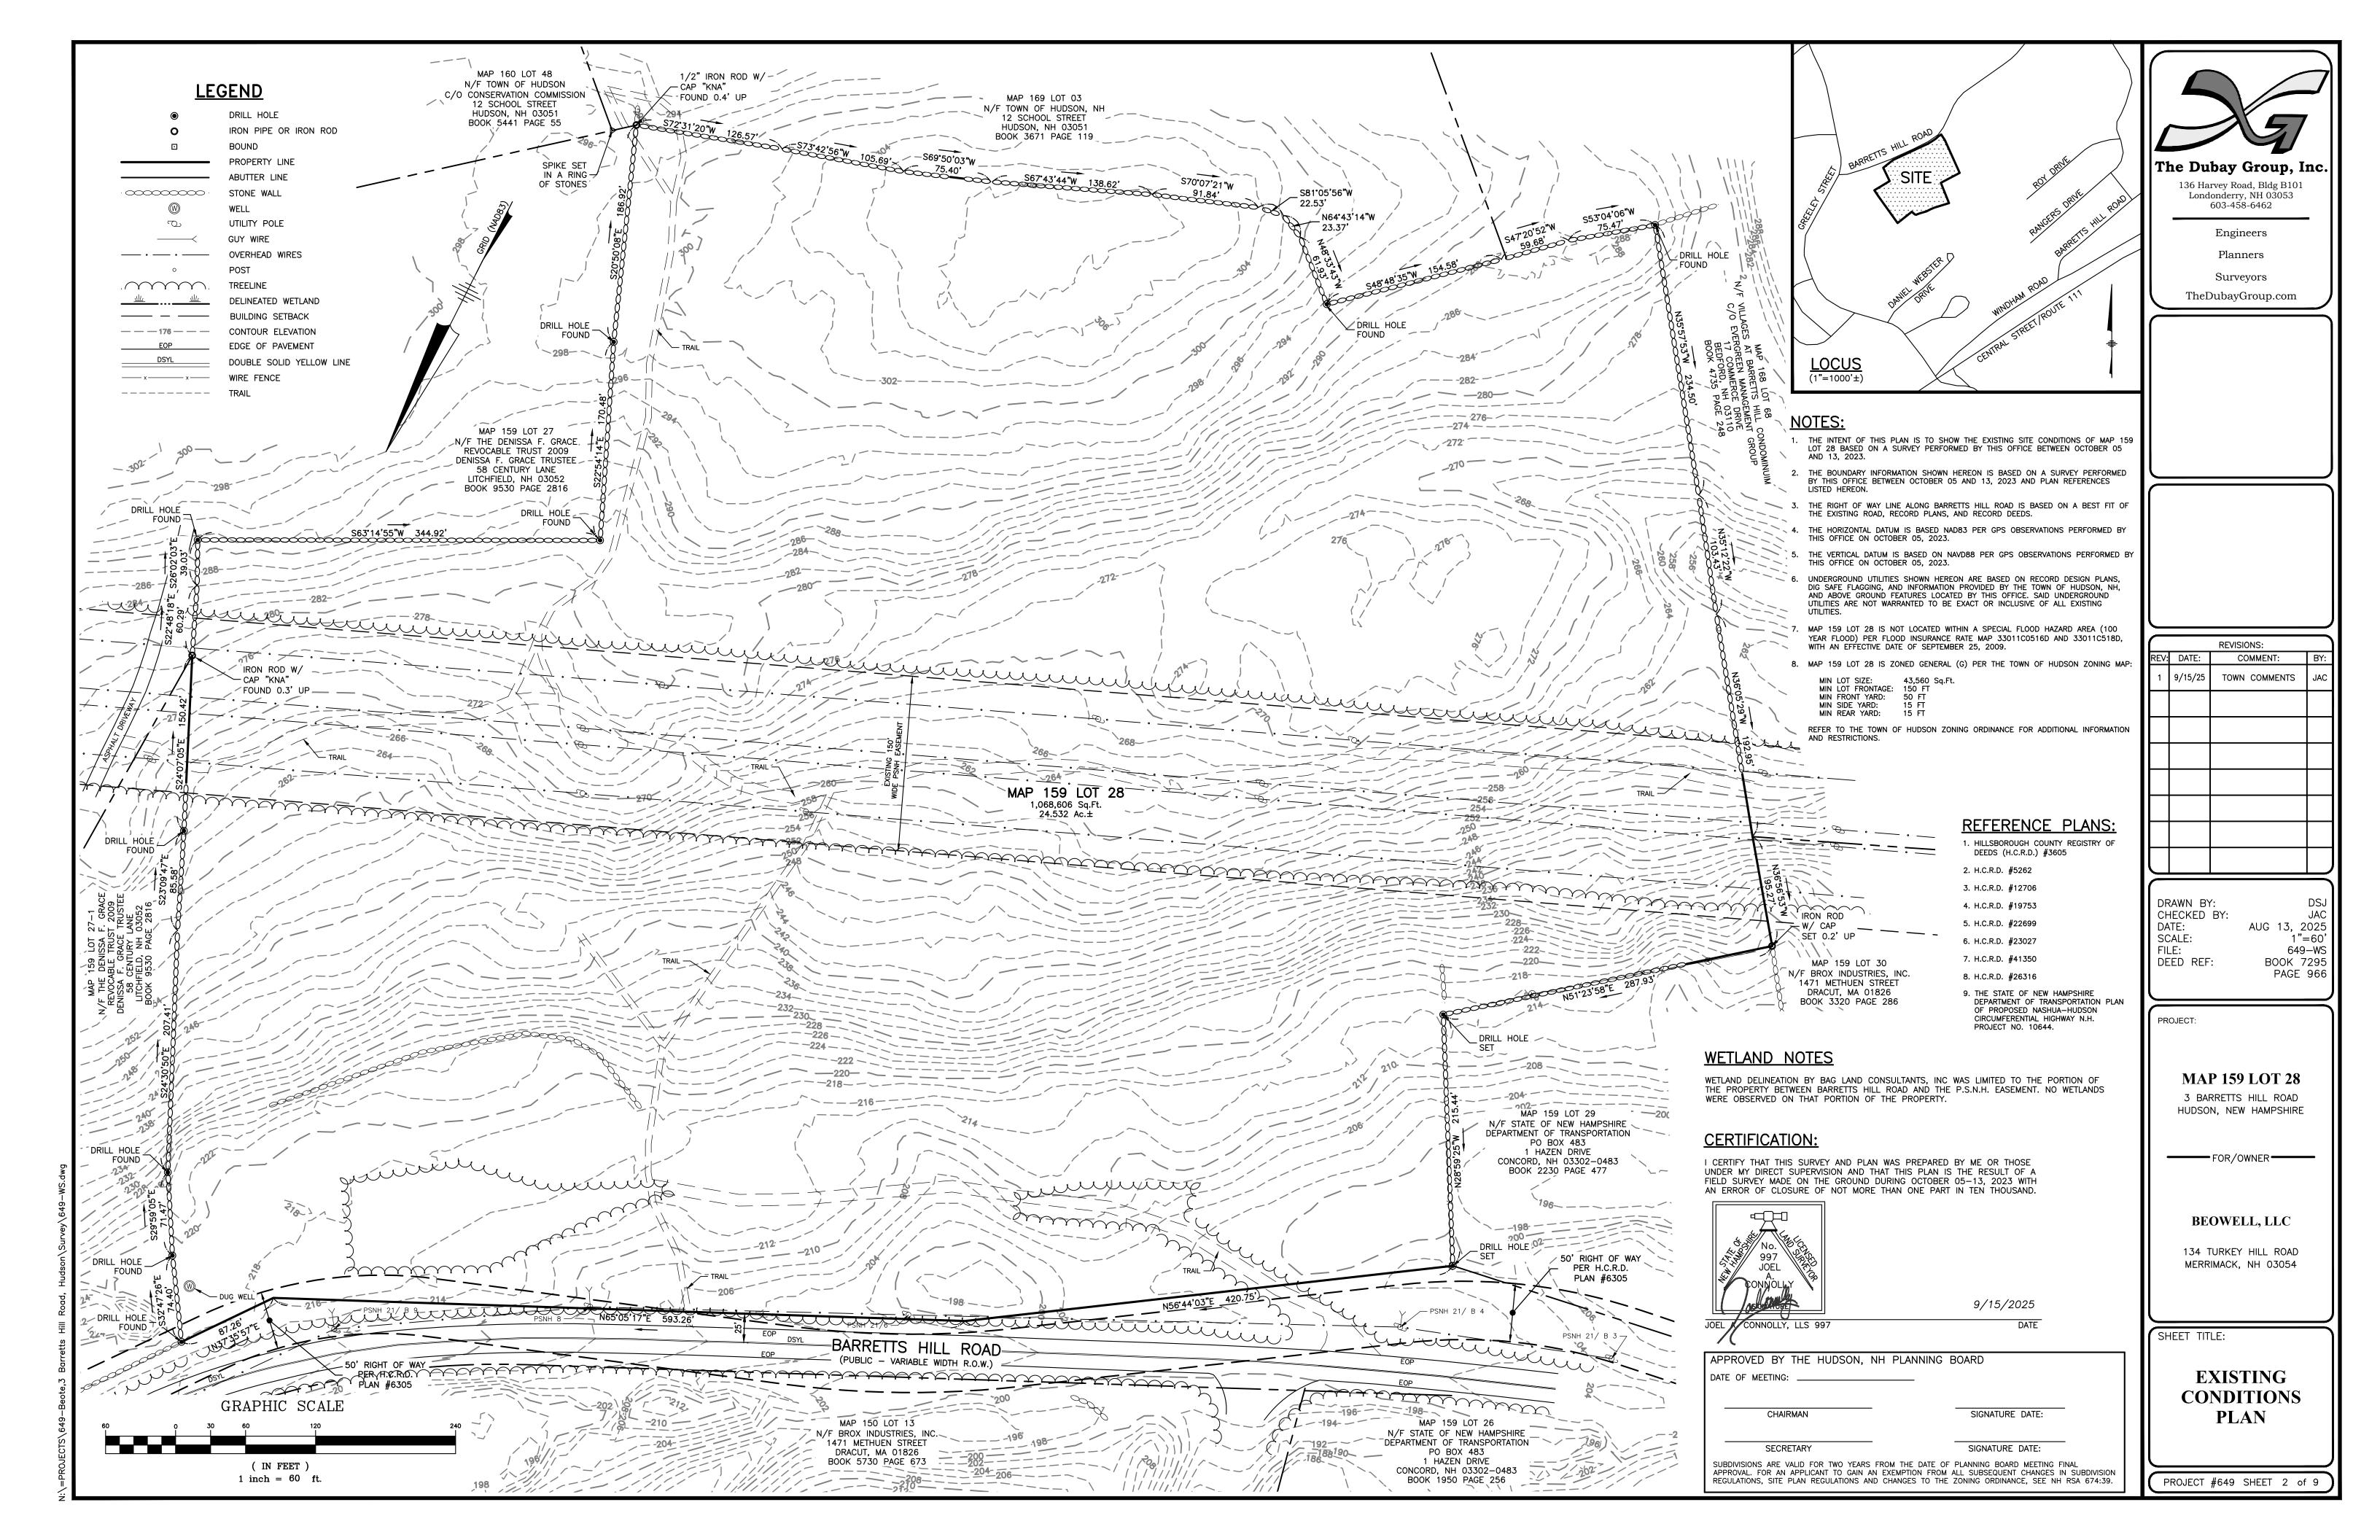

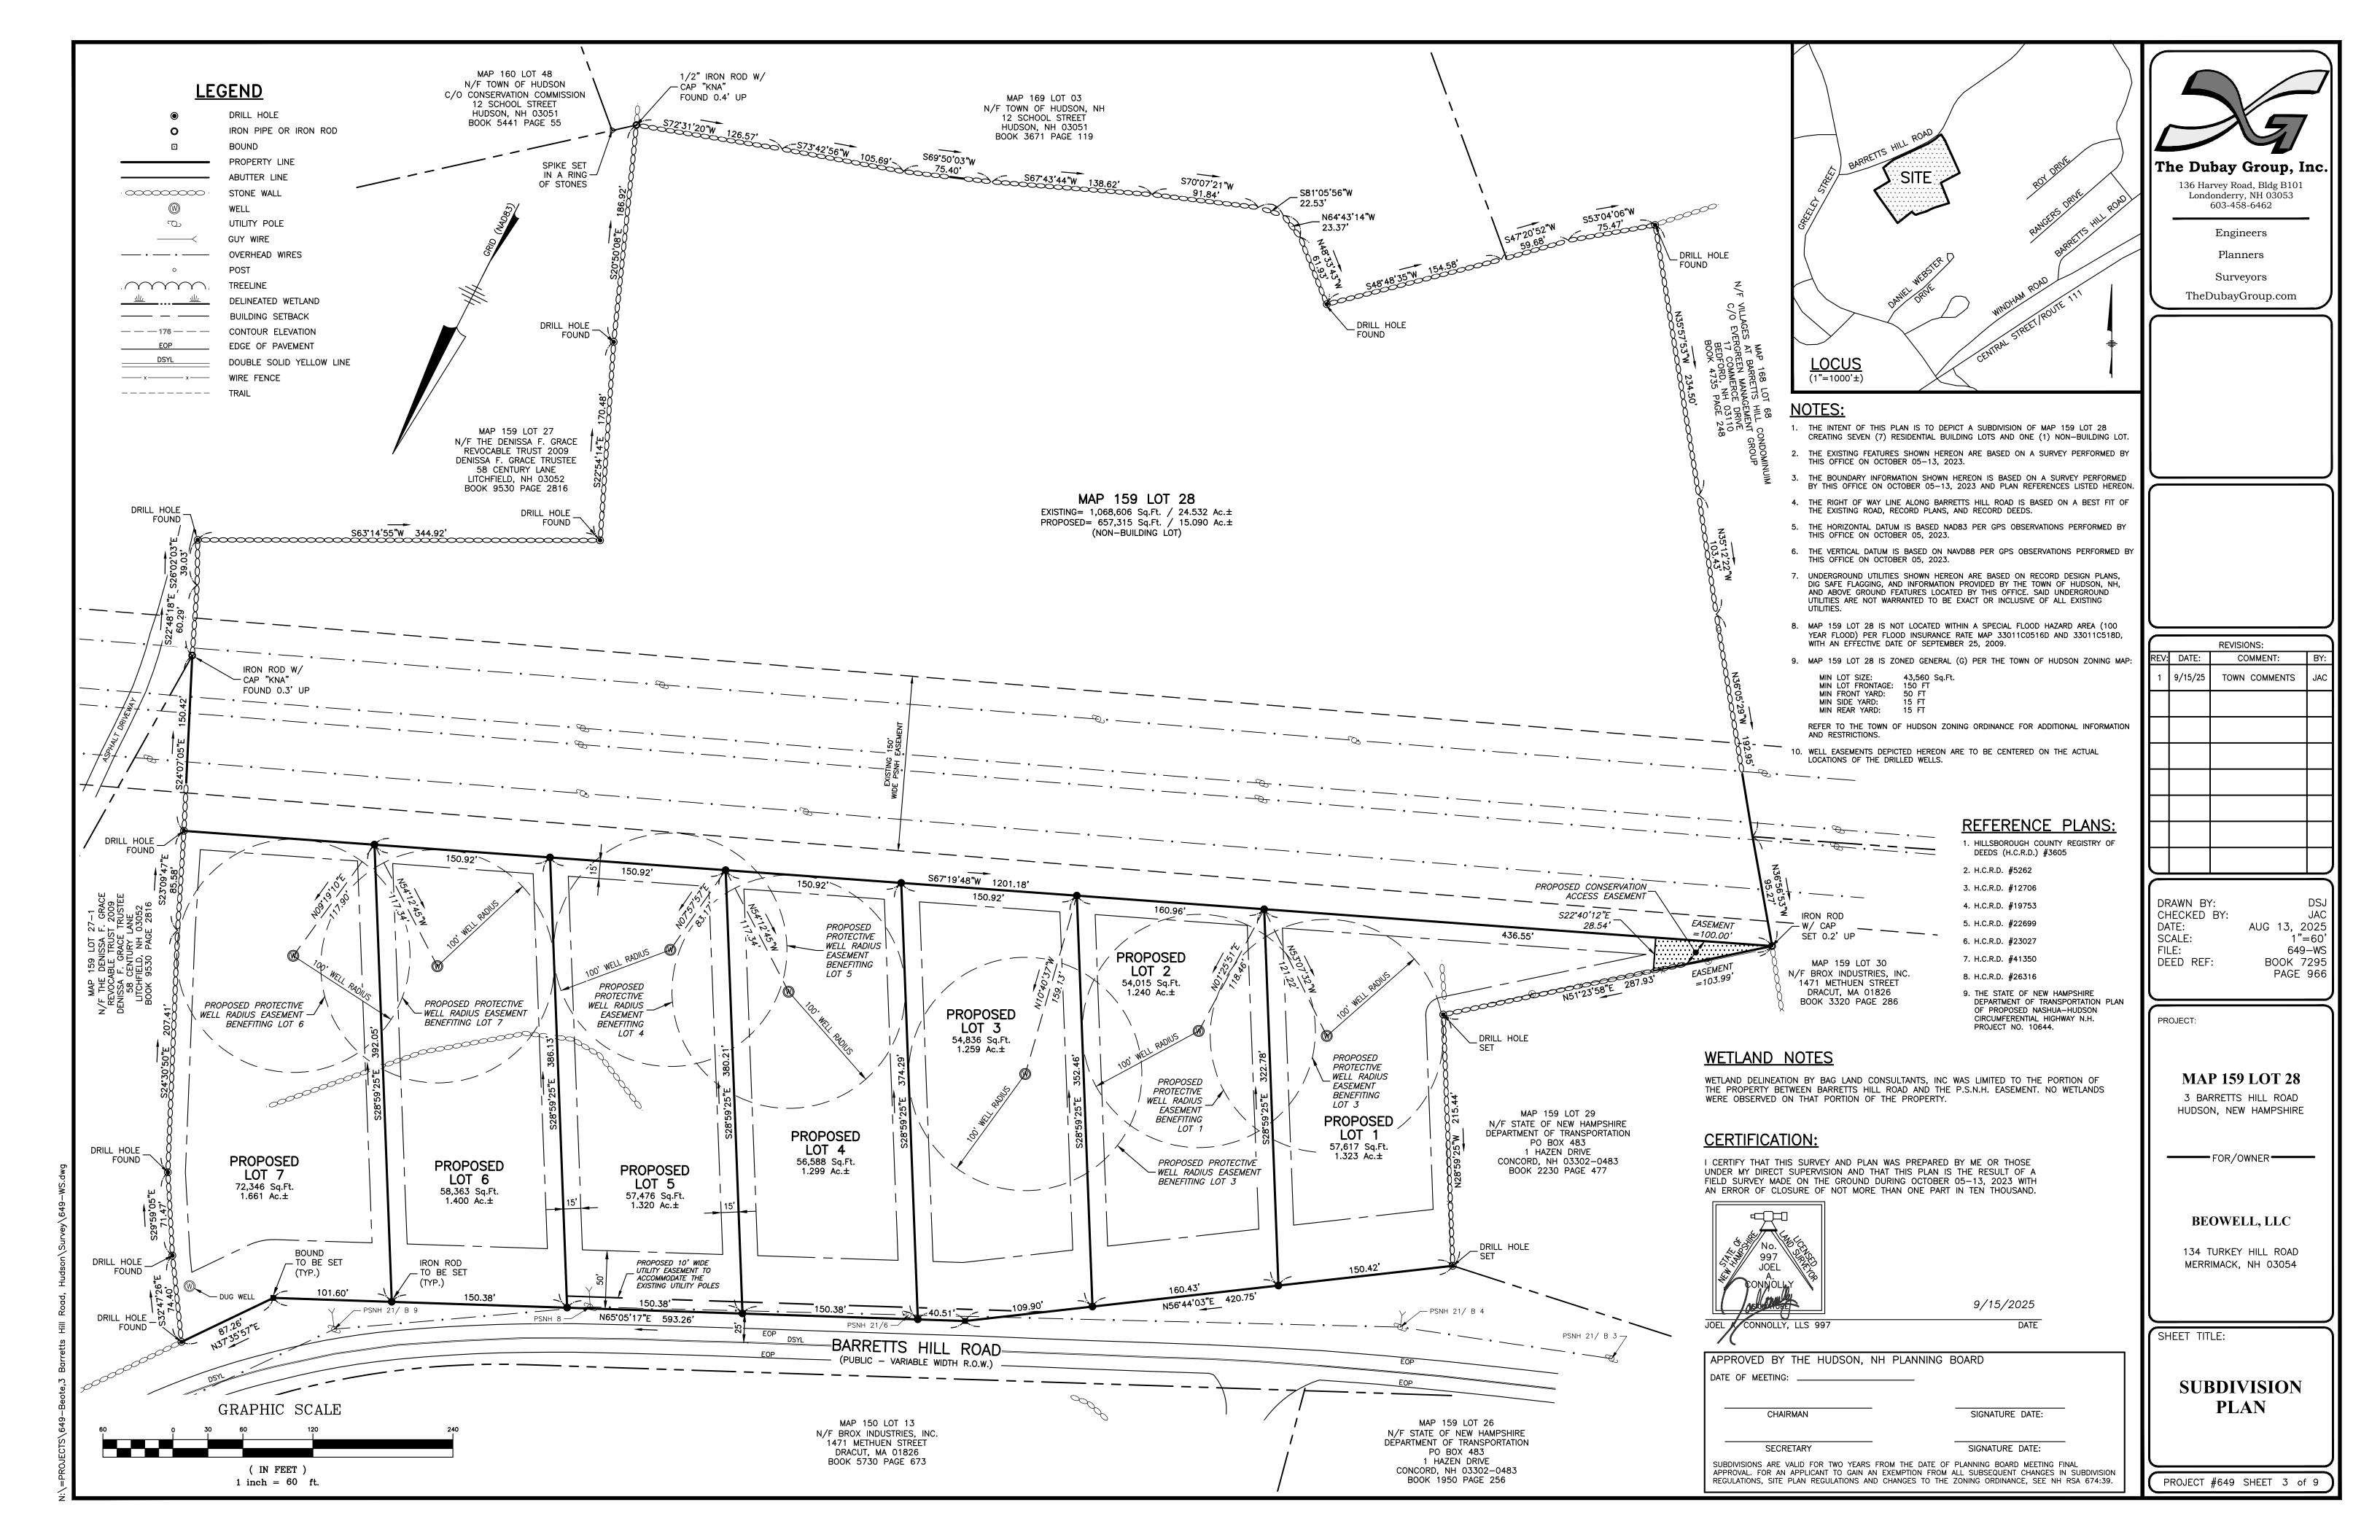

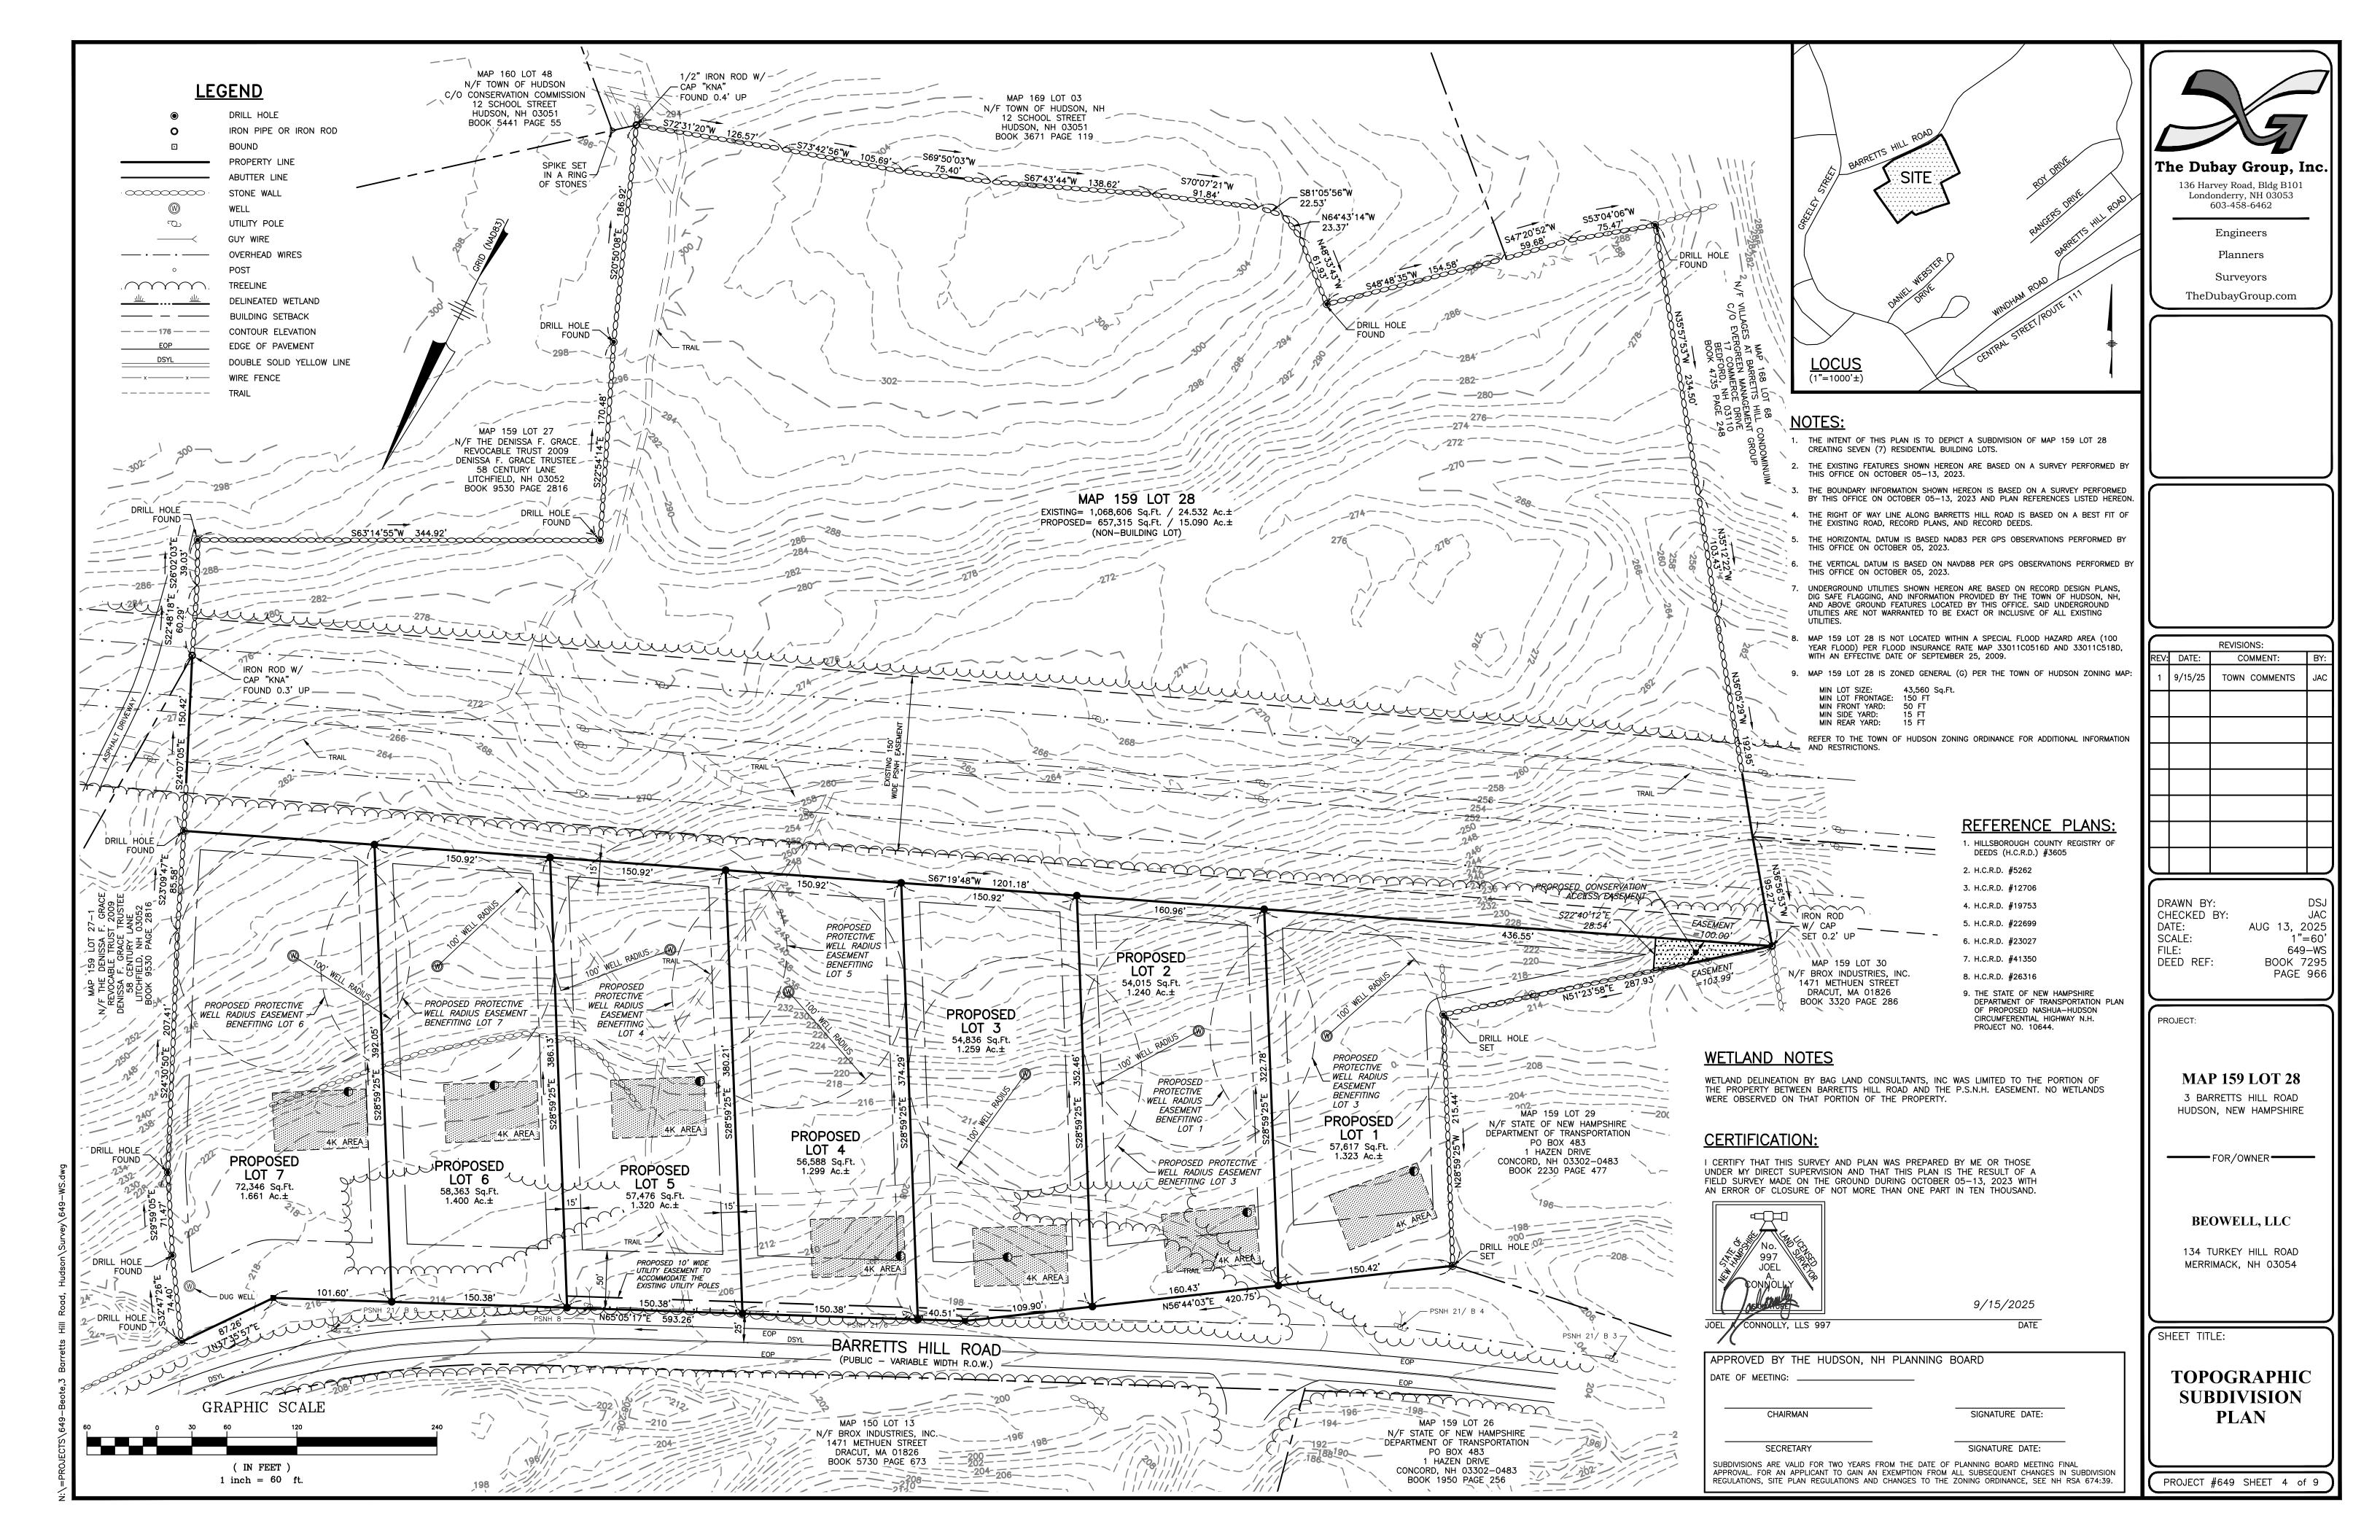

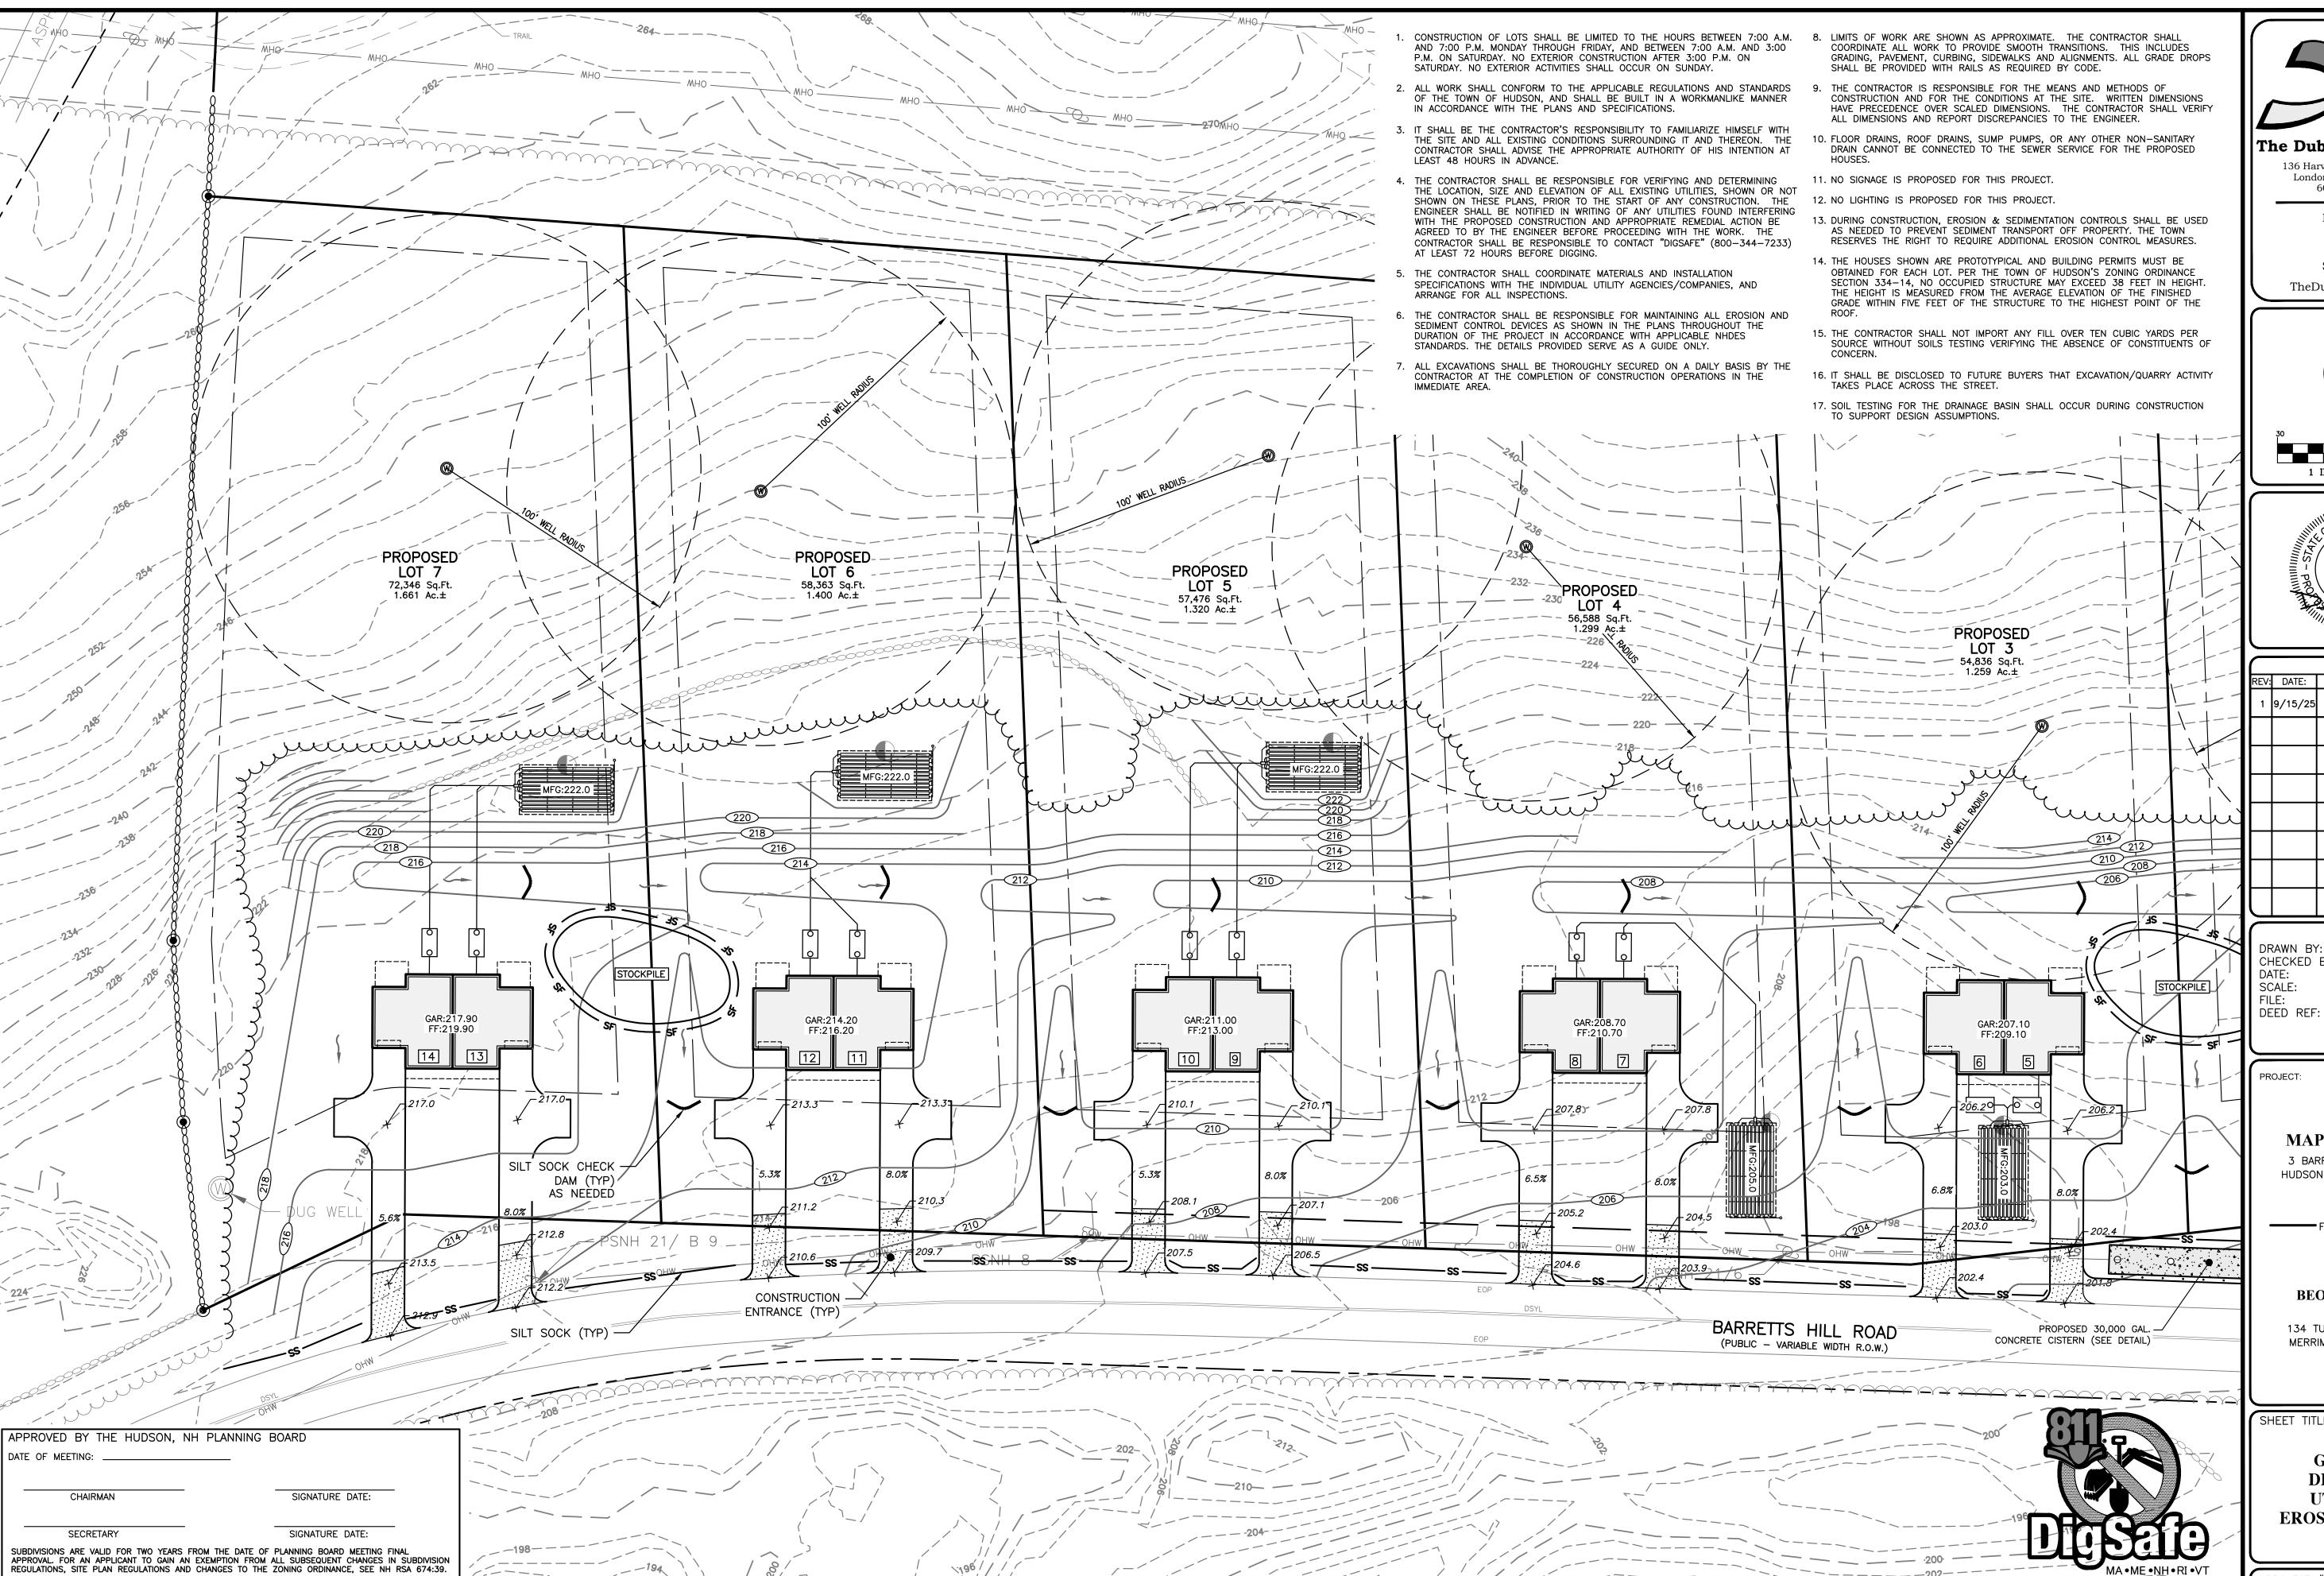

The Dubay Group, Inc. 136 Harvey Road, Bldg B101 Londonderry, NH 03053


Engineers

603-458-6462

Planners

Surveyors TheDubayGroup.com

1 INCH = 30 FEET

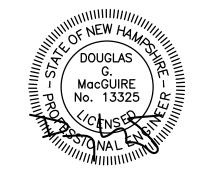

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CHECKED BY: AUG 13, 2025 1"=30' 649-GU BOOK 7295 PAGE 966

**MAP 159 LOT 28** 

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— FOR/OWNER—

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134 TURKEY HILL ROAD MERRIMACK, NH 03054

SHEET TITLE:

GRADING, DRAINAGE, UTILITY, & **EROSION PLAN - A** 

PROJECT #649 SHEET 5 of 9



The Dubay Group, Inc.

136 Harvey Road, Bldg B101 Londonderry, NH 03053 603-458-6462


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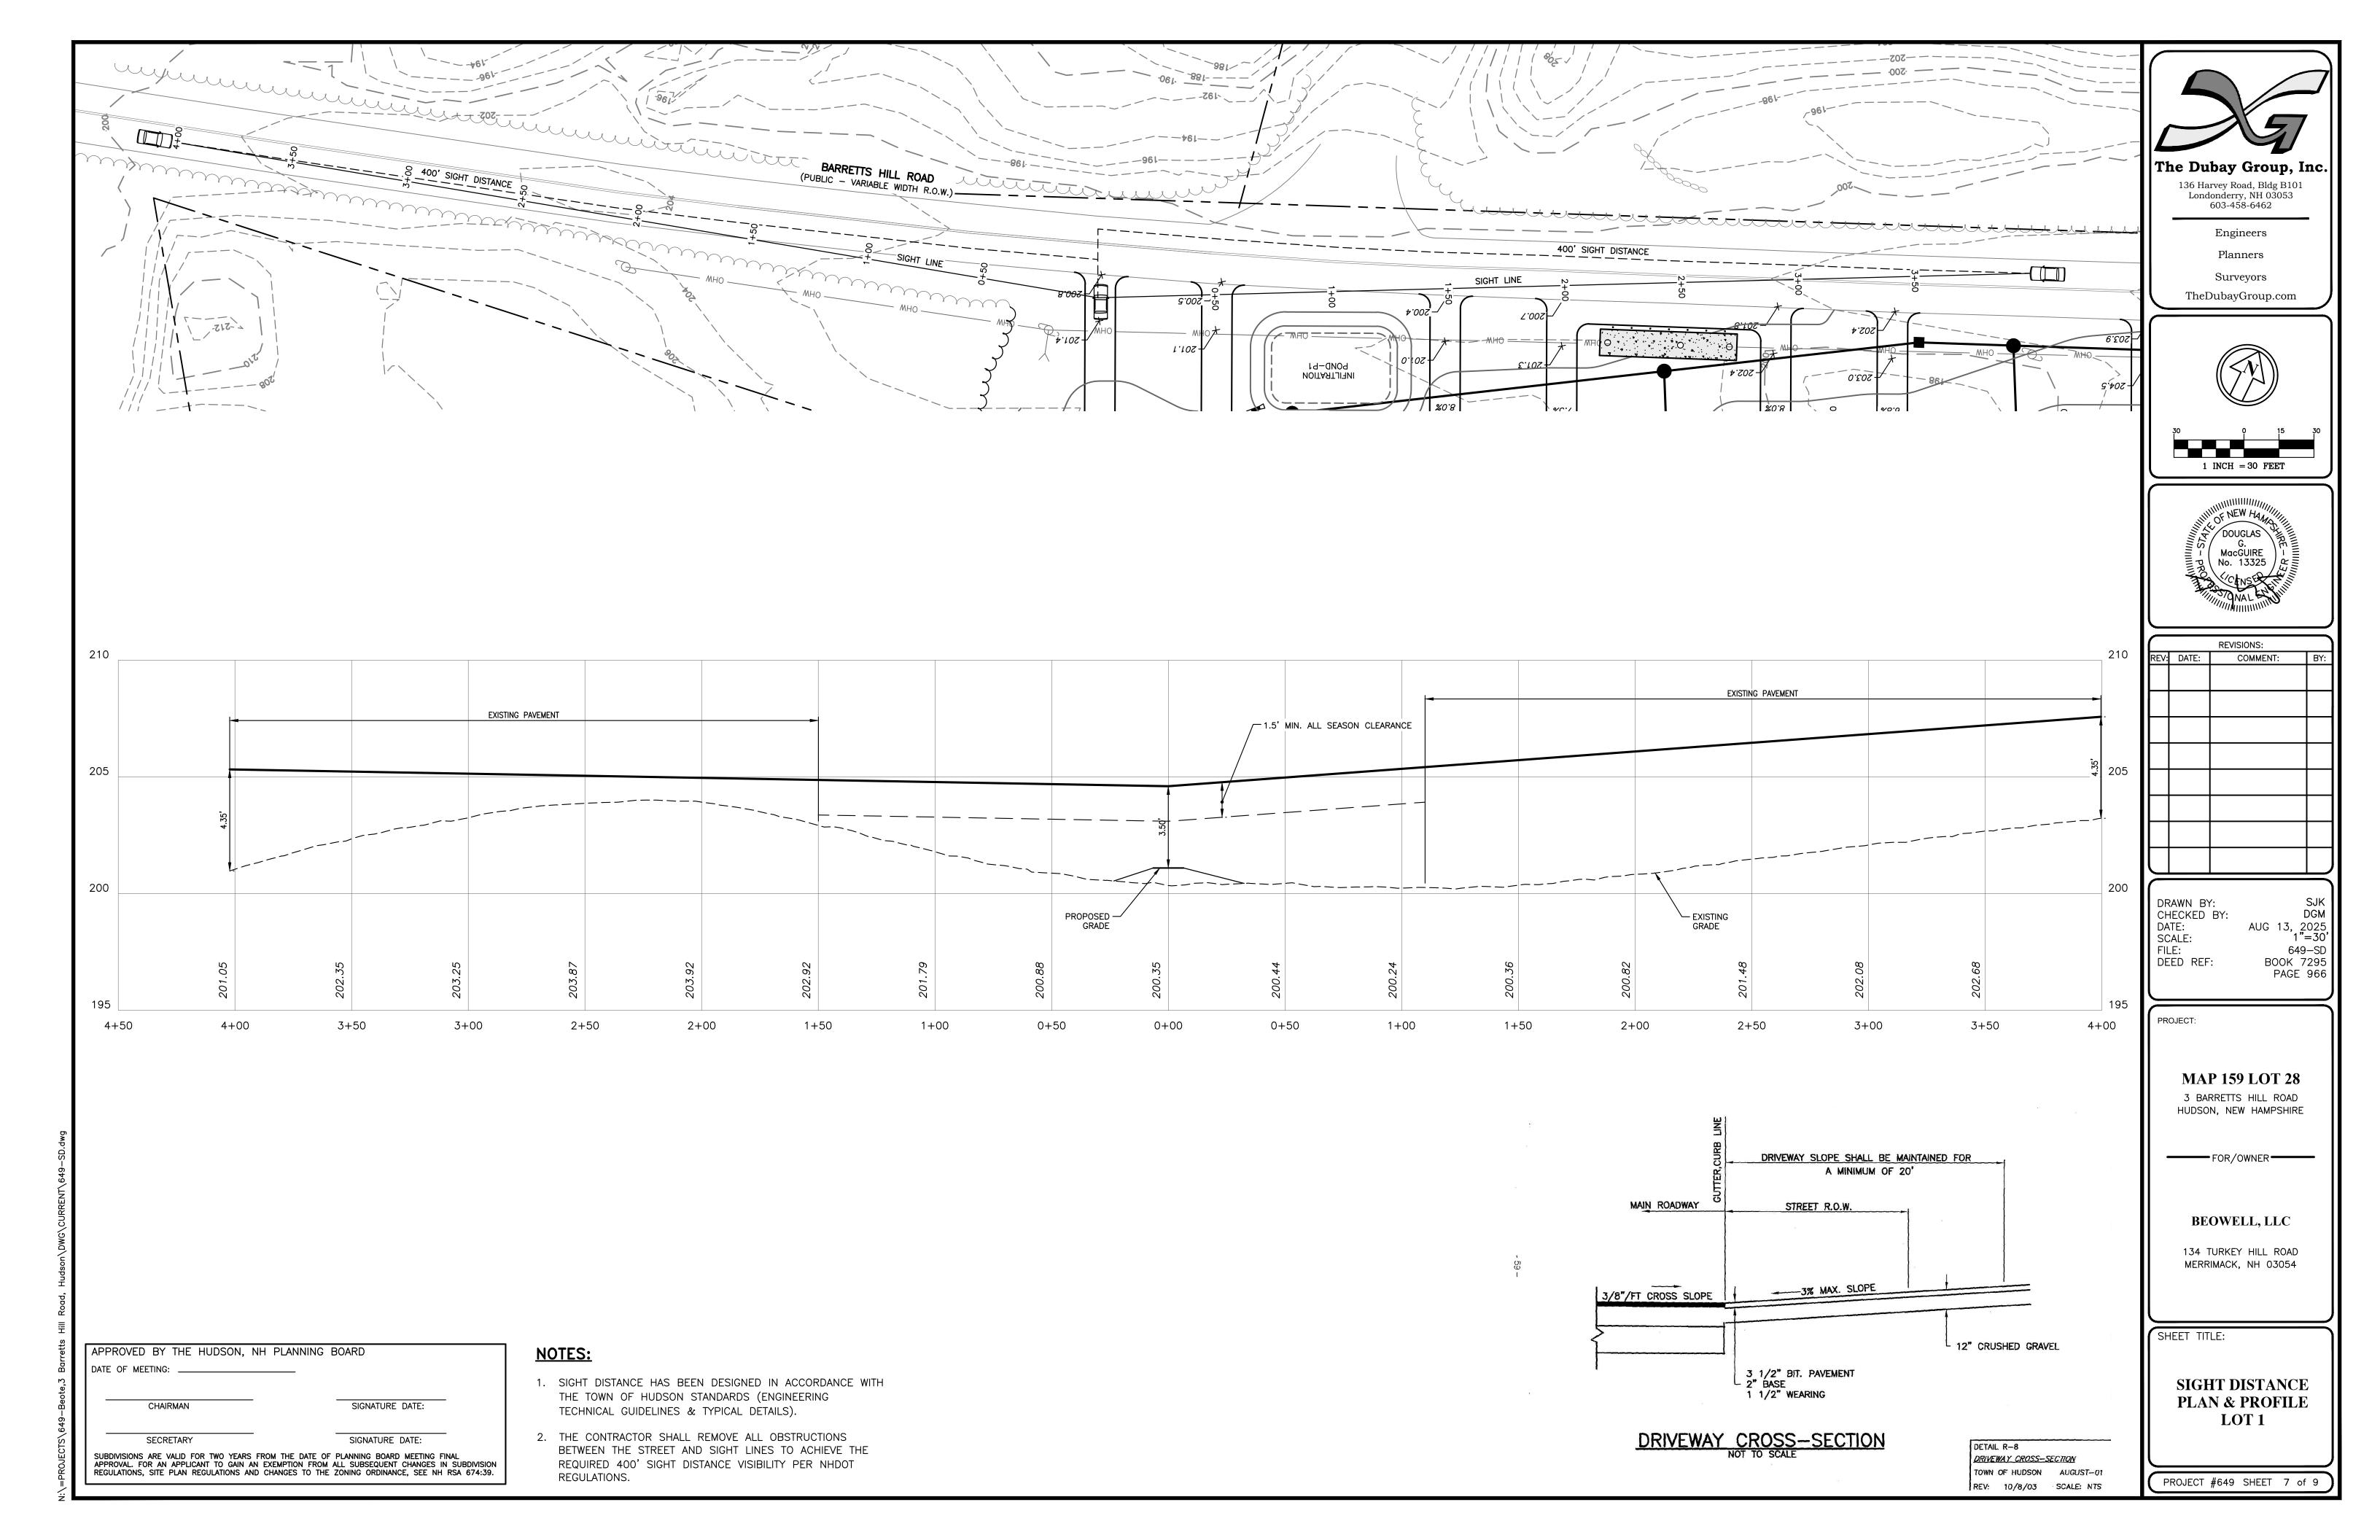
**MAP 159 LOT 28** 


3 BARRETTS HILL ROAD HUDSON, NEW HAMPSHIRE


134 TURKEY HILL ROAD MERRIMACK, NH 03054

GRADING, DRAINAGE, UTILITY, & **EROSION PLAN - B** 

PROJECT #649 SHEET 6 of 9

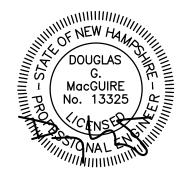

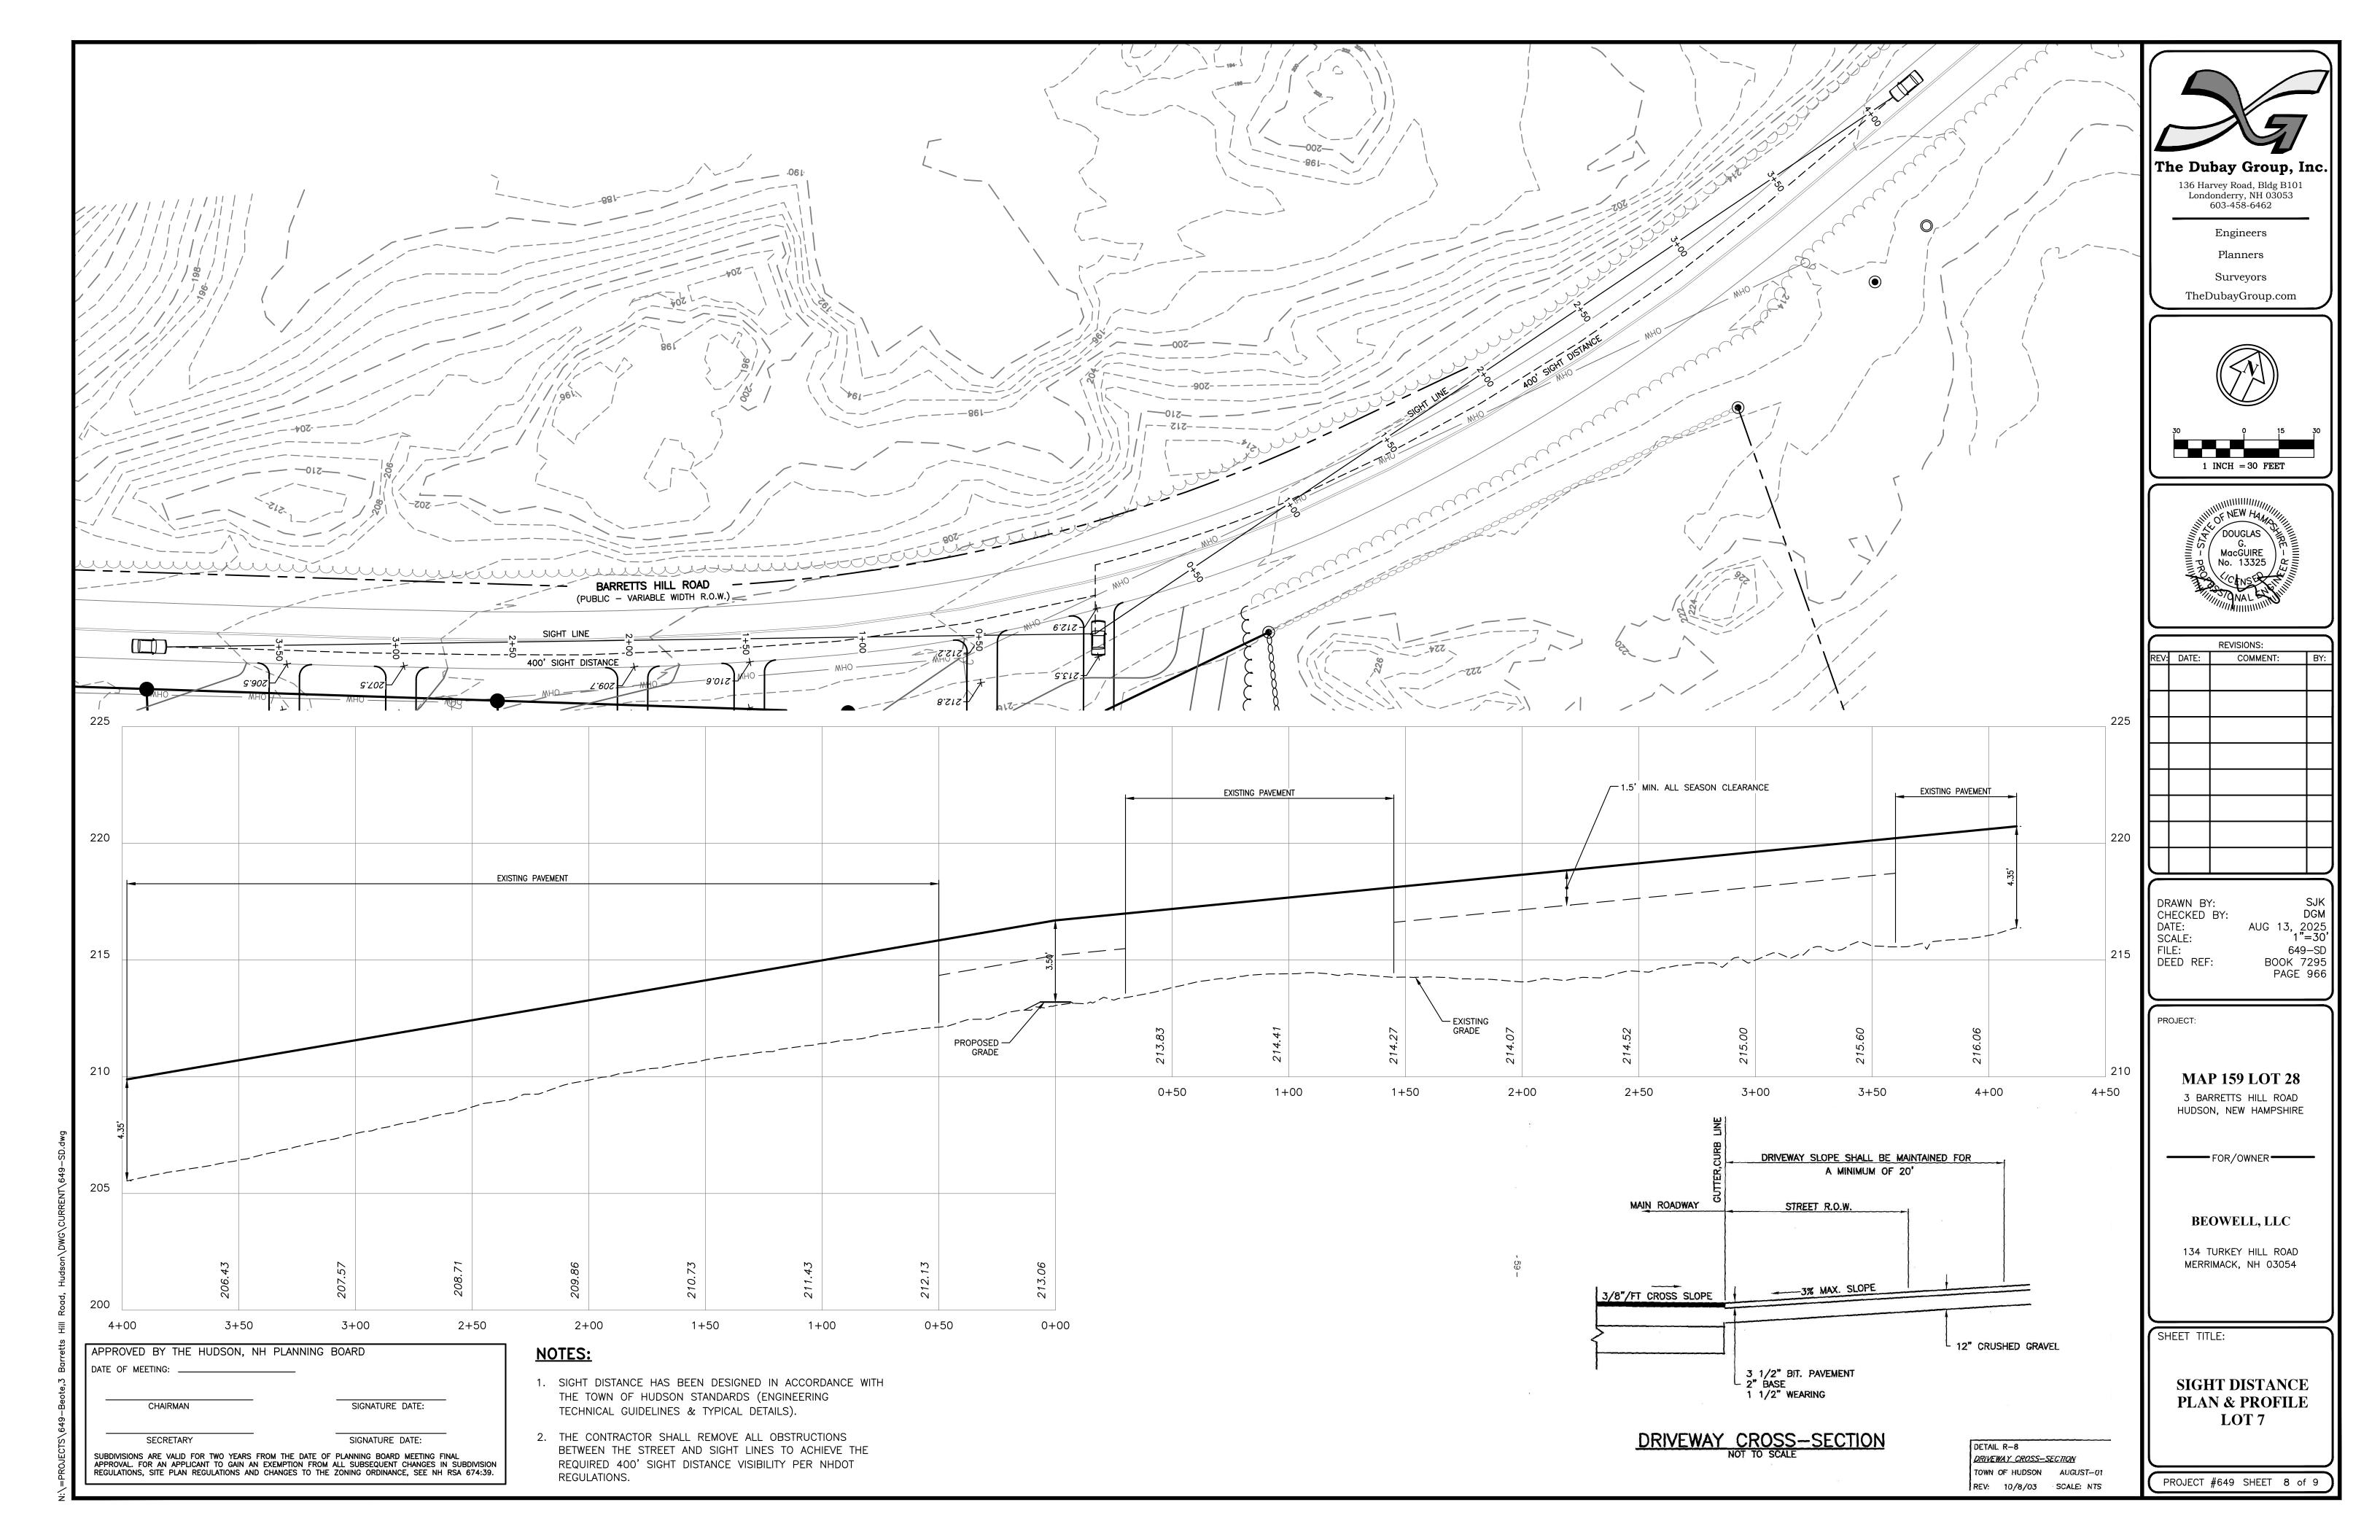

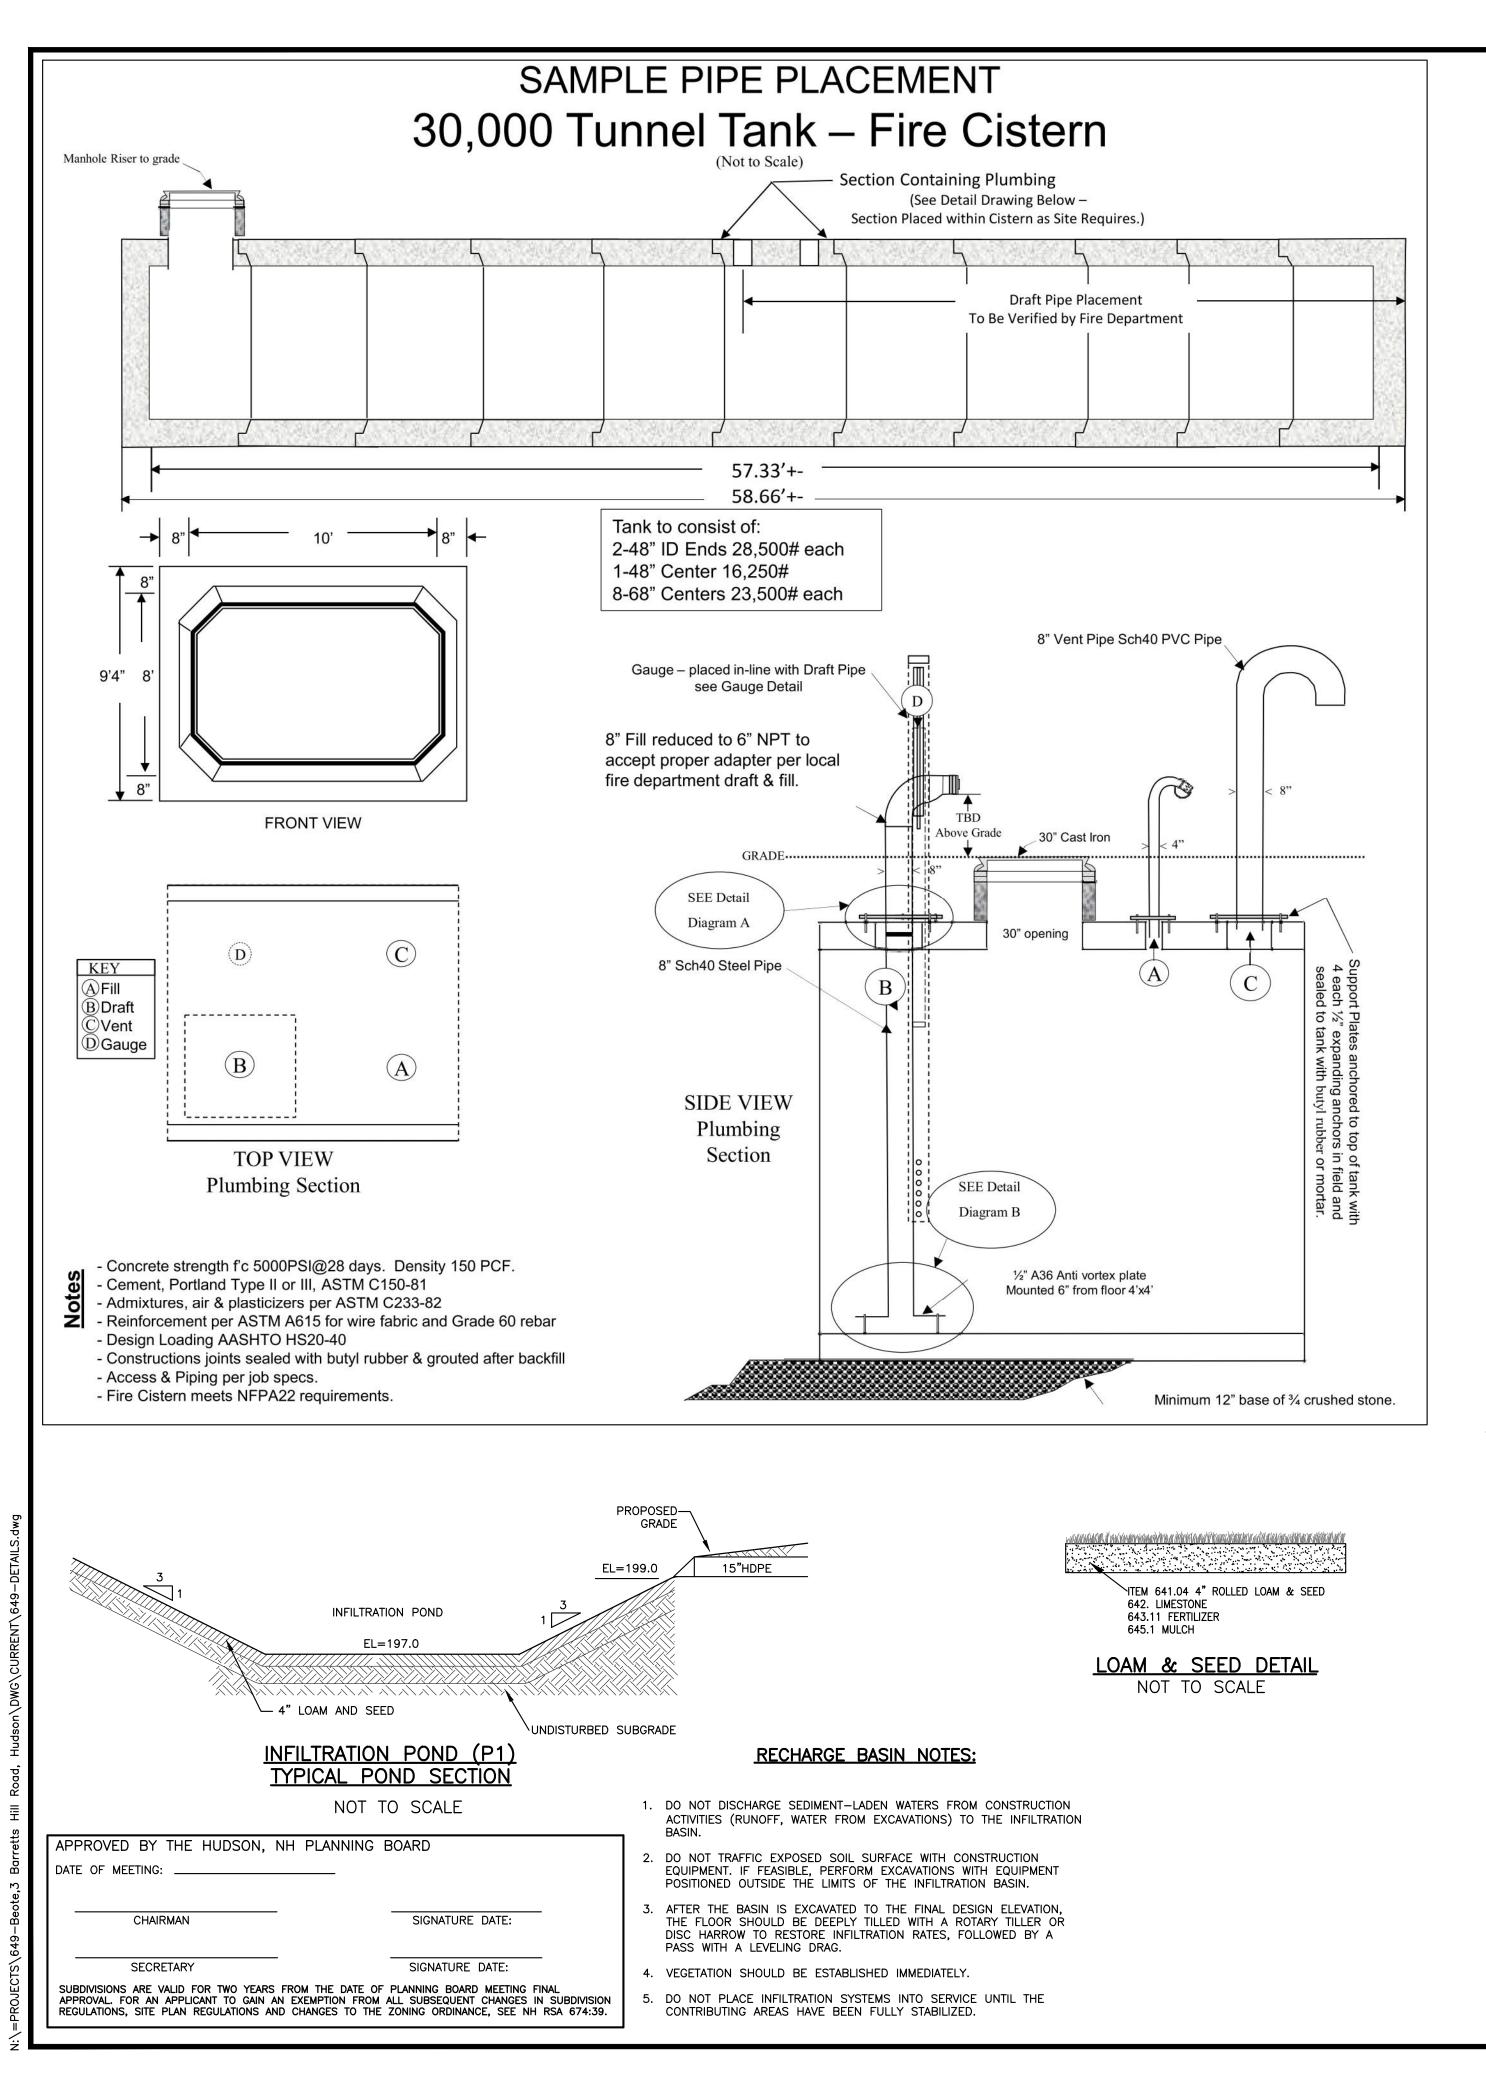

#### **CONSTRUCTION SEQUENCE**


- 1. CONTRACTOR TO NOTIFY DIG-SAFE 72-HOURS PRIOR TO COMMENCEMENT OF CONSTRUCTION.
- 2. AN INITIAL PRE CONSTRUCTION MEETING(S) SHALL TAKE PLACE WITH THE CONTRACTOR, OWNER AND TOWN AGENTS.
- 3. PRIOR TO ANY EARTH MOVING OPERATION INSTALL PERIMETER CONTROLS, I.E SILT FENCE AND/OR SILTSOXX AROUND THE LIMITS OF DISTURBANCE OR OTHER EROSION CONTROL DEVICE (SO AS SHOWN ON THE EROSION CONTROL PLAN
- 4. CONSTRUCT TEMPORARY CONSTRUCTION EXIT.
- 5. SEDIMENT TRAPS AND/OR BASINS SHALL BE USED AS NECESSARY TO CONTAIN RUNOFF UNTIL BASINS/PONDS ARE STABILIZED.
- 6. REMOVE AND STOCKPILE MATERIALS AS REQUIRED. STOCKPILE SHALL BE SURROUNDED WITH AN EROSION CONTROL DEVICE TO PREVENT EROSION. STOCKPILE AREAS ARE LIMITED AND THUS MANAGEMENT OF MATERIALS WILL BE REQUIRED.
- 7. SHAPE PROPOSED DRAINAGE PONDS, DITCHES AND/OR SWALES.
- 8. PERFORM ROUGH SITE GRADING. INSTALL DRAINAGE SYSTEMS AND UTILITIES.
- 9. PLANT LANDSCAPING IN AREAS OUT OF WAY OF BUILDING CONSTRUCTION. PREPARE AND STABILIZE
- FINAL SITE GRADING BY ADDING TOPSOIL, SEED, MULCH AND FERTILIZER. 10. AFTER BUILDINGS ARE COMPLETED, FINISH ALL REMAINING LANDSCAPED WORK
- 11. REMOVE TRAPPED SEDIMENTS FROM COLLECTION DEVICES AS APPROPRIATE, AND THEN REMOVE TEMPORARY EROSION CONTROL MEASURES UPON COMPLETION OF FINAL STABILIZATION OF THE SITE.
- 12. THE TOWN RESERVES THE RIGHT TO REQUIRE ADDITIONAL SEDIMENT AND EROSION CONTROL MEASURES.


#### **GENERAL CONSTRUCTION NOTES**

- THE TEMPORARY BMPS ASSOCIATED WITH THIS PROJECT WILL BE THE RESPONSIBILITY OF THE CONTRACTOR AND LANDOWNER, WHO WILL BE RESPONSIBLE FOR INSPECTION, OPERATION, AND
- 2. EROSION CONTROL PROCEDURES SHALL CONFORM TO SECTION 645 OF THE "STANDARD SPECIFICATION FOR ROAD AND BRIDGE CONSTRUCTION OF THE NHDOT". EROSION CONTROL SHALL BE INSTALLED DOWNHILL OF ALL AREAS WHERE WORK WILL EXPOSE UNPROTECTED SOIL TO PREVENT SEDIMENT FROM ENTERING CATCH BASINS, DRAINAGE STRUCTURES AND/OR DRAINAGE WAYS. INSTALL TEMPORARY SEDIMENT AND EROSION CONTROL MEASURES PRIOR TO ANY EARTH MOVING OPERATIONS.
- 3. EROSION CONTROL DEVICES SHALL BE INSTALLED WHERE REQUIRED PRIOR TO ANY ON-SITE GRADING OR DISTURBANCE OF EXISTING SURFACE MATERIAL. EROSION CONTROL MEASURES SHALL BE MAINTAINED DURING DEVELOPMENT AND SHALL BE CHECKED PERIODICALLY AND EXCESS SILT SHALL BE REMOVED.
- 4. ALL DISTURBED AREAS WHICH ARE FINISH GRADED SHALL BE LOAMED (4" MINIMUM) AND SEEDED. SEE SEEDING AND FERTILIZER SPECIFICATION. SEE SLOPE DESIGN AND/OR LANDSCAPE PLAN FOR ADDITIONAL
- 5. ALL DRAINAGE SYSTEMS (DITCHES, SWALES, DRAINAGE PONDS/BASINS, ETC.) SHALL BE STABILIZED PRIOR TO DIRECTING RUNOFF TO THEM. STORMWATER FLOWS ARE NOT TO BE DIRECTED TO THESE SYSTEMS UNTIL CONTRIBUTING AREAS HAVE ALSO BEEN FULLY STABILIZED
- 6. SILT FENCES AND/OR SILTSOXX SHALL BE PERIODICALLY INSPECTED DURING THE LIFE OF THE PROJECT AND AFTER EACH STORM. ALL DAMAGED SILT FENCES AND/OR SILTSOXX SHALL BE REPAIRED. SEDIMENT DEPOSITS SHALL PERIODICALLY BE REMOVED AND DISPOSED IN A SECURE LOCATION.
- 7. THE SMALLEST PRACTICAL AREA SHALL BE DISTURBED DURING CONSTRUCTION, BUT IN NO CASE SHALL EXCEED 5 ACRES AT ANY ONE TIME BEFORE DISTURBED AREAS ARE STABILIZED. ALL DISTURBED AREAS SHALL BE STABILIZED WITHIN 72 HOURS AFTER FINAL GRADING. EXPOSURE OF UNSTABILIZED SOILS SHALL BE TEMPORARILY STABILIZED AS SOON AS POSSIBLE BUT NO LATER THAN 45 DAYS OF INITIAL
- 8. WINTERIZATION EFFORTS FOR AREAS NOT STABILIZED BY OCT. 15TH SHALL BE MADE BY THE APPROPRIATE USE OF MATTING, BLANKETS, MULCH AND SEEDING.
- 9. AN AREA SHALL BE CONSIDERED STABLE IF ONE OF THE FOLLOWING HAS OCCURRED:
- A. BASE COURSE GRAVELS HAS BEEN INSTALLED IN AREAS TO BE PAVED;
- B. A MINIMUM OF 85% VEGETATED GROWTH HAS BEEN ESTABLISHED;
- C. A MINIMUM OF 3" OF NON-EROSIVE MATERIAL SUCH AS STONE OR RIP RAP HAS BEEN INSTALLED;
- D. EROSION CONTROL BLANKETS HAVE BEEN PROPERLY INSTALLED.
- 16. IF, DURING CONSTRUCTION, IT BECOMES APPARENT THAT ADDITIONAL EROSION CONTROL MEASURES ARE REQUIRED TO STOP ANY EROSION ON THE CONSTRUCTION SITE DUE TO ACTUAL SITE CONDITIONS, THE CONTRACTOR SHALL BE REQUIRED TO IMMEDIATELY INSTALL AND MAINTAIN THE NECESSARY EROSION

### SEEDING SPECIFICATION

- TEMPORARY SEED
- A. TEMPORARY VEGETATIVE COVER SHOULD BE APPLIED WHERE EXPOSED SOIL SURFACES WILL NOT BE FINAL GRADED WITHIN 45 DAYS.
- B. SEED BED PREPARATION SHALL BE IN ACCORDANCE WITH THE NHDES STORMWATER MANAGEMENT
- MANUAL. VOLUME 3, TEMPORARY VEGETATION SECTION.

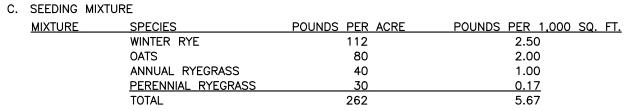

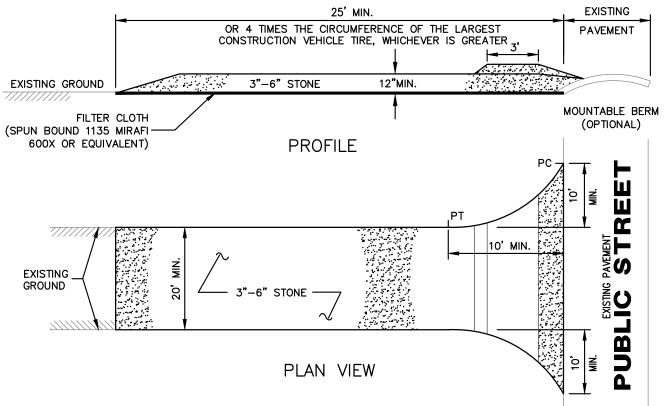

- 1. FILTER CLOTH WILL BE PLACED OVER THE ENTIRE AREA PRIOR TO PLACING OF STONE SURFACE.
- 2. WATER ALL SURFACE WATER FLOWING OR DIVERTED TOWARD CONSTRUCTION ENTRANCES SHALL BE PIPED ACROSS THE ENTRANCE. IF PIPING IS IMPRACTICAL, A MOUNTABLE BERM WITH 5:1 SLOPES WILL BE
- 3. MAINTENANCE THE ENTRANCE SHALL BE MAINTAINED IN A CONDITION WHICH WILL PREVENT TRACKING OR FLOWING OF SEDIMENT ONTO PUBLIC RIGHTS-OF-WAY. THIS MAY REQUIRE PERIODIC TOP DRESSING WITH ADDITIONAL STONE AS CONDITIONS DEMAND AND REPAIR AND/OR CLEANOUT OF ANY MEASURES USED TO TRAP SEDIMENT. ALL SEDIMENT SPILLED, DROPPED, WASHED OR TRACKED ONTO PUBLIC RIGHTS-OF-WAY MUST BE REMOVED IMMEDIATELY.
- 4. WASHING WHEELS SHALL BE CLEANED TO REMOVE SEDIMENT PRIOR TO ENTRANCE ONTO PUBLIC RIGHTS-OF-WAY. WHEN WASHING IS REQUIRED, IT SHALL BE DONE ON AN AREA STABILIZED WITH STONE AND WHICH DRAINS INTO AN APPROVED SEDIMENT TRAPPING DEVICE.
- 5. PERIODIC INSPECTION AND NEEDED MAINTENANCE SHALL BE PROVIDED AFTER EACH RAIN STORM EVENT.

## USDA-SCS STABILIZED TRACKING PAD

NOT TO SCALE

- 2. SEEDING SCHEDULE
  - A. SPRING SEEDING USUALLY GIVES THE BEST RESULTS FOR ALL SEED MIXES OR WITH LEGUMES B. PERMANENT SEEDING SHOULD BE COMPLETED 45 DAYS PRIOR TO THE FIRST KILLING FROST.
  - SEEDING CANNOT BE DONE WITHIN THE SPECIFIED SEEDING DATES, MULCH ACCORDING TO THE NEW HAMPSHIRE STORMWATER MANAGEMENT MANUAL, VOLUME 3, CONSTRUCTION PHASE EROSION AND SEDIMENT CONTROLS AND DELAY SEEDING UNTIL THE NEXT RECOMMENDED SEEDING PERIOD. ESTABLISHING A STAND OF GRASS
  - A. STONES AND TRASH SHOULD BE REMOVED FROM LOAMED AREAS SO AS NOT TO INTERFERE WITH
  - THE SEEDING PROCESS. B. WHERE THE SOIL HAS BEEN COMPACTED BY CONSTRUCTION OPERATIONS, LOOSEN SOIL TO A DEPTH OF 2 INCHES BEFORE APPLYING FERTILIZER, LIME AND SEED.
  - C. IF APPLICABLE, FERTILIZER AND ORGANIC SOIL AMENDMENTS SHOULD BE APPLIED DURING THE GROWING SEASON.
  - D. APPLY LIMESTONE AND FERTILIZER ACCORDING TO SOIL TEST RECOMMENDATIONS. IF SOIL TESTING IS NOT FEASIBLE ON SMALL OR VARIABLE SITES, OR WHERE TIMING IS CRITICAL, FERTILIZER MAY BE APPLIED AT THE RATE OF 600 POUNDS PER ACRE OR 13.8 POUNDS PER 1,000 SQUARE FEET OF LOW PHOSPHATE FERTILIZER (N-P205-K20) OR EQUIVALENT. APPLY LIMESTONE (EQUIVALENT TO 50 PERCENT CALCIUM PLUS MAGNESIUM OXIDE) AT A RATE OF 3 TONS PER ACRE (138 LB. PER 1,000
  - E. FERTILIZER SHOULD BE RESTRICTED TO A LOW PHOSPHATE, SLOW RELEASE NITROGEN FERTILIZER
  - 4. SEED SHOULD BE SPREAD UNIFORMLY BY A METHOD MOST APPROPRIATE FOR THE SITE. METHODS INCLUDING HAND, CYCLONE SEEDER, DRILL, CULTIPACKER TYPE SEEDER OR HYDROSEEDER.
  - A. INOCULATE ALL LEGUME SEED WITH THE CORRECT TYPE AND AMOUNT OF INOCULANTS B. NORMAL SEEDING DEPTH IS FROM 1/4 TO 1/2 INCH. HYDROSEEDING THAT INCLUDES MULCH MAY BE LEFT ON SOIL SURFACE. SEEDING RATES MUST BE INCREASED 10 % WHEN HYDROSEEDING.
  - C. WHERE FEASIBLE, EXCEPT WHERE EITHER A CULTIPACKER TYPE SEEDER OR HYDROSEEDER IS USED, THE SEEDBED SHOULD BE FIRMED FOLLOWING SEEDING OPERATIONS WITH A ROLLER, OR LIGHT DRAG
  - D. THE GRADE "A" OF SEEDING MIXTURE SHOULD BE USED WITH THE FOLLOWING SEEDING RATES BASED ON THE SEEDING GUIDE

MIXTURE	SPECIES	POUNDS PER ACRE	POUNDS PER 1,000 SQ. FT.
Α	TALL FESCUE	20	0.45
	CREEPING RED FESCUE	20	0.45
	DEDTAD	2	0.05


ALTERNATE PERMANENT SEEDING FOR AREAS NOT RECEIVING LAWN OR LANDSCAPING SHALL BE A

- A. THE NEW ENGLAND EROSION CONTROL/RESTORATION MIX CONTAINS A SELECTION OF NATIVE GRASSES AND WILDFLOWERS DESIGNED TO COLONIZE GENERALLY MOIST, RECENTLY DISTURBED SITES WHERE QUICK GROWTH OF VEGETATION IS DESIRED TO STABILIZE THE SOIL SURFACE. THIS MIX IS PARTICULARLY APPROPRIATE FOR DETENTION BASINS WHICH DO NOT NORMALLY HOLD STANDING WATER. THE PLANTS IN THIS MIX CAN TOLERATE INFREQUENT INUNDATION, BUT NOT CONSTANT FLOODING. IN NEW ENGLAND, THE BEST RESULTS ARE OBTAINED WITH A SPRING OR EARLY FALL SUMMER AND FALL SEEDING CAN BE SUCCESSFUL WITH A LIGHT MULCHING OF WEED-FREE STRAW TO CONSERVE MOISTURE. LATE FALL AND WINTER DORMANT SEEDING REQUIRE A SLIGHT INCREASE IN THE SEEDING RATE. FERTILIZATION IS NOT REQUIRED UNLESS THE SOILS ARE PARTICULARLY INFERTILE
- B. APPLICATION RATE: 35 LBS/ACRE 1245 SQ FT/LB
- C. SPECIES: SWITCHGRASS (PANICUM VIRGATUM), CREEPING RED FESCUE (FESTUCA RUBRA), VIRGINIA WILD RYE (ELYMUS VIRGINICUS), FOX SEDGE (CAREX VULPINOIDEA), CREEPING BENTGRASS (AGROSTIS STOLONIFERA), SILKY WILD RYE (ELYMUS VILLOSUS), NODDING BUR-MARIGOLD (BIDENS CERNUA), SOFT RUSH (JUNCUS EFFUSUS), GRASS-LEAVED GOLDENROD (SOLIDAGO GRAMINIFOLIA), SENSITIVE FERN (ONOCLEA SENSIBILIS), JOE-PYE WEED (EUPATORIUM MACULATUM), BONESET (EUPATORIUM PERFOLIATUM), FLAT-TOP ASTER (ASTER UMBELLATUS), NEW YORK ASTER (ASTER NOVI-BELGII) BLUE VERVAIN (VERBENA HASTATA).

- 1. ALL PROPOSED VEGETATED AREAS WHICH DO NOT EXHIBIT A MINIMUM OF 85% VEGETATIVE GROWTH BY OCTOBER 15TH, OR WHICH ARE DISTURBED AFTER OCTOBER 15TH, SHALL BE STABILIZED BY SEEDING AND INSTALLING EROSION CONTROL BLANKETS ON SLOPES GREATER THAN 3:1, AND SEEDING AND PLACING 3 TO 4 TONS OF MULCH PER ACRE, SECURED WITH ANCHORED NETTING, ELSEWHERE. THE INSTALLATION OF EROSION CONTROL BLANKETS OR MULCH AND NETTING SHALL NOT OCCUR OVER ACCUMULATED SNOW OR ON FROZEN GROUND AND SHALL BE COMPLETED IN ADVANCE OF THAW OR SPRING MELT EVENTS;
- ALL AREAS TO BE PLANTED WHICH DO NOT EXHIBIT A MINIMUM OF 85% VEGETATIVE GROWTH BY OCTOBER 15TH, OR WHICH ARE DISTURBED AFTER OCTOBER 15TH, SHALL BE STABILIZED TEMPORARILY WITH STONE OR EROSION CONTROL BLANKETS APPROPRIATE FOR THE DESIGN FLOW CONDITIONS.
- 3. AFTER OCTOBER 15TH, INCOMPLETE SURFACES TO BE PAVED, WHERE WORK HAS STOPPED FOR THE WINTER SEASON, SHALL BE PROTECTED WITH A MINIMUM OF 3 INCHES OF CRUSHED GRAVEL PER NHDOT ITEM 304.3 OR CRUSHED STONE.

### MAINTENANCE AND PROTECTION

- 1. THE CONTRACTOR SHALL TAKE WHATEVER MEASURES ARE NECESSARY TO PROTECT THE GRASS WHILE I DEVELOPS.
- 2. TO BE ACCEPTABLE, SEEDED AREAS SHALL CONSIST OF A UNIFORM STAND OF AT LEAST 90 PERCENT ESTABLISHED PERMANENT GRASS SPECIES, WITH A UNIFORM COUNT OF AT LEAST 100 PLANTS PER
- 3. SEEDED AREAS WILL BE FERTILIZED AND RE-SEEDED AS NECESSARY TO INSURE VEGETATIVE
- 4. THE SWALES WILL BE CHECKED WEEKLY AND REPAIRED WHEN NECESSARY, UNTIL ADEQUATE VEGETATION
- 5. THE SILT FENCE AND/OR SILTSOXX BARRIER AND ANY OTHER EROSION CONTROL DEVICE SHALL BE CHECKED AFTER EACH RAINFALL AND AT LEAST DAILY DURING PROLONGED RAINFALL.
- 6. ALL EROSION CONTROL DEVICES SHALL BE REMOVED ONCE VEGETATION IS ESTABLISHED, AND DISTURBED AREAS RESULTING FROM SLIT FENCE AND/OR SILTSOXX REMOVAL SHALL BE PERMANENTLY

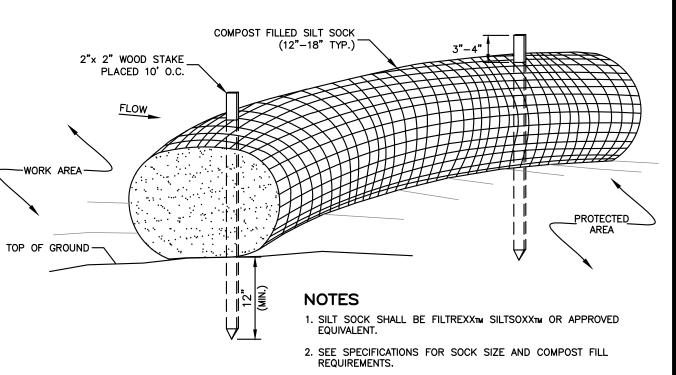

3. SILT SOCK SHALL BE INSPECTED PERIODICALLY AND AFTER ALL STORM EVENTS, AND REPAIR OR REPLACEMENT SHALL BE PERFORMED AS NEEDED.

4. COMPOST MATERIAL SHALL BE DISPERSED ON SITE, AS DETERMINED BY THE ENGINEER. <u>SILT SOCK DETAI</u>

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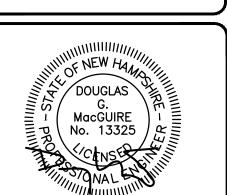
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**REVISIONS:** 

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PROJECT:

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—FOR/OWNER—

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SHEET TITLE:

CONSTRUCTION **DETAILS** 

PROJECT #649 SHEET 9 of 9