

HUDSON LOGISTICS CENTER

LOWELL AND STEELE ROADS
HUDSON, NEW HAMPSHIRE

PREPARED FOR

LANGAN

888 BOYLSTON STREET BOSTON, MASSACHUSETTS (617) 824-9100

RECORD OWNERS

GREENMEADOW GOLF CLUB, INC., THOMAS P. FRIEL & PHILIP J. FRIEL, III

55 MARSH ROAD HUDSON, NEW HAMPSHIRE 03051 (603) 882-8893

267 LOWELL RD HUDSON, LLC

c/o RAM MNGT CO., LLC 200 US RTE 1, STE 200 SCARBOROUGH, ME 04070

21 APRIL 2020

13 REVISED
13 JULY 2020

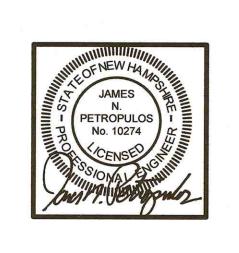


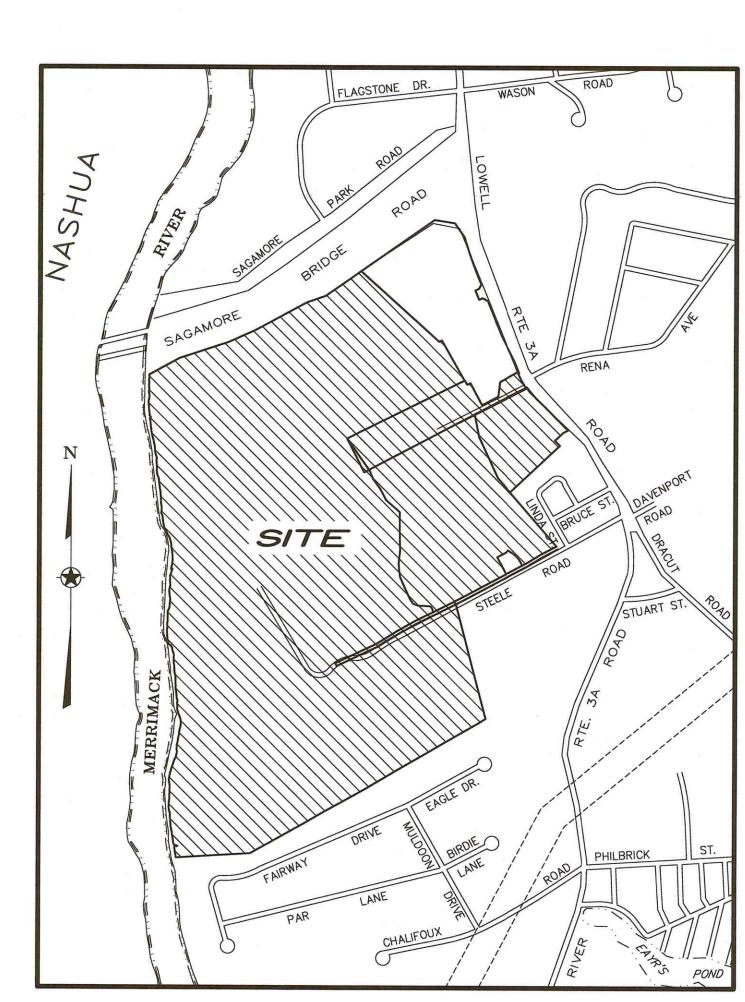
Civil Engineers/Land Surveyors

3 Congress Street
Nashua, NH 03062
(603) 883-2057

Civil Engineers/Land Surveyors
131 Middlesex Turnpike
Burlington, MA 01803
(781) 203-1501

www.hayner-swanson.com









SHEET

No.

1 OF 17

2 OF 17

10 OF 17

1 OF 22

2 OF 22

3-6 OF 22

7-9 OF 22

10-12 OF 22

13-16 OF 22

17 OF 22

18 OF 22

22 OF 22

DATE OF MEETING:

19-21 OF 22

11-17 OF 17

INDEX OF PLANS

ABUTTERS, NOTES & LEGEND PLAN

TOPOGRAPHIC SUBDIVISION PLAN

SITE DEMOLITION PLAN

EROSION CONTROL PLAN

DETAIL SHEET - GENERAL

DETAIL SHEET - EROSION CONTROL

PHOTOMETRIC SITE LIGHTING PLAN

APPROVED BY THE HUDSON, NH PLANNING BOARD

SUBDIVISIONS ARE VALID FOR TWO YEARS FROM THE DATE OF PLANNING BOARD MEETING FINAL APPROVAL. FOR AN APPLICANT TO GAIN AN EXEMPTION FROM ALL SUBSEQUENT CHANGES IN SUBDIVISION

EGULATIONS, SITE PLAN REGULATIONS AND CHANGES TO THE ZONING ORDINANCE, SEE NH RSA 674:39

DETAIL SHEET - WATER

SITE LIGHTING DETAILS

PLAN & PROFILES

ROAD LAYOUT PLAN

MASTER PLAN - GREEN MEADOW DRIVE

TITLE

1" = 100"

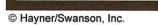
1" = 40' H

1"= 4" V

1"= 40"

1"= 40"

1"= 40"



NH STATE PLANE

RIPARIAN NOTE:

THE PORTION OF THE MERRIMACK RIVER DEPICTED ON THIS PLAN, IS IDENTIFIED ON THE OFFICIAL LIST OF PUBLIC WATERS PURSUANT TO RSA 271:20II AND ALSO ON THE NHDES LIST OF WATERBODIES SUBJECT TO RSA 483-B, THE SHORELAND WATER QUALITY PROTECTION ACT (SWQPA).

UNDER THE PUBLIC TRUST DOCTRINE THE STATE HOLDS RIGHTS FOR USE BY THE PUBLIC OF THE WATER WAY FOR THE PEOPLE OF NEW HAMPSHIRE. FOR THE PURPOSE OF THIS SURVEY THE MEAN HIGH WATER LINE OF THE MERRIMACK

RIVER WAS HELD FOR COMPUTING LAND AREAS. THE UNDERLYING FEE OWNERSHIP FOR THE MERRIMACK RIVER IS NOT DETERMINED BY THIS SURVEY. OWNERSHIP MAY EXTEND TO CENTERLINE AS DEFINED BY COMMON LAW.

THE JURISDICTIONAL LINE BETWEEN THE TOWN OF HUDSON AND THE CITY OF NASHUA IS DEFINED BY THE CENTERLINE OF THE MERRIMACK RIVER.

LOT AREA TABLE (AFTER SUBDIVISION) TOTAL AREA AREA OF AREA SLOPE>25% FRONTAGE **NET USABLE AREA** WETLAND (AC.) (ACRES) (ACRES) (FT) (ACRES) MAP 233, LOT 1 159.75± 17.04± 6.52± 139.19± 1,792.24 MAP 234, LOT 5 111.516 18.70± 1.42+ 2,999.34 91.40± MAP 234, LOT 34 12.994 1.66± $0.55 \pm$ 10.78± 1,361.03 MAP 234, LOT 35 13.246 N/A± N/A 1,048.75 MAP 239, LOT 1 95.68± 1.55 6.50± 87.63± 200 ROADWAY 5.926 0.89± N/A N/A N/A

RIVER RD.

- OLD LOT LINE TO

BE EXTINGUISHED

- OLD LOT LINE TO

MAP 233

PROPOSED 159.75± ACRES

(6,958,710± SF)

(DOES NOT INCLUDE

AREA WITHIN THE

MERRIMACK

MERRIMACK RIVER)

BE EXTINGUISHED

► ZONING NOTE 4 THE ZONING/BUILDING SETBACKS DEPICTED ON THIS PLAN ARE THOSE THE MUNICIPALITY AND, AS SUCH, ARE ONLY OPINIONS EXPRESSED B HAYNER/SWANSON, INC. THE FINAL INTERPRETATION OF THE ORDINANCE CAN ONLY BE MADE BY THE APPROPRIATE ZONING OTHER FACTORS CAN AFFECT THE SETBACKS, PRIOR TO ANY DEVELOPMENT OF THIS PROPERTY, THE BUILDER/OWNER MUST

MAP 234

-5-

PROPOSED

(4,857,647 SF)

EXISTING

48. 024 ACRES

516 ACRES

RIVER

WE HAVE INTERPRETED FROM THE LATEST ZONING ORDINANCE OF AUTHORITY. SINCE BUILDING ORIENTATION, PROPOSED USES, AND CONSULT WITH THE TOWN/CITY TO INSURE THE CORRECT

APPLICATION OF THE ZONING ORDINANCE.

PERMITS:

- TERRAIN PERMIT No. AoT-___, DATE ISSUED: _____
- APPROVAL No. _____, DATE ISSUED: ___

NOTE: THE CONTRACTOR SHALL COMPLY WITH ALL STIPULATIONS AND CONDITIONS OF PERMITS AND APPROVALS.

SEE SHEET 2 OF 17 FOR VICINITY PLAN. LEGEND, ABUTTERS AND ADDITIONAL INFORMATION.

APPROVED BY THE HUDSON, NH PLANNING BOARD DATE OF MEETING:

SECRETARY: SIGNATURE DATE: SUBDIVISIONS ARE VALID FOR TWO YEARS FROM THE DATE OF PLANNING BOARD MEETING FINAL APPROVAL. FOR AN APPLICANT TO GAIN AN EXEMPTION FROM ALL SUBSEQUENT CHANGES IN SUBDIVISION REGULATIONS, SITE PLAN REGULATIONS AND CHANGES TO THE ZONING ORDINANCE. SEE NH RSA 674:39.

FOR GREENMEADOW GOLF CLUB, INC. THOMAS P. FRIEL PHILIP J. FRIEL, III FOR 267 LOWELL RD HUDSON, LLC

DATE

HUDSON, NH

APPROX. TOWN LINE

NASHUA. NH

CERTIFICATION

MAP 239

PROPOSED

(4,167,980± SF) EXISTING 24. 12± ACRES

(DOES NOT INCLUDE AREA WITHIN THE

MERRIMACK RIVER)

5 68± ACRES

I HEREBY CERTIFY, TO MY KNOWLEDGE, INFORMATION AND BELIEF, THAT THIS PLAN SHOWS THE RESULTS OF AN ON THE GROUND "STANDARD PROPERTY SURVEY" AND THAT SAID SURVEY MEETS THE MINIMUM PRECISION AND/OR ACCURACY MEASUREMENTS FOR SURVEY CLASSIFICATION "U" (URBAN) AS SET FORTH IN TABLE 500.1 OF THE NEW HAMPSHIRE CODE OF ADMINISTRATIVE RULES OF THE BOARD OF LICENSURE FOR LAND SURVEYORS ADOPTED 08/23/01, EFFECTIVE 01/01/09.

I FURTHER CERTIFY THAT THIS PLAN IS THE RESULT OF AN ACTUAL FIELD SURVEY MADE ON THE GROUND AND HAS A MAXIMUM ERROR OF CLOSURE OF ONE PART IN FIFTEEN THOUSAND ON ALL PROPERTY LINES WITHIN AND BORDERING THE SUBJECT PROPERTY.

LEE B. GAGNON, LLS

PLAN REFERENCES:

- PLAN OF LAND BELONGING TO ALPHONSE J. RAUDONIS, HUDSON, NEW HAMPSHIRE, SCALE: 1" = 200', DATED: DECEMBER 1950, SURVEYOR: G.R. HYDE. RECORDED: HCRD - PLAN No. 270
- PLAN OF LAND OF E. STUART & DORIS E. GROVES, HUDSON, NH. SCALE: 1" = 100', DATED: MAY 1951, LOTS ADDED AUGUST 1953, LOT 7A ADDED DECEMBER 1953 DUPONT & TATE ADDED OCTOBER 1955, AND PREPARED BY: NED SPAULDING.
- RECORDED: HCRD PLAN No. 1231 PLAN OF LAND OF GORDON B. TATE, LOWELL ROAD, HUDSON, NEW HAMPSHIRE, SCALE: 1" = 50', DATED: MAY 1956 WITH AMENDMENTS THRU FEBRUARY 1959, PREPARED BY: NED SPAULDING.
- RECORDED: HCRD PLAN No. 1701 BROOKHAVEN, STEELE ROAD, HUDSON, NEW HAMPSHIRE, RECORD OWNER: JOSEPH A.
- DUROCHER, SCALE: 1" = 50', DATED: JUNE 28, 1960, SURVEYOR: EARLE WILLIAMS. RECORDED: HCRD - PLAN No. 1856
- PLAN OF LAND OF JOHN S & PHYLLIS B. GROVES, LOWELL ROAD HUDSON, NH, SCALE: 1"= 80' DATED JANUARY 1956 BY NED SPAULDING RECORDED: HCRD - PLAN No. 2833
- RELOCATION OF LOT LINES FOR, COLUMBIANITES, INC. & GEORGE W. GAGNON, LOWELL ROAD. HUDSON, NEW HAMPSHIRE, SCALE: 1" = 100', DATED: MAY 1979, AND PREPARED BY: MAURICE G. RECORDED: HCRD - PLAN No. 12291
- PLAN OF LAND, GREEN MEADOW SUBDIVISION, HUDSON, NEW HAMPSHIRE. RECORD OWNERS: RODGERS BROTHERS, INC, SCALE: 1" = 100', DATED: SEPTEMBER 1976, AND PREPARED BY: PIANTIDOSI ASSOCIATES INC. RECORDED: HCRD - PLAN No. 13146
- SUBDIVISION & CONSOLIDATION PLAN, LOWELL ROAD, HUDSON, NEW HAMPSHIRE, FOR: MICHAEL CALLAHAN AND WILLIAM McFADDEN, SCALE: 1" = 100', DATED: NOVEMBER 1983, AND PREPARED BY: MAYNARD & PAQUETTE INC. RECORDED: HCRD - PLAN No. 17404
- LOT LINE RELOCATION PLAN LOTS 37 & 39 / MAP 7, 267 LOWELL ROAD, HUDSON, NEW HAMPSHIRE, PREPARED FOR: MICHAEL CALLAHAN, SCALE: 1" = 100', DATED: NOVEMBER 1987, AND PREPARED BY: MAYNARD & PAQUETTE, INC. RECORDED: HCRD - PLAN No. 21758
- CONSOLIDATION PLAN, LOT 1 & 1-1 / MAP 7, GREEN MEADOW BLVD. CONSOLIDATION PLAN. HUDSON, NEW HAMPSHIRE, PREPARED FOR: DAVID FRIEL c/o GREEN MEADOW GOLF CLUB, SCALE" 1" = 100', DATED: FEBRUARY 1, 1987 WITH REVISIONS THRU 6/14/88 AND PREPARED BY: MAYNARD & PAQUETTE INC. RECORDED: HCRD - PLAN No. 22437
- AS-BUILT & EASEMENT PLAN, LOT 5 / MAP 7, MULDOON STREET, HUDSON, NEW HAMPSHIRE, PREPARED FOR: DAVID FRIEL & SOUTHERN NH WATER CO., SCALE: 1" = 20', DATED: SEPTEMBER 11 1990 WITH REVISIONS THRU 10/09/90 AND PREPARED BY: MAYNARD & PAQUETTE, INC. RECORDED: HCRD - PLAN No. 24794
- CONSOLIDATION & RE-SUBDIVISION PLAN OF LANDS, FRIEL, SMITH & WAL-MART STORES, INC. HUDSON, NEW HAMPSHIRE, SCALE: 1" = 100', DATED: 3-5-91 WITH REVISIONS THRU 7-22-91, AND PREPARED BY: HOLDEN ENGINEERING & SURVEYING, INC. RECORDED: HCRD - PLAN No. 25273
- THE STATE OF NEW HAMPSHIRE DEPARTMENT OF TRANSPORTATION, RIGHT OF WAY, PLANS OF PROPOSED NASHUA - HUDSON CIRCUMFERENTIAL HIGHWAY, NH PROJECT No. 10644A, AND PREPARED BY: DELEUW, CATHER & COMPANY, DATED: MAY 1989. ON FILE IN THE RECORDS OF THE NEW HAMPSHIRE DEPARTMENT OF TRANSPORTATION

- NEW HAMPSHIRE DEPARTMENT OF ENVIRONMENTAL SERVICES ALTERATION OF
- NEW HAMPSHIRE DEPARTMENT OF ENVIRONMENTAL SERVICES WETLANDS BUREAU

55 MARSH ROAD HUDSON, NEW HAMPSHIRE 03051 BK. 5693, PG. 1364

NOTES:

TOTAL SITE AREA (PRIOR TO SUBDIVISION):

MINIMUM LOT REQUIREMENTS:

MINIMUM BUILDING SETBACKS REQUIREMENTS

UPON MAP 239, LOT 1, AND MAP 234, LOTS 5, 34 & 35.

THE HOURS BETWEEN 7:00 AM AND 7:00 PM, MONDAY THROUGH SATURDAY.

- FRONT YARD (LOCAL STREETS)

- FRONT YARD (ARTERIAL STREETS)

C. TO CREATE A NEW LOT MAP 233, LOT 1

HORIZONTAL PROJECTION: NH STATE PLANE

WEST OF THE NASHUA LIBRARY

48.024 ACRES

13.729 ACRES

13.246 ACRES

324.12± ACRES

399.12± ACRES

87,120 SF

200 FT

50 FT

A. TO SHOW THE DEDICATION OF PUBLIC RIGHT OF WAY FOR GREEN MEADOW DRIVE

CONSTRUCTION ACTIVITIES INVOLVING THE PROPOSED UNDEVELOPED LOTS SHALL BE LIMITED TO

US SURVEY FEET

* HORIZONTAL AND VERTICAL DATUMS WERE VERIFIED USING G.P.S. (KEYNET

LOT NUMBERS REFER TO THE TOWN OF HUDSON ASSESSORS MAPS 227, 228, 233, 234, 239, 240, 245

NETWORK) WITH OBSERVATIONS ON SITE AND ON NGS (FORMERLY USGS) "DISK D-26" LOCATED ON THE NORTHERLY SIDE OF NH ROUTE 101A, APPROXIMATELY 4.5 MILES

NAD83(1986)*

LOTS ARE TO BE SERVICED BY TOWN WATER AND TOWN SEWER AND/OR ON-SITE SEPTIC

STREET ADDRESSES TO BE ACQUIRED FROM THE HUDSON FIRE DEPARTMENT PRIOR TO THE

IRON PINS TO BE SET AT ALL LOT CORNERS AND STONE BOUNDS TO BE SET ALL POINTS OF TANGENCY AND CURVATURE ON THE RIGHT-OF-WAY BY A LICENSED LAND SURVEYOR PRIOR TO

WETLAND DELINEATION BY GOVE ENVIRONMENTAL SERVICES, INC. AND FLAG LOCATIONS WERE

RECORDED AT THE HILLSBOROUGH COUNTY REGISTRY OF DEEDS. REMAINING SHEETS ARE ON

ZONE X AS DETERMINED FROM THE FLOOD INSURANCE STUDY (FIRM), HILLSBOROUGH COUNTY. TOWN OF HUDSON, NEW HAMPSHIRE, COMMUNITY No. 330092, PREPARED BY THE FEDERAL

WAIVER REQUESTED: HUDSON SUBDIVISION REGULATION CHAPTER 89, SECTION 289-18(2) - CUL-

ALL SIGNS SUBJECT TO APPROVAL BY THE HUDSON PLANNING BOARD PRIOR TO INSTALLATION

GREEN MEADOW DRIVE SHALL RECEIVE FINAL APPROVAL BY THE TOWN OF HUDSON ENGINEERING AND PUBLIC WORKS DEPARTMENT PRIOR TO ACCEPTANCE BY THE BOARD OF SELECTMEN AS A

MAP 234, LOT 35

BK. 8710, PG. 944

267 LOWELL RD HUDSON, LLC

200 US ROUTE 1, SUITE 200

SCARBOROUGH, ME 04070

c/o RAM MANAGEMENT CO., LLC

PORTIONS OF THIS PARCEL ARE LOCATED WITHIN ZONE AE, ZONE A, ZONE X (SHADED) AND

EMERGENCY MANAGEMENT AGENCY, MAP NUMBERS: 33011C0656D & 33011C0658D, DATED:

SURVEYED BETWEEN APRIL 2006 AND FEBRUARY 2020 BY HAYNER/SWANSON, INC.

THIS PLAN SET CONTAINS SEVENTEEN (17) SHEETS. SHEETS 1 THRU 10 OF 17 SHALL BE

B. TO RELOCATE THE LOT LINES BETWEEN MAP 234, LOTS 5, 34 & 35 AND MAP 239, LOT 1.

NGVD29 (FORMERLY KNOWN AS USGS DATUM)*

43 560 SF

50 FT

G-1; GENERAL-ONE

BUSINESS

MAP 234, LOT 5

MAP 234, LOT 34

MAP 234, LOT 35

MAP 239, LOT 1

- LOT AREA

- LOT FRONTAGE

- REAR YARD

HORIZONTAL DATUM:

VERTICAL DATUM:

ISSUANCE OF ANY BUILDING PERMIT.

PRESENT OWNERS OF RECORD:

55 MARSH ROAD

LOT 34, MAP 234

THE ISSUANCE OF CERTIFICATES OF OCCUPANCY.

FILE AT THE TOWN OF HUDSON, NH PLANNING DEPT.

MAP 234, LOT 5 & MAP 239, LOT 1

GREENMEADOW GOLF CLUB, INC.

HUDSON, NEW HAMPSHIRE 03051

THOMAS P. FRIEL & PHILIP J. FRIEL, III

BK. 5581, PG. 800 & 802

BK. 1668, PG. 239 & 241

PRESENT ZONING:

PURPOSE OF PLAN:

SURVEY CONTROL DATA:

07/13/20 ADDRESS TOWN COMMENTS

MASTER LOT LINE ADJUSTMENT/ SUBDIVISION PLAN (MAP 234, LOTS 5, 34 & 35 AND MAP 239. LOT 1)

LOWELL AND STEELE ROADS HUDSON, NEW HAMPSHIRE

888 BOYLSTON STREET BOSTON, MASSACHUSETTS 02116 (617) 824-9100

GREENMEADOW GOLF CLUB, INC.,
THOMAS P. FRIEL & PHILIP J. FRIEL, III

55 MARSH ROAD HUDSON, NEW HAMPSHIRE 03051 (603) 882-8893 and 267 LOWELL RD HUDSON, LLC

c/o RAM MNGT CO., LLC 200 US RTE 1, STE 200 SCARBOROUGH, ME 04070 VIIA VIIA (IIIIIIIIIIIIIIII SCALE: 1"=400 Feet 1"=121.921 Meters

21 APRIL 2020



131 Middlesex Turnpike 3 Congress Street Nashua, NH 03062 Burlington, MA 01803 (603) 883-2057 (781) 203-1501 www.hayner-swanson.com

FIELD BOOK: --DRAWING NAME: 3867L_SUB FS71 3867L SUB 1 OF 17 DRAWING LOC: J: \3000\3867\DWG\3867L SUB

ABUTTERS:

MAP 221, LOT 8 1987 TAMPOSI LIMITED PARTNERSHIP 20 TRAFALGAR SQUARE, SUITE 602 NASHUA, NH 03063 BK 7830, PG 0318

MAP 227, LOT 1 FLAGSTONE31 REALTY, LLC 31 FLAGSTONE DRIVE HUDSON, NH 03051 PG 8928, PG 1423

MAP 227, LOT 2 25 SAGAMORE PARK, LLC 25 SAGAMORE PARK ROAD HUDSON, NH 03051 BK 8759, PG 2098

MAP 227, LOT 3 COOL CAR STORAGE, LLC 13 JONES ROAD PELHAM, NH 03076 BK 9262, PG 1443

MAP 227, LOT 4
NASH FAMILY INVESTMENT PROPERTIES
91 AMHERST STREET
NAHSUA, NH 03064
BK 2945, PG 0700

MAP 227, LOT 5 ROBERT MIRABELLA c/o CET TECH 27 ROULSTON ROAD WINDHAM, NH 03087 BK 5311, PG 0048

MAP 227, LOT 6
41 SAGAMORE PARK ROAD, LLC
P.O. BOX 669
WINDHAM, NH 03087
BK 8548, PG 0103
MAP 227, LOT 7
TOWN OF HUDSON
12 SCHOOL STREET
HUDSON, NH 03051

BK 5663, PG 0664

BK 5671, PG 0773

BK 6123, PG 0639

MAP 228, LOT 1
M.R.J. REALTY TRUST
c/o MARK R. JAFFE & ALAN G. LAMPERT, TRUSTEES
261 LOWELL ROAD
HUDSON, NH 03051

MAP 228, LOT 5 SAM'S RE BUSINESS TRUST c/o WAL-MART PROPERTY TAX DEPT. P.O. BOX 8050, MS 0555 BENTONVILLE, AR 72716-8050

MAP 228, LOT 7 & 8 HUDSON COMMERCIAL ASSOC., LLC c/o AHOLD FINANCIAL SERVICES P.O. BOX 6500 CARLISLE, PA 17013 BK 7357, PG 1084

MAP 228, LOT 52 KAREN DEXTER & JILL DIAZ 268 A LOWELL ROAD HUDSON, NH 03051 BK 8054, PG 2081

MAP 228, LOT 54 NEW LIFE CHRISTIAN CHURCH 272 LOWELL ROAD HUDSON, NH 03051 BK 8833, PG 0830

MAP 234, LOT 1 STEELE FARM, LLC 2 FRIEL GOLF ROAD HUDSON, NH 03051 BK 5132, PG 0675 MAP 234, LOT 6 GREENMEADOW GOLF CLUB, INC. 55 MARSH ROAD HUDSON, NH 03051 BK 6942, PG 1212

MAP 234, LOT 7 KENNETH MURPHY 2 LINDA STREET HUDSON, NH 03051 BK 5283, PG 1842

MAP 234, LOT 8
GERALD R. DESROCHES FAMILY TRUST c/o J. SCOTT DESROCHES, TRUSTEE 296 DERRY ROAD
HUDSON, NH 03051
BK 6278, PG 0194

MAP 234, LOT 9
PETER R., JR., & THERESA B. GOYETTE
2 DRACUT ROAD
HUDSON, NH 03051

MAP 234, LOT 10 DAVID R. DUNN 8 LINDA STREET HUDSON, NH 03051 BK 7151, PG 1545

BK 6168, PG 0218

MAP 234, LOT 11 SEAN P. & TINA M. STEVENS 10 LINDA STREET HUDSON, NH 03051 BK 6690, PG 1808

MAP 234, LOT 12 MARK TEMPESTA & KRIS MARCOCCIO 12 LINDA STREET HUDSON, NH 03051 BK 9234, PG 2048

MAP 234, LOT 13 ROY & SYLVIA M. CARROLL 16 LINDA STREET HUDSON, NH 03051 BK 1846, PG 0170

MAP 234, LOT 14 DON R. & MELISSA E. WONG 18 LINDA STREET HUDSON, NH 03051 BK 7862, PG 0478

MAP 234, LOT 33 ANNETTE CRAWFORD, TR. & BRENDA DEAN, TR. 277 LOWELL ROAD HUDSON, NH 03051

MAP 234, LOT 36 STEVEN J. GENDRON 94 AARON DRIVE MANCHESTER, NH 03109 BK 8275, PG 1378

BK 8552, PG 0345

MAP 234, LOT 37 JEFFREY S. & MILTON BROWN 3 FRIAR TUCK LANE NASHUA, NH 03062 BK 6335, PG 1708

MAP 240, LOT 1 JOANNE E. WALSH 2 EAGLE DRIVE HUDFSON, NH 03051 BK 4581, PG 0066

MAP 240, LOT 2 JAMES M. & MARIE A. DOBENS 4 EAGLE DRIVE HUDSON, NH 03051 BK 2978, PG 0585

MAP 240, LOT 3 CRAIG C. & COURTNEY M. PROULX 6 EAGLE DRIVE HUDSON, NH 03051 BK 8731, PG 0627 MAP 240, LOT 4
JONATHAN & LAURA L. FONTAINE
8 EAGLE DRIVE
HUDSON, NH 03051

MAP 246, LOT 40

3 FAIRWAY DRIVE

MAP 246, LOT 41

1 FAIRWAY DRIVE

THE MARSCH FAMILY TRUST

HUDSON, NH 03051 7638, PG 0240

SCOTT J. WADE REVOCABLE TRUST

HUDSON, NH 03051 8366, PG 0616

c/o GUILFORD TRANSPORTATION IND.

ABUTTERS WITH 200 FT OF PROPERTY

THE LEONARD & DENISE KINGSLEY REVOCABLE

TRUST AGREEMENT OF FEBRUARY 21, 2002 LEONARD E. & DENISE KINGSLEY, TRUSTEES

MICHELLE J. ROBINSON & MARK A. LEDOUX

c/o SCOTT J. WADE, TRUSTEE

NASHUA ABUTTERS

NORTH BILLERICA, MA 01862

EVERETT N. JR., & MITSU COLE

5036 WINGED FOOT AVENUE

ARTHUR & LESLIE A. LIAKOS

MAP A. LOTS 998 & 999

BOSTON & MAINE CORP.

IRON HORSE PARK

MAP 228, LOT 9

NASHUA, NH 03060

BK 8723, PG 1571

MAP 234, LOT 4

SARASOTA FL 34234

BK 5173, PG 0924

MAP 234, LOT 17

9 LINDA STREET HUDSON, NH 03051

BK 2492, PG 0617

MAP 234, LOT 18

HUDSON, NH 03051

BK 6978, PG 2736

MAP 234, LOT 24

10 BRUCE STREET

HUDSON, NH 03051

BK 7074, PG 1815

MAP 234, LOT 25

7 STEELE ROAD

HUDSON, NH 03051

BK 9125, PG 2539

MAP 234. LOT 31

MISSOUM MOUMENE &

12 SHEPARD HILL ROAD

KOMMA HOLDINGS, LLC

VINCENT F. & DEBRA BRACCIO

BEDFORD, NH 03110

BK 6337, PG 1504

MAP 234, LOT 32

28 WINDING ROAD

MAP 240, LOT 13

27 RIVER ROAD

HUDSON, NH 03051

BK 9168, PG 2666

BK 8538-0576

BEDFORD, NH 03110

FETHIA FADELA MEDJAHED

P.O. BOX 242

ALEJANDRO ASTACIO

GAIL WILSON

P.O. BOX 7274

c/o WILLIAM H. & MARTHA E. MARSCH, TRUSTEES

MAP 240, LOT 5 BRIAN C. NOONE 10 EAGLE DRIVE HUDSON, NH 03051 BK 8415, PG 2621

BK 8652, PG 0479

MAP 240, LOT 6 JOSEPH M. & LAUREN E. DIPILATO 12 EAGLE DRIVE HUDSON, NH 03051 BK 8374, PG 0592

MAP 240, LOT 13-1 DWARKAMAI, INC. 1167 LAKEWOOD CIRCLE NAPERVILLE, IL 60540 BK 8849, PG 2437

MAP 245, LOT 12 RICHARD R. & AUDERY S. LEBOURDAIS 23 FAIRWAY DRIVE HUDSON, NH 03051 BK 8578, PG 1327

MAP 245, LOT 13 JOHN & SAMANTHA KING 21 FAIRWAY DRIVE HUDSON, NH 03051 BK 8893, PG 2772

MAP 245, LOT 14 LEONARD J. & JOHANNAH M. LEONE 19 FAIRWAY DRIVE HUDSON, NH 03051 BK 5871, PG 1105

MAP 245, LOT 15 ROBERT J. & BARBARA COSTELLO 17 FAIRWAY DRIVE HUDSON, NH 03051 BK 4308, PG 0086

MAP 245, LOT 16
PHILLIP G. & ANGELA M. VOLK
15 FAIRWAY DRIVE
HUDSON, NH 03051
BK 7733, PG 2713

MAP 245, LOT 17 TIMOTHY A. & MU-JANE L. MONK 13 FAIRWAY DRIVE HUDSON, NH 03051 BK 8584, PG 0787

MAP 246, LOT 36 SURRI D. & KATHLEEN M. SAKATI 11 FAIRWAY DRIVE HUDSON, NH 03051 BK 5487, PG 1314

MAP 246, LOT 37 DAVID R. GOSSELIN & SUSAN BATES-GOSSELIN 9 FAIRWAY DRIVE HUDSON, NH 03051 BK 7198, PG 0547

MAP 246, LOT 38 SCOTT M. & KIMBERLY M. UBELE 7 FAIRWAY DRIVE HUDSON, NH 03051 BK 8271, PG 2138

MAP 246, LOT 39 CHRISTSOPHER D. MULLIGAN & DIANE K. SORGENFREI 5 FAIRWAY DRIVE HUDSON, NH 03051 BK 5497, PG 1354

DESIGN PROFESSIONALS

JAMES N. PETROPULOS, P.E. HAYNER/SWANSON, INC. 3 CONGRESS STREET NASHUA, NH 03062-3301

LEE B. GAGNON, LLS HAYNER/SWANSON, INC. 3 CONGRESS STREET NASHUA, NH 03062-3301

GOVE ENVIRONMENTAL SERVICES, INC. ATTN: BRENDAN QUIGLEY, CWS 8 CONTINENTAL DRIVE BUILDING 2, UNIT 'H' EXETER, NH 03833-7507

JONH D. PLANTE, P.E.
LANGAN ENGINEERING AND ENVIRONMENTAL ENGINEERING SERVICES, INC.
888 BOYLSTON STREET
BOSTON, MA 02116

MICHAEL SZURA, RLA LANGAN ENGINEERING AND ENVIRONMENTAL ENGINEERING SERVICES, INC. 2700 KELLY ROAD, SUITE 200 WARRINGTON, PA 18976

LEGEND

NHHB	N.H. HIGHWAY BOUND
■ SB	STONE BOUND
● FSB	FIELD STONE BOUND
⊚ I.PIN	IRON PIN
⊚ <i>I.PIPE</i>	IRON PIPE
	STONE BOUND TO BE SET
•	IRON PIN TO BE SET
	BUILDING SETBACK LINE
	WETLAND FLAGGING LIMIT (2017-2020)
	WETLAND FLAGGING LIMIT (2006)
	WETLAND BUFFER LINE
	NHDES SHORELAND PROTECTION DISTRICT
	WIRE FENCE
*	CHAINLINK FENCE
	CURBING
	EDGE OF PAVEMENT
	PROPERTY LINE
	RIGHT OF WAY LINE
	FLOOD ZONE
	ZONE LINE

WETLAND NOTES:

WETLANDS WERE DELECTATED BY GOVE ENVIRONMENTAL SERVICES, INC. BETWEEN NOVEMBER 2017 AND APRIL 2020 UTILIZING THE FOLLOWING STANDARDS:

- REGIONAL SUPPLEMENT TO THE CORPS OF ENGINEERS WETLAND DELINEATION MANUAL: NORTHCENTRAL AND NORTHEAST REGION, (VERSION 2.0) JANUARY 2012, U.S. ARMY CORPS OF ENGINEERS.
- FIELD INDICATORS OF HYDRIC SOILS IN THE UNITED STATES, A GUIDE FOR IDENTIFYING AND DELINEATING HYDRIC SOILS, VERSION 8.0. UNITED STATES DEPARTMENT OF AGRICULTURE (2016).
- 3. NEW ENGLAND HYDRIC SOILS TECHNICAL COMMITTEE. 2018 VERSION 4, FIELD INDICATORS FOR IDENTIFYING HYDRIC SOILS IN NEW ENGLAND. NEW ENGLAND INTERSTATE WATER POLLUTION CONTROL COMMISSION, LOWELL, MA.
- NATIONAL WETLAND PLANT LIST, VERSION 3.2 (2016).

ALL FLAGS WERE LOCATED BY HAYNER/SWANSON, INC USING EITHER GPS UNIT AT TIME OF FLAGGING OR FIELD LOCATED BETWEEN NOVEMBER 2017 AND APRIL 2020. WETLANDS DEPICTED OUTSIDE THE PROJECT AREA WERE OBTAINED FROM 2006 RECORD PLANS.

THIS IS TO CERTIFY THAT THE WETLANDS HAVE BEEN DELINEATED IN ACCORDANCE WITH THE WITH THE U.S. ARMY CORPS OF ENGINEERS JANUARY 2012 REGIONAL SUPPLEMENT TO THE CORPS OF ENGINEERS WETLAND DELINEATION MANUAL: NORTHCENTRAL AND NORTHEAST (REGION 2).

WETLAND DELINEATION PREPARED BY: GOVE ENVIRONMENTAL SERVICES BRENDAN J. QUIGLEY CERTIFIED WETLAND SCIENTIST (#249)

APPROVED BY THE HUDSON, NH PLANNING BOARD DATE OF MEETING: CHAIRMAN: SIGNATURE DATE: SUBDIVISIONS ARE VALID FOR TWO YEARS FROM THE DATE OF PLANNING BOARD MEETING FINAL APPROVAL. FOR AN APPLICANT TO GAIN AN EXEMPTION FROM ALL SUBSEQUENT CHANGES IN SUBDIVISION REGULATIONS, SITE PLAN REGULATIONS AND CHANGES TO THE ZONING ORDINANCE, SEE NH RSA 674:39.



SHUA SITE PHILBRICK VICINITY SCALE: 1" = 1,000± MAP 07/13/20 ADDRESS TOWN COMMENTS No. DATE REVISION BY ABUTTERS, NOTES AND LEGEND PLAN (MAP 234, LOTS 5, 34 & 35 AND MAP 239. LOT 1) UDSON LOGISTICS CENTER LOWELL AND STEELE ROADS HUDSON, NEW HAMPSHIRE PREPARED FOR: LANGAN 888 BOYLSTON STREET BOSTON, MASSACHUSETTS 02116 (617) 824-9100 RECORD OWNERS: GREENMEADOW GOLF CLUB, INC.,
THOMAS P. FRIEL & PHILIP J. FRIEL, III

55 MARSH ROAD HUDSON, NEW HAMPSHIRE 03051 (603) 882-8893 and 267 LOWELL RD HUDSON, LLC c/o RAM MNGT CO., LLC 200 US RTE 1, STE 200 SCARBOROUGH, ME 04070 NO SCALE 21 APRIL 2020 Hayner/Swanson, Inc. Civil Engineers/Land Surveyors 131 Middlesex Turnpike 3 Congress Street Burlington, MA 01803 (781) 203-1501 Nashua, NH 03062 (603) 883-2057 www.hayner-swanson.com FIELD BOOK: --DRAWING NAME: 3867L_SUB FS71

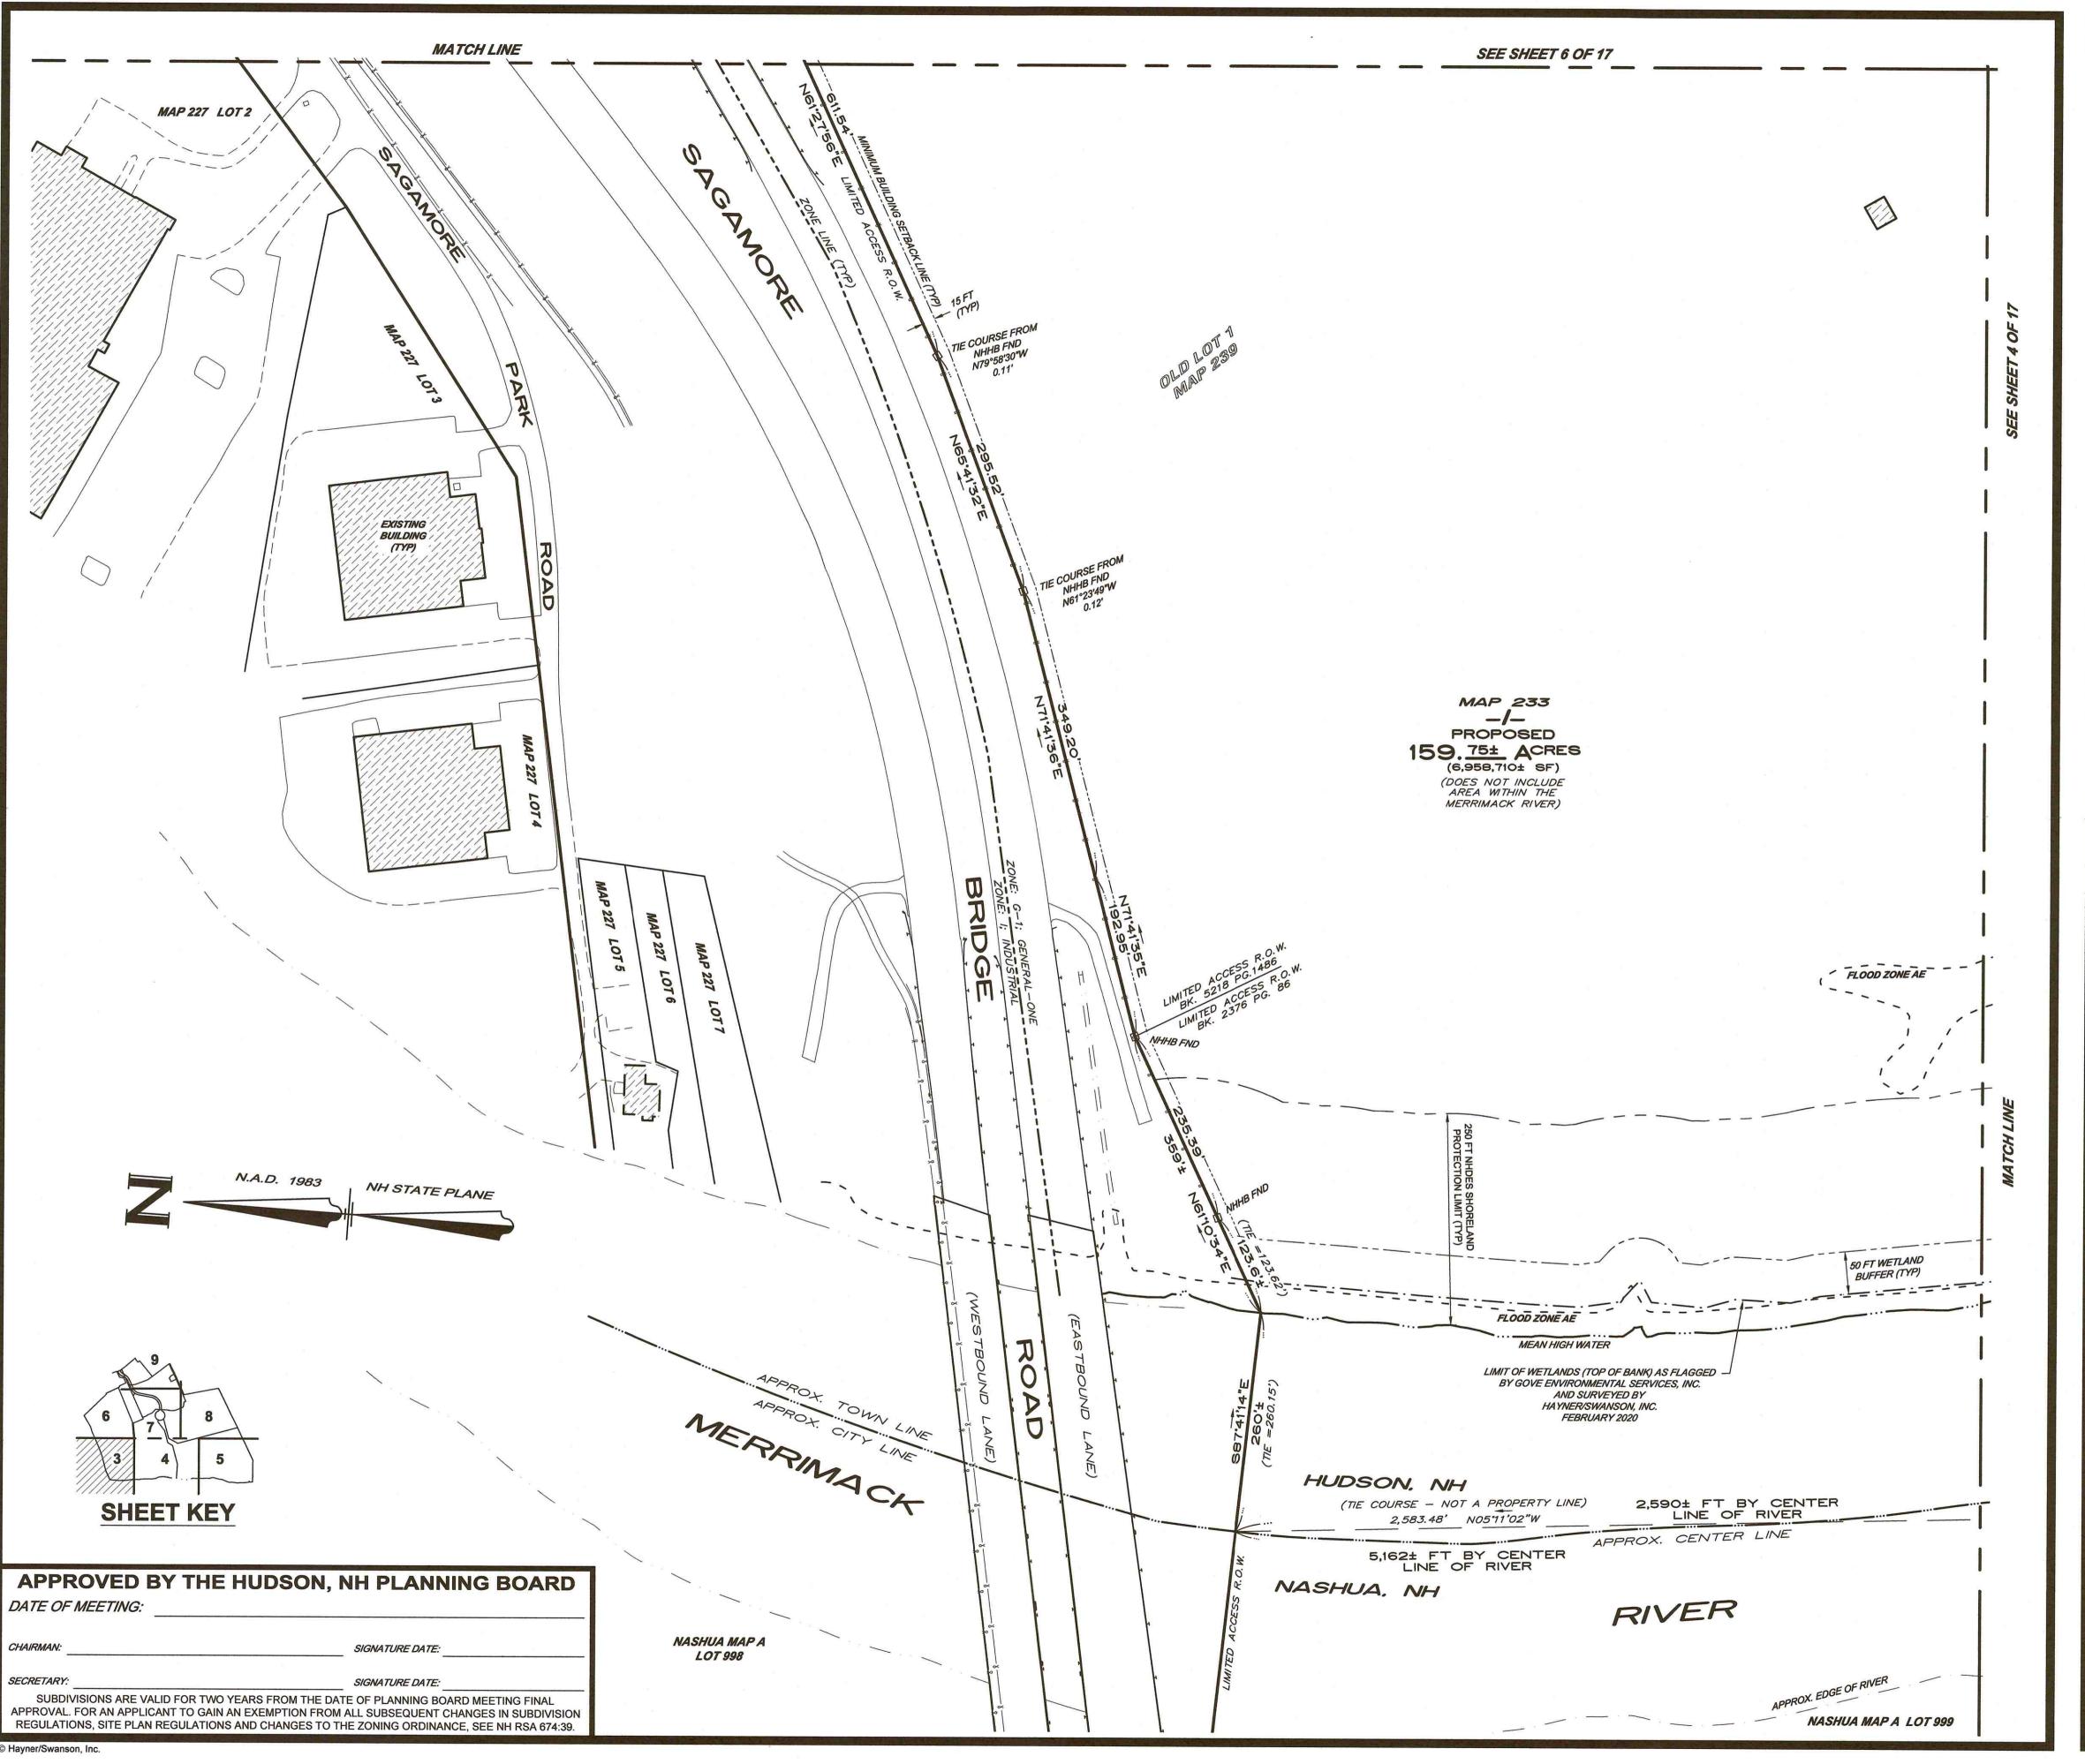
DRAWING LOC: J: \3000\3867\DWG\3867L SUB

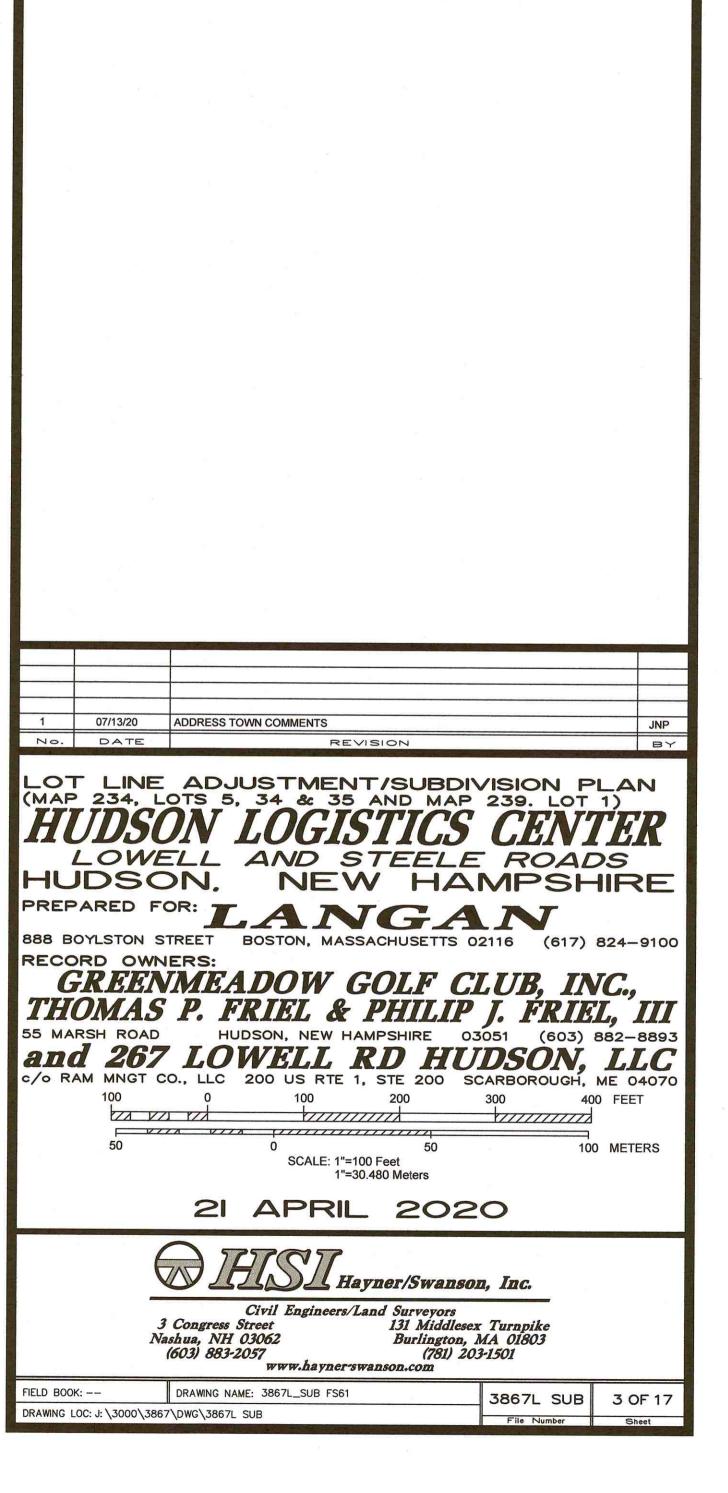
3867L SUB 2 OF 17

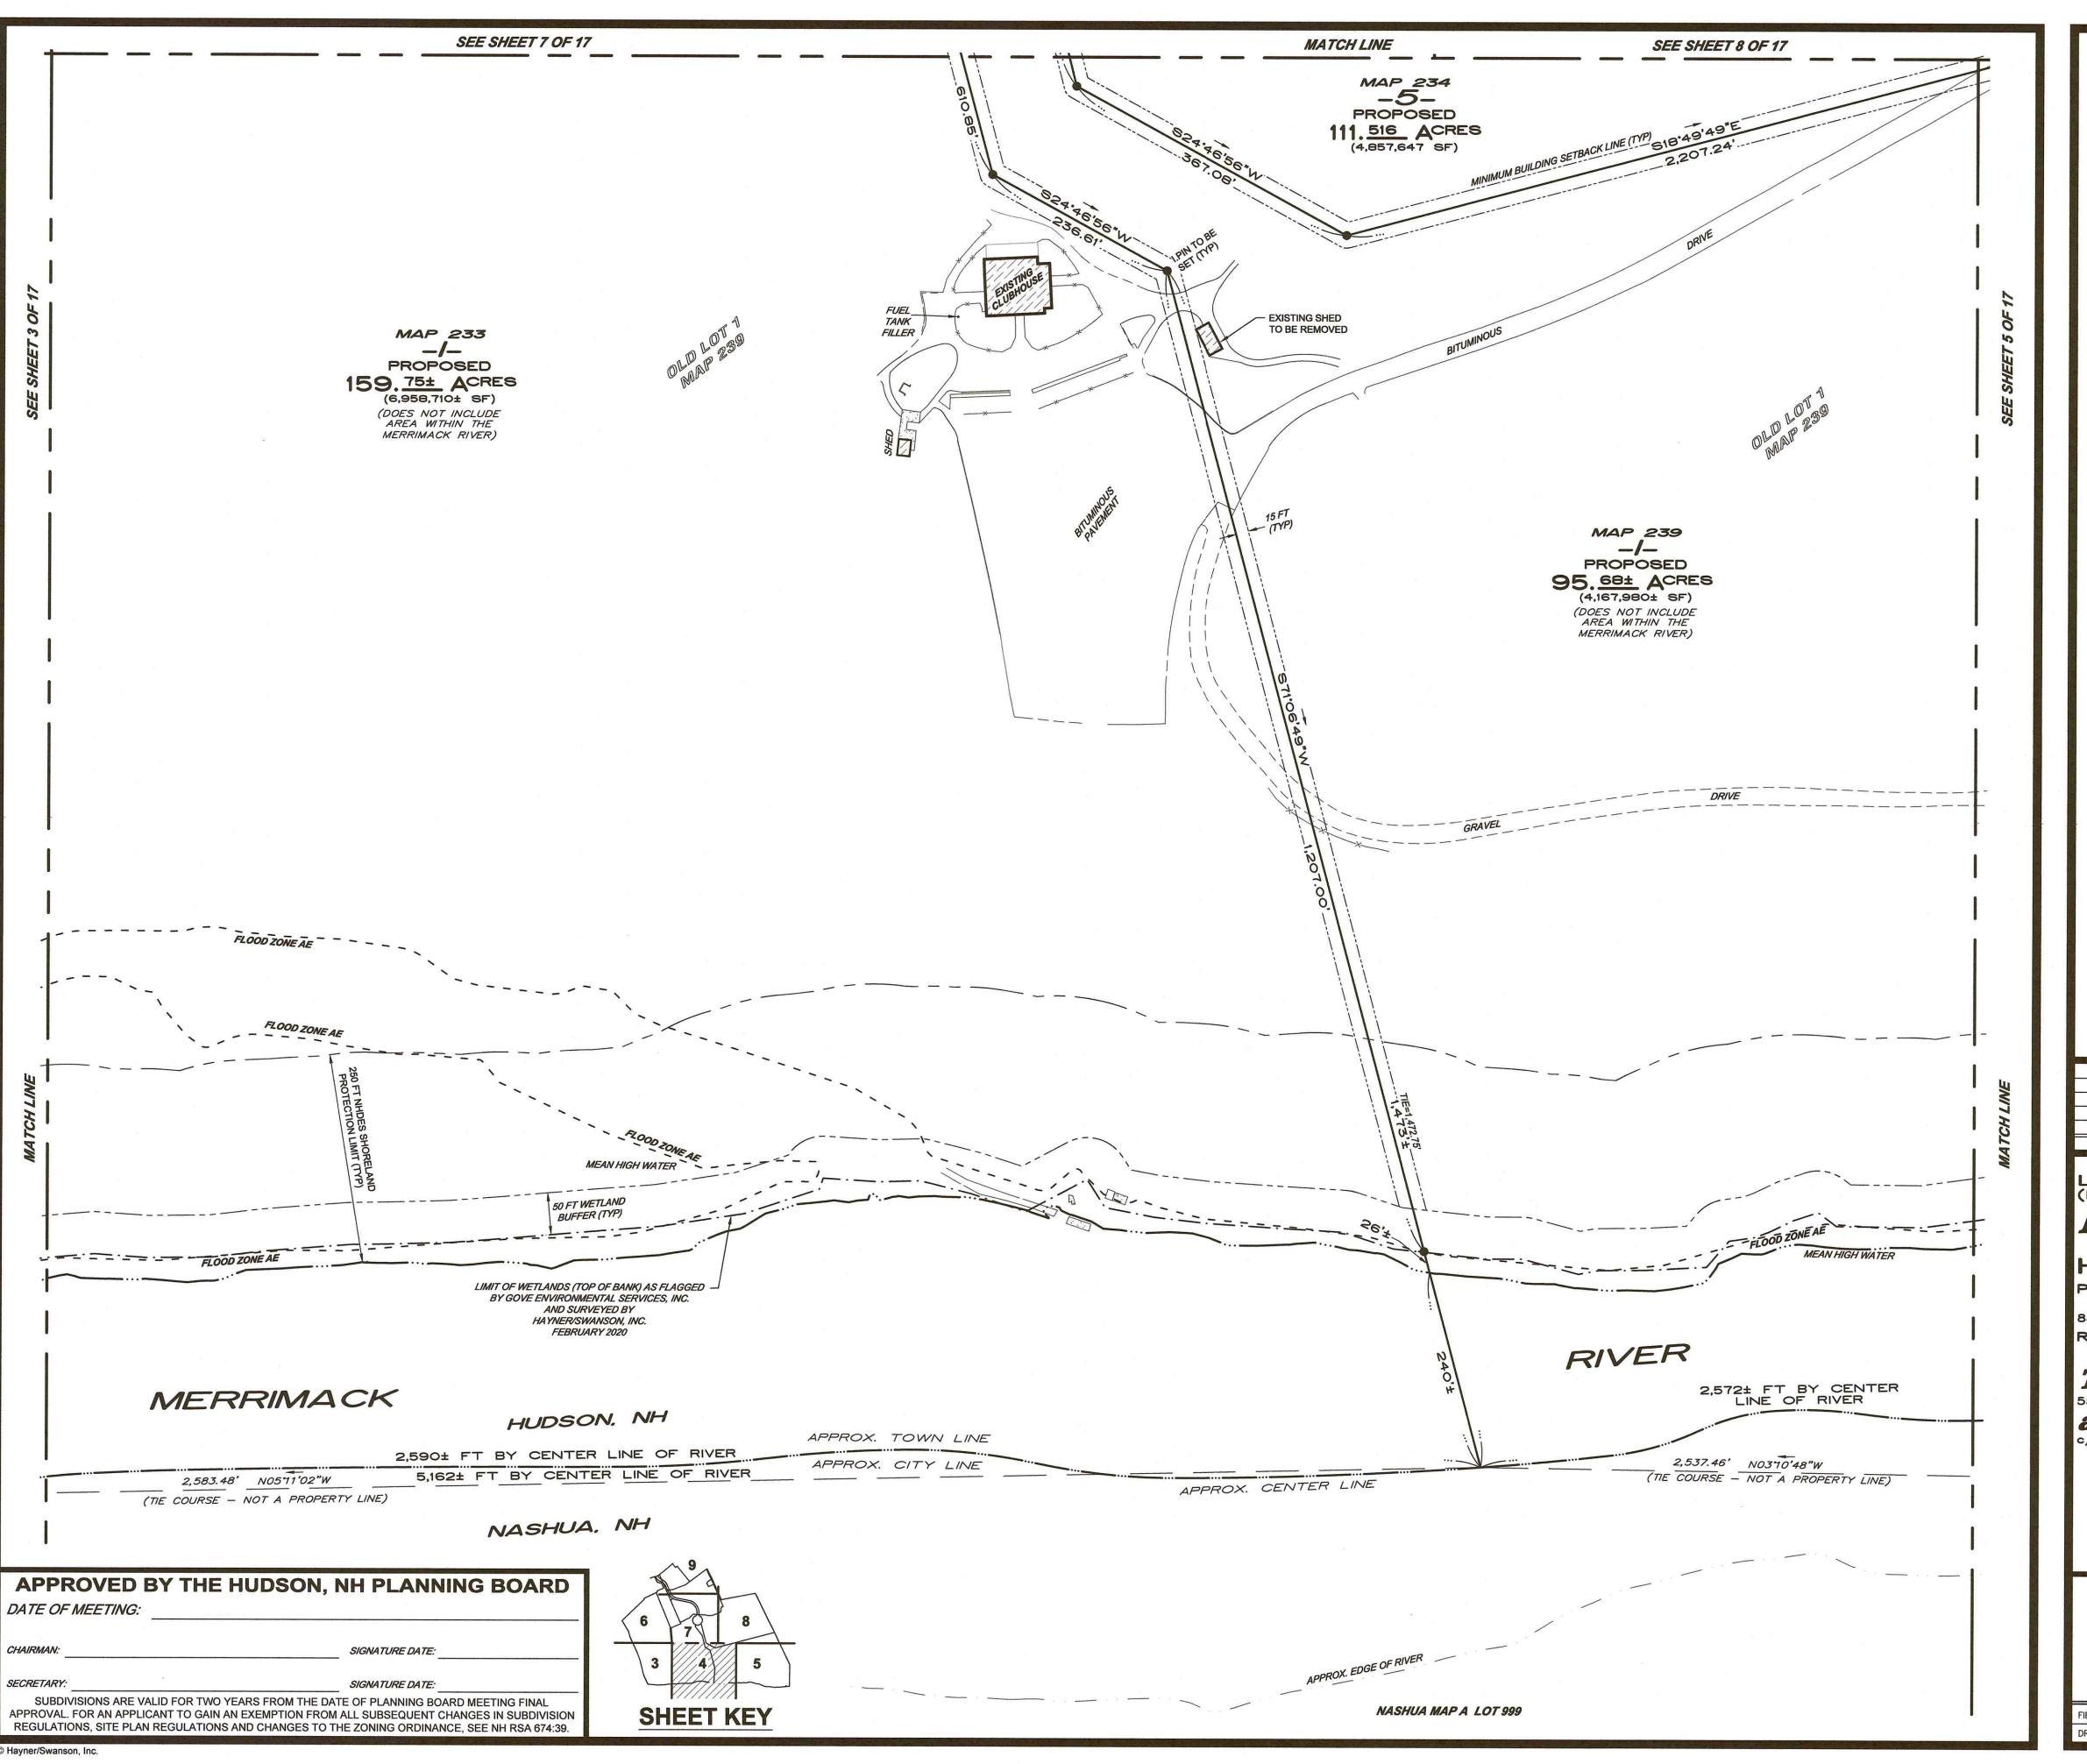
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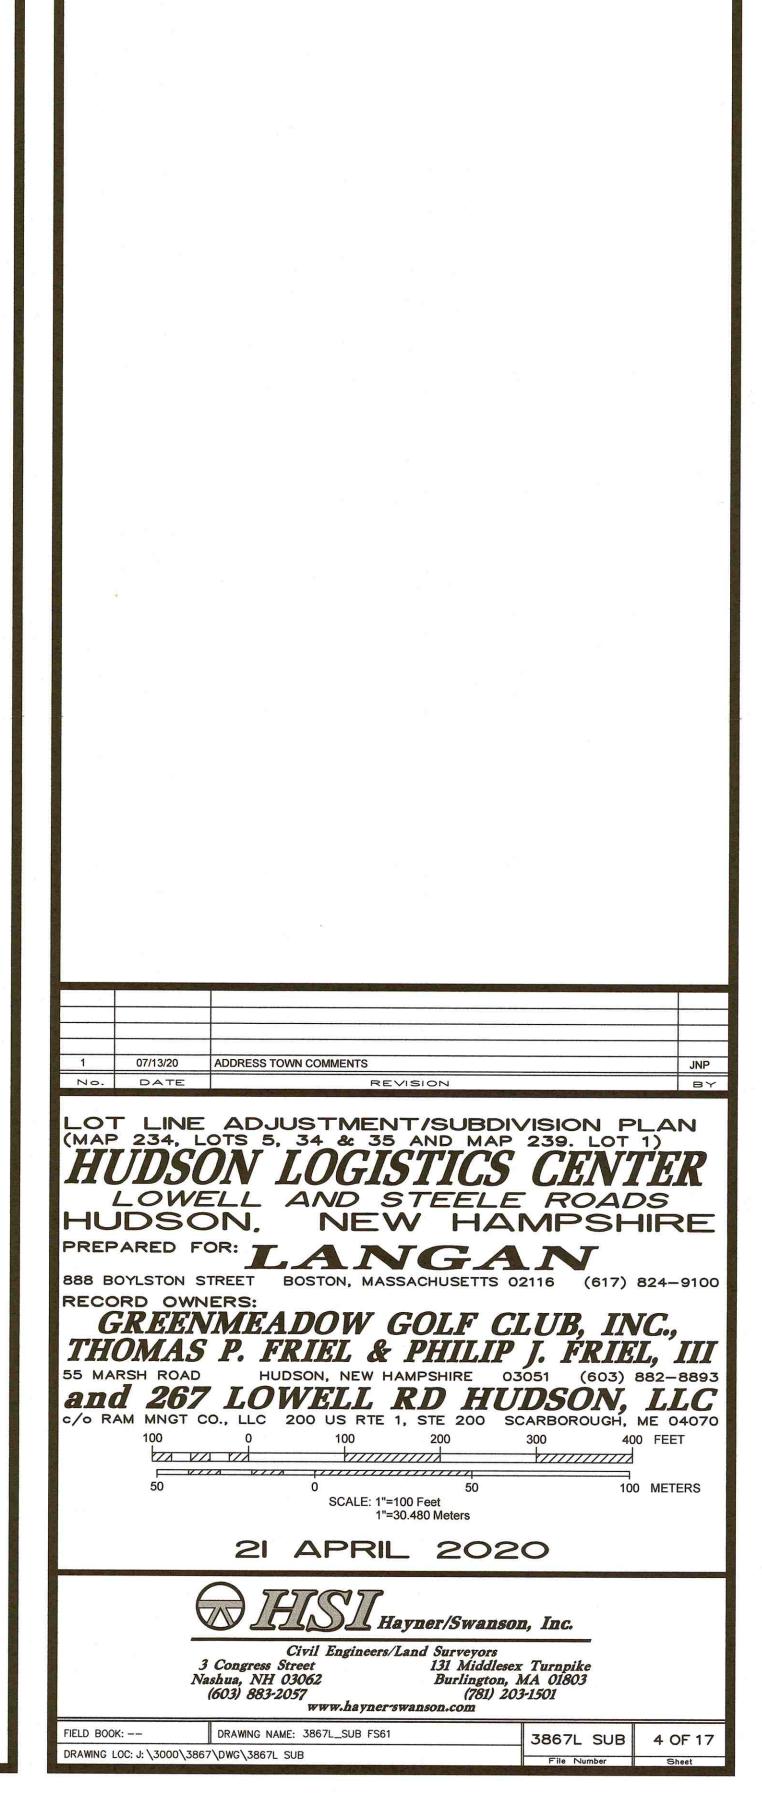
FLAGSTONE DR.

© Hayner/Swanson, Inc.



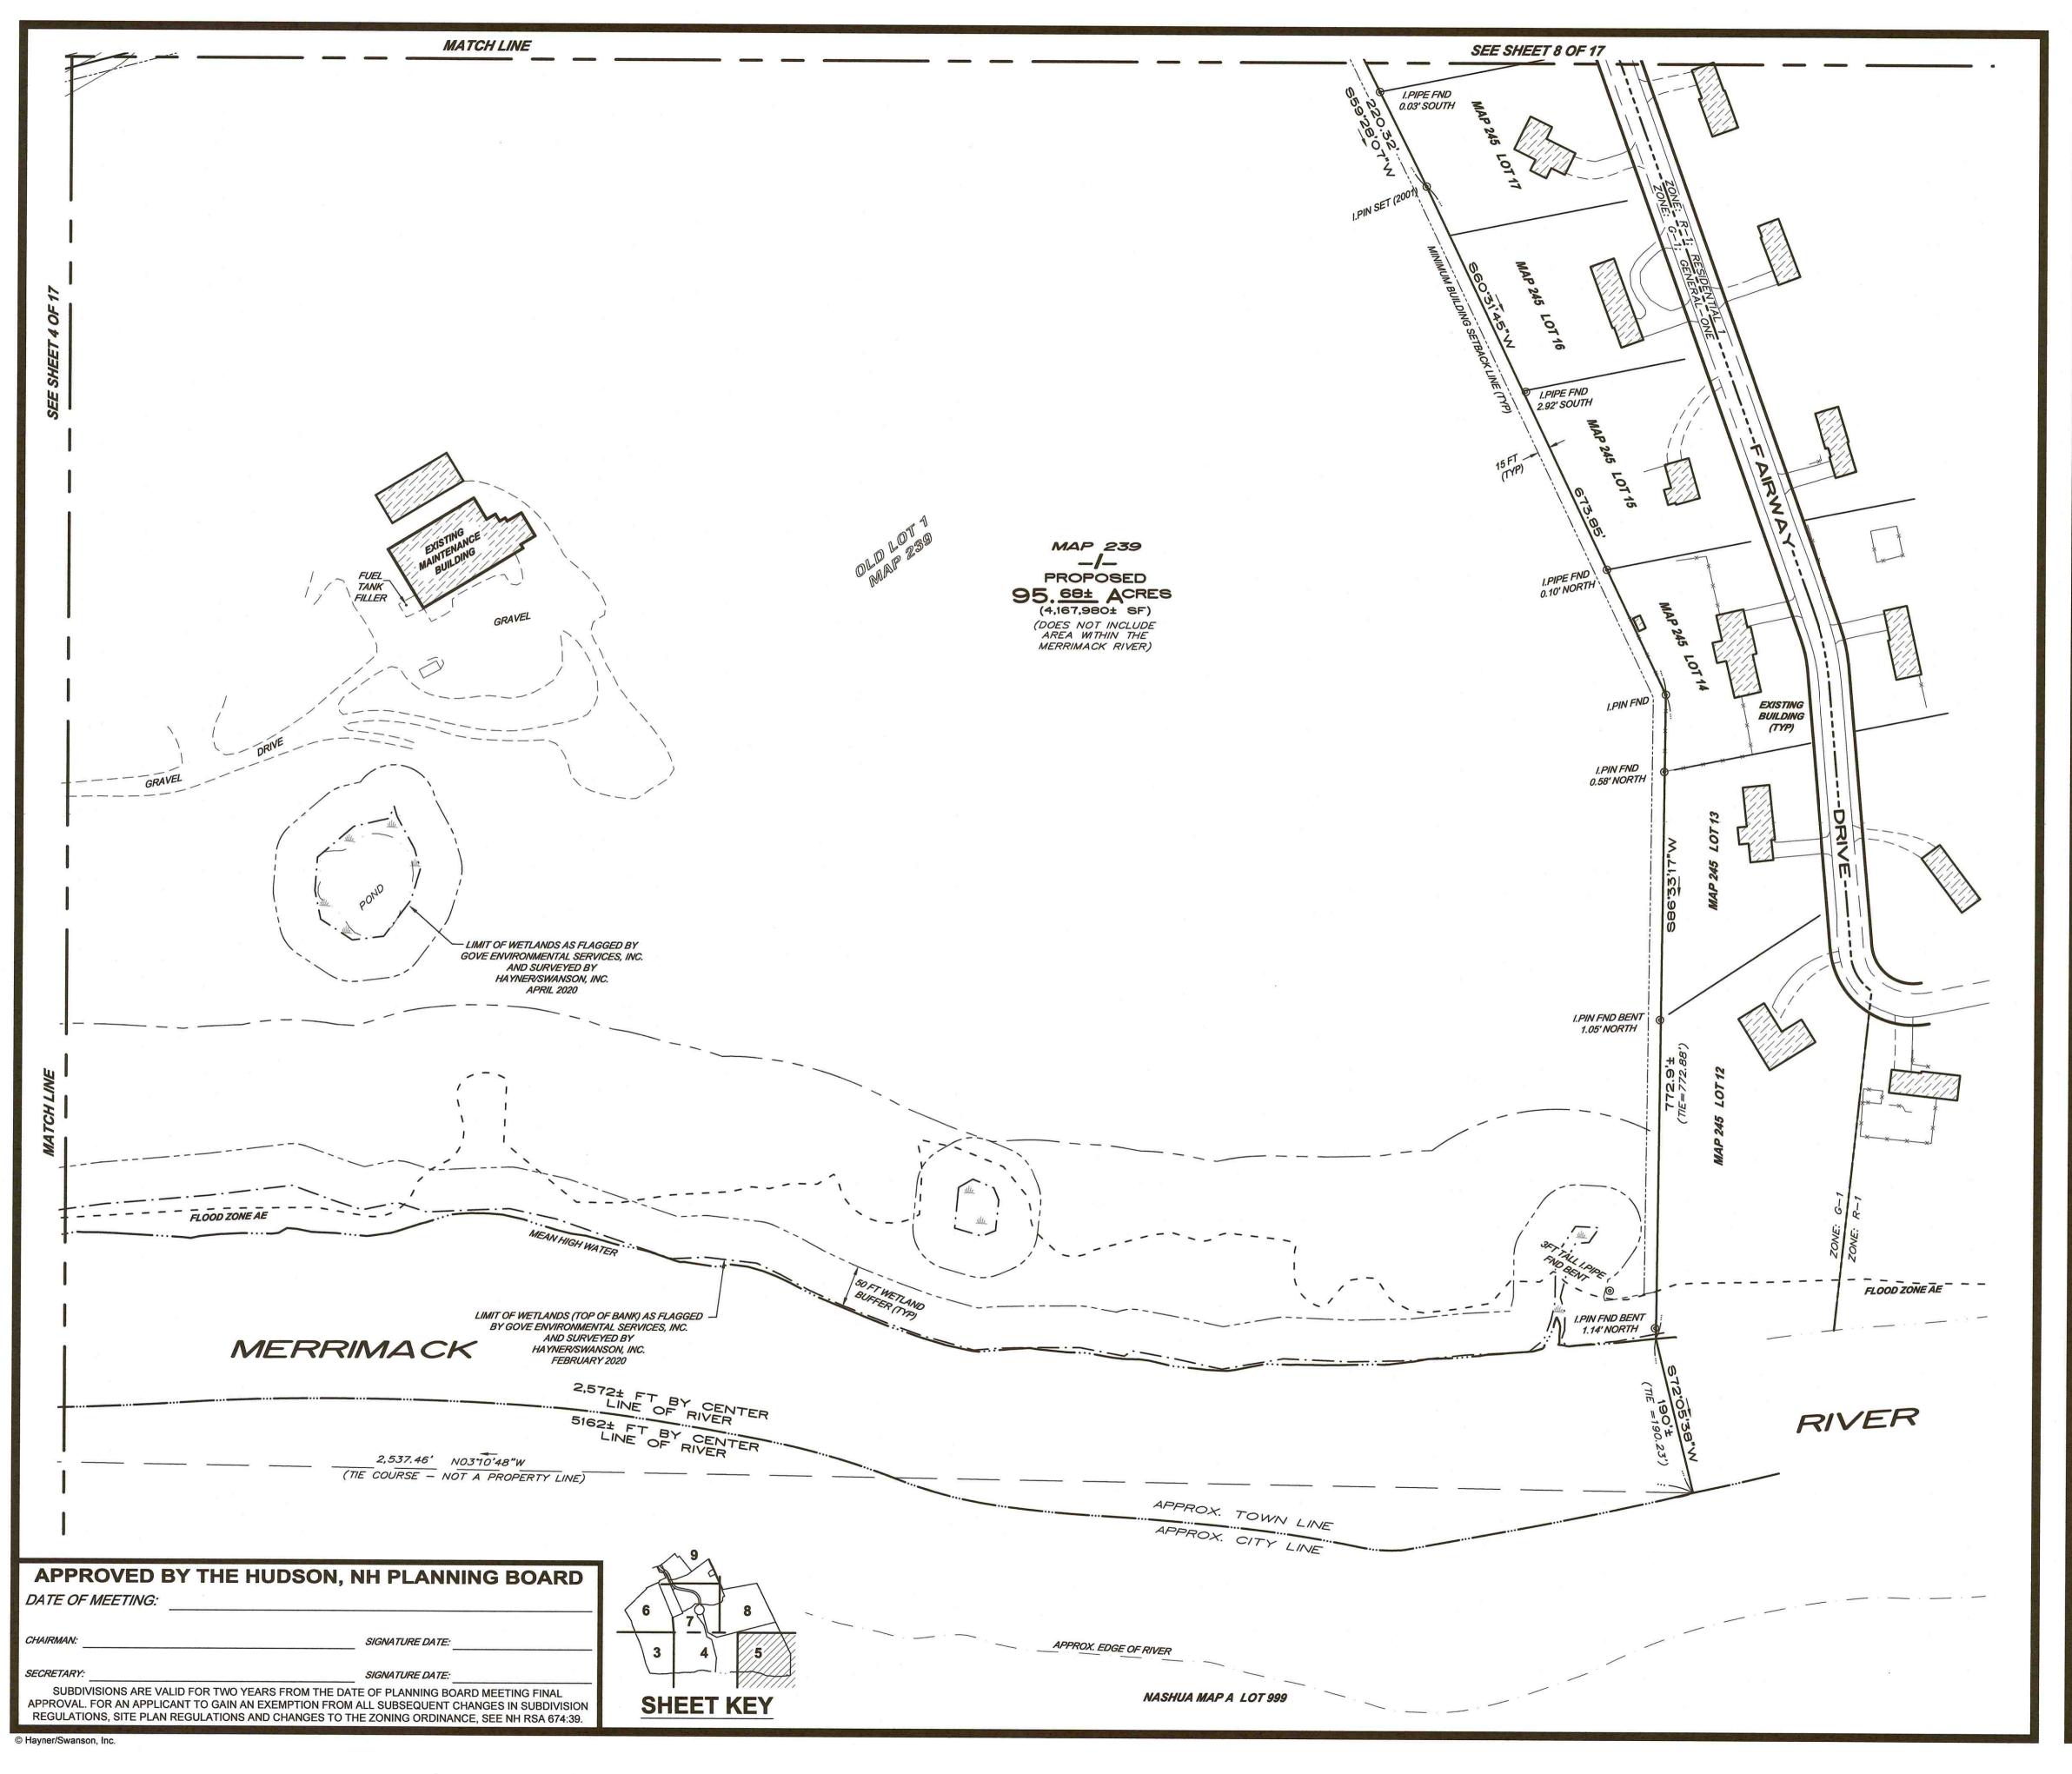


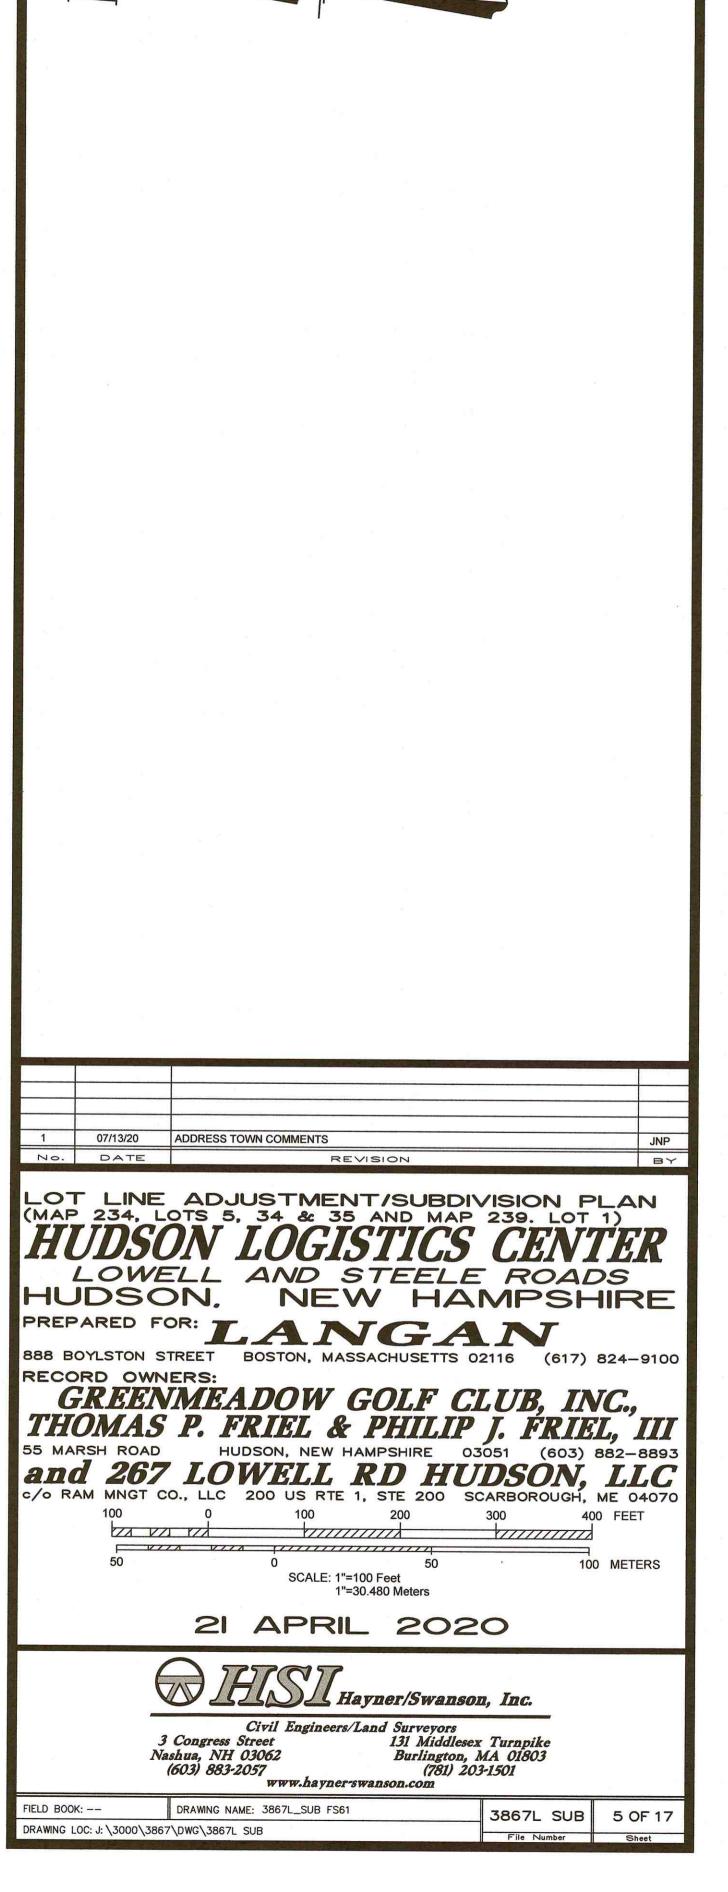





N.A.D. 1983

NH STATE PLANE








NH STATE PLANE

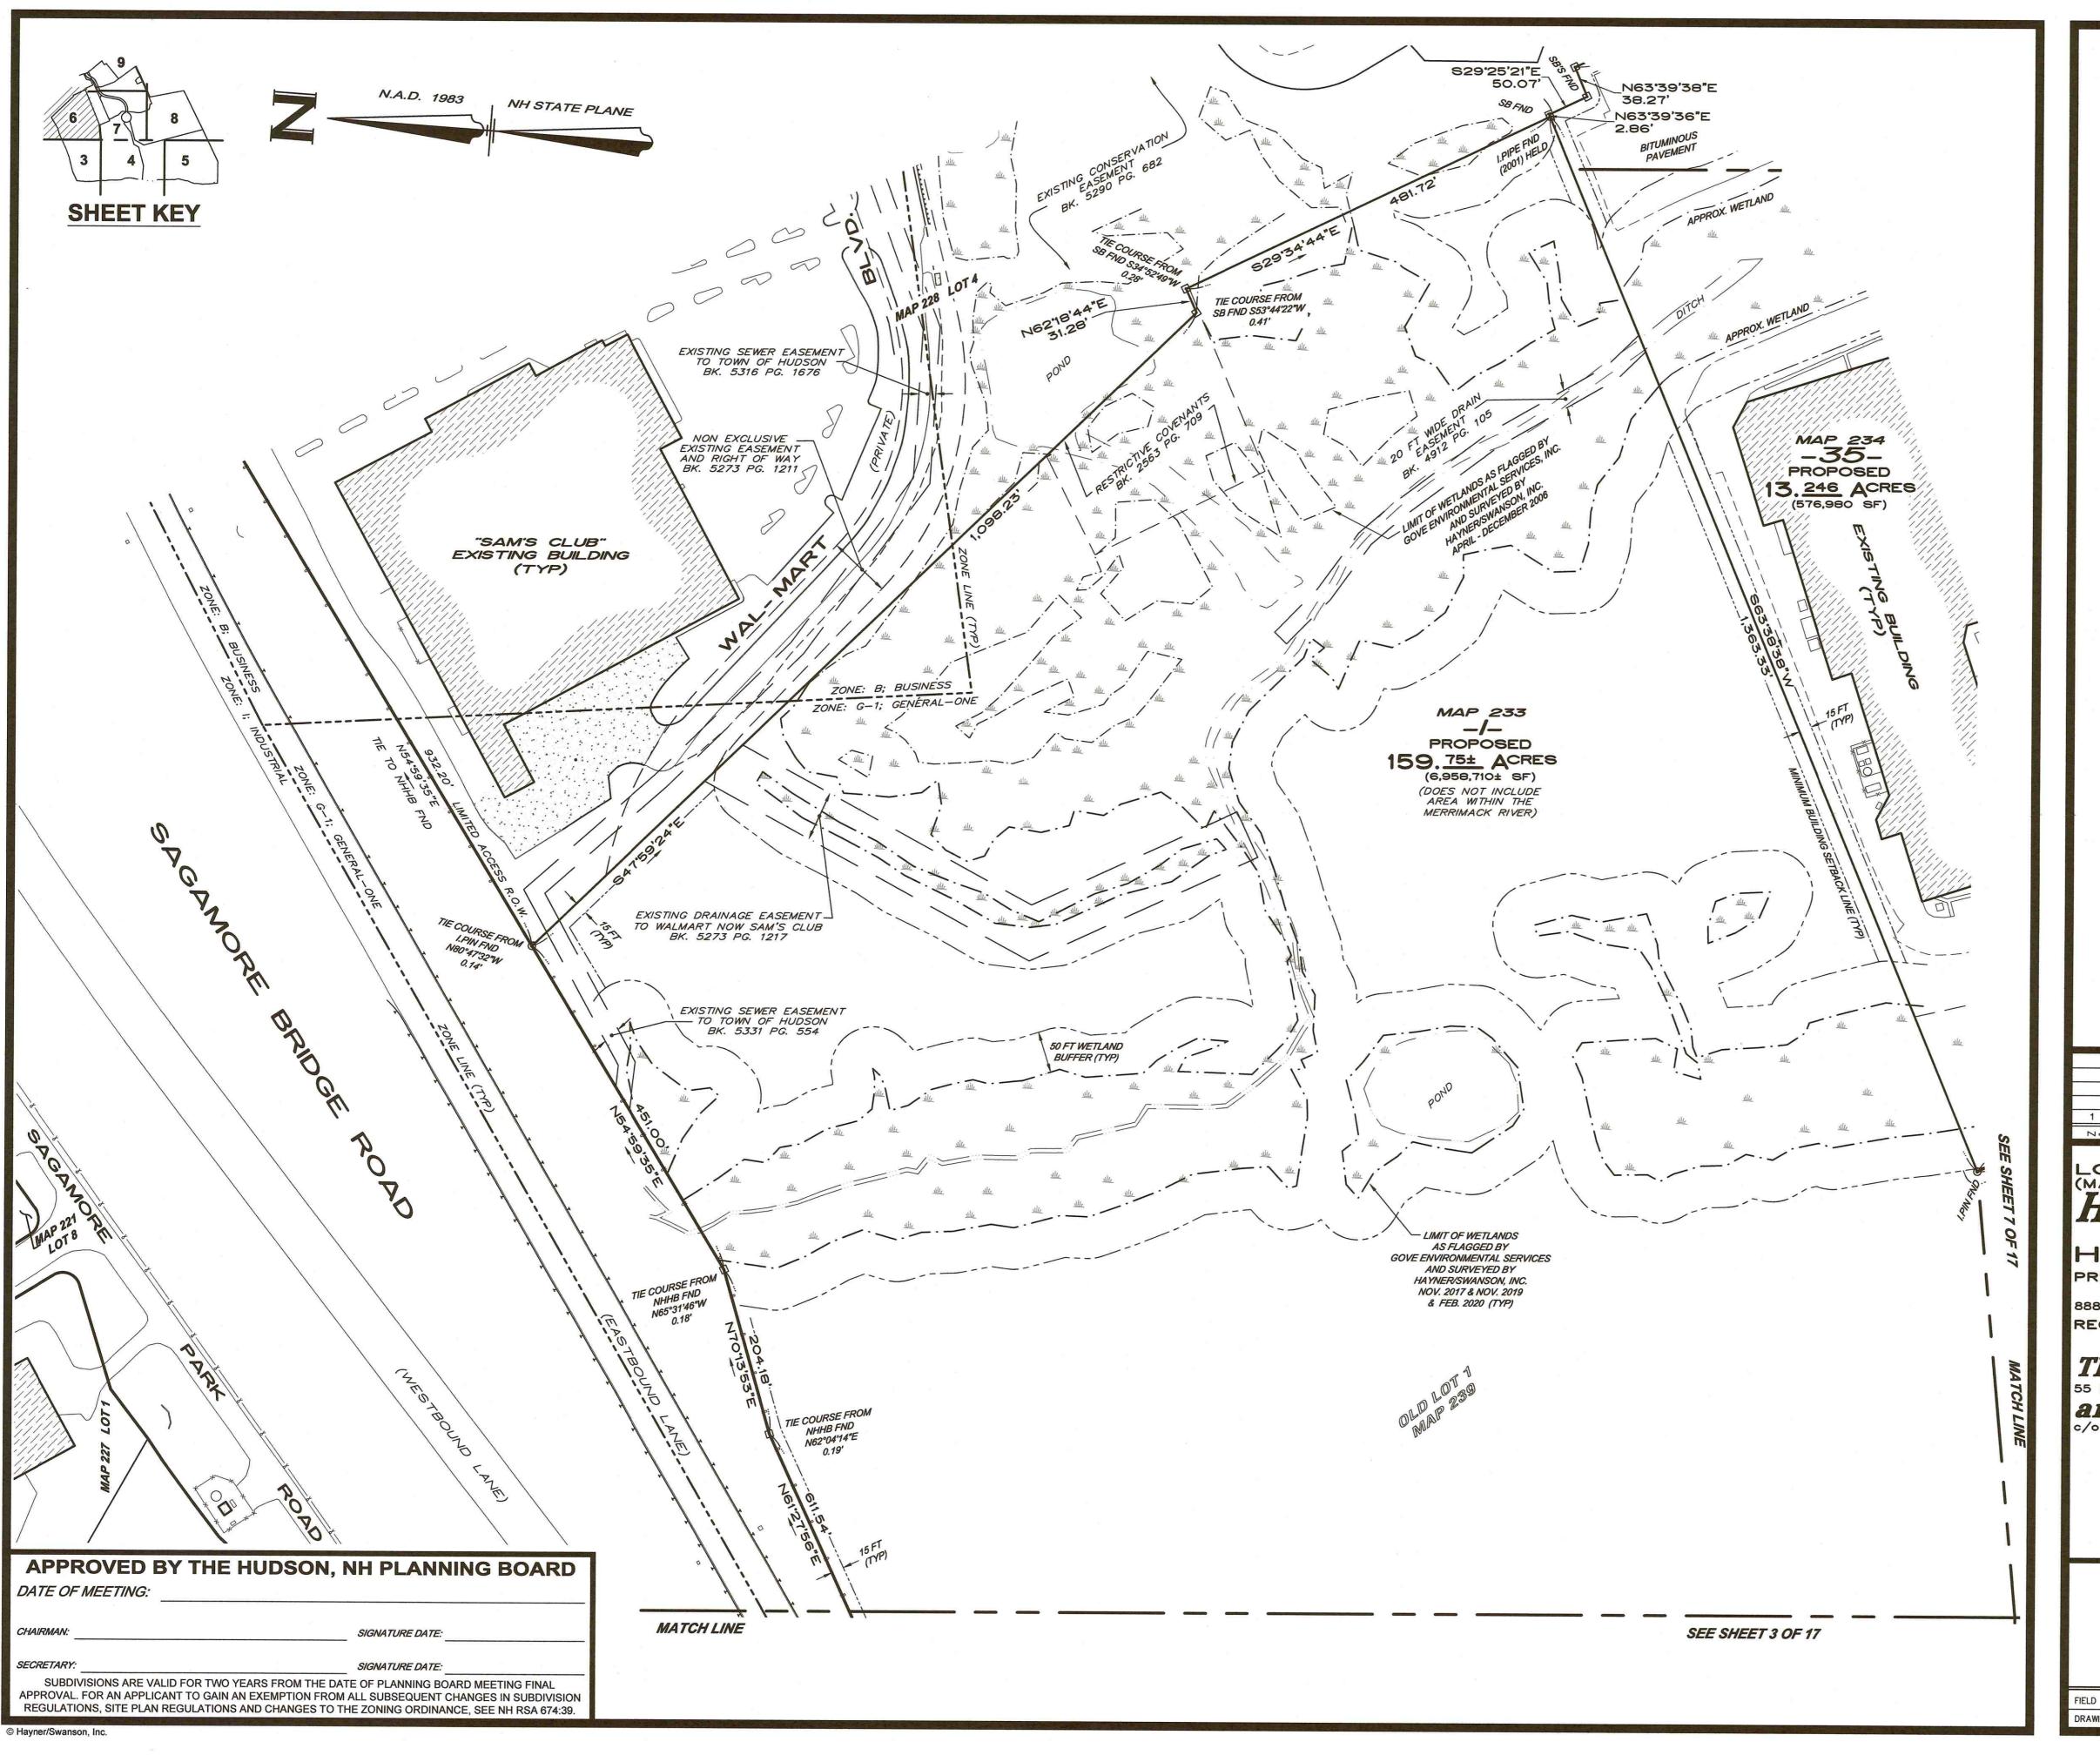

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1 No.	07/13/20 A	ADDRESS TOW		REVI	SION				NP 3 Y
HL B88 E REC	T LINE 234, LO UDSO LOWE JDSO PARED FOR BOYLSTON STORD OWNE GREEN	ADJU OTS 5. ON. OR: I. REET B ERS: MEA. HUD LOV O., LLC 2	JSTN 34 & LOC AND A SOSTON, DOV RIEL SON, NE VEL 200 US 100 100 0 SCA	MENT 35 35 SEV MASSA MASSA MASSA MASSA LE: 1"=100 1"=30.4	ACHUSET ACHUSE ACHUSET ACHUSET ACHUSET ACHUSET ACHUSET ACHUSET ACHU	SELENAN A TITS 02 CLUMN O SCA	CENTROAL ROAL ROAL MPSH 116 (617) ILB, IN ILB	**************************************	100 100 100 100 100 100 100 100 100 100
HL B88 E REC	T LINE 234, LO UDSO LOWE JDSO PARED FO BOYLSTON ST ORD OWNE GREEN OMAS ARSH ROAD AM MNGT CO 100	ADJU OTS 5. ON. OR: I. REET B ERS: MEA. HUD LOV O., LLC 2	JSTN 34 & LOC AND A SOSTON, DOV RIEL SON, NE VEL 200 US 100 100 0 SCA	MENT 35 35 SEV MASSA MASSA MASSA MASSA LE: 1"=100 1"=30.4	TEE TEE TEE TEE TEE TEE TEE TEE TEE TEE	SELENAN A TITS 02 CLUMN O SCA	CENTROAL ROAL ROAL MPSH 116 (617) ILB, IN ILB	824-91 VC., EL, II 882-88 LL ME 040	100 100 100 100 100 100 100 100 100 100
MAR HUPRER 888 E RECO	T LINE 234, LO UDSO LOWE JDSO PARED FO BOYLSTON ST ORD OWNE GREEN OMAS ARSH ROAD AM MNGT CO 100	ADJL ON. OR: I. REET B ERS: MEA. HUD LOV O., LLC 2	JSTN 34 & LOCAND AND OSTON, DOV RIEL SON, NE VEL, SOO US 100 SCA	MENTS SISSIPPORT MASS MASS MASS MASS MASS MASS MASS MAS	ACHUSET ACHUSE ACHUSET ACHUSET ACHUSET ACHUSET ACHUSET ACHUSET ACHU	TE O2 TE O2 TE O2 TE O3 TE O4 TE O3 TE O3 TE O4 TE	CENTAROAL ROAL NPSHING (617) ILLE (617) ILLE (617) ILLE (603) DSON, ARBOROUGH, 10	824-91 VC., EL, II 882-88 LL ME 040	100 100 100 100 100 100 100 100 100 100
MAR HUPRER 888 E RECO	T LINE 234, LO UDSO LOWE JDSO SOYLSTON STOORD OWNE GREEN OMAS ARSH ROAD AM MNGT CO 100 27 50 3 Nass	ADJL ON. OR: I. REET B ERS: MEA. HUD LOV O., LLC 2	JSTN 34 & LOCAND AND OSTON, DOV RIEL SON, NE VEL, 200 US 100 100 100 100 100 100 100 100 100 10	MENT 35 7/S EV MASSA W G W HAN L R EW HAN LE: 1"=100 1"=30.4	ACHUSET ACHUSE ACHUSET ACHUSET ACHUSET ACHUSET ACHUSET ACHUSET ACHU	TE O2 TE	CENTAROAL ROAL ROAL ROAL ROAL ROAL ROAL ROAL	824-91 VC., EL, II 882-88 LL ME 040	100 100 100 100 100 100 100 100 100 100

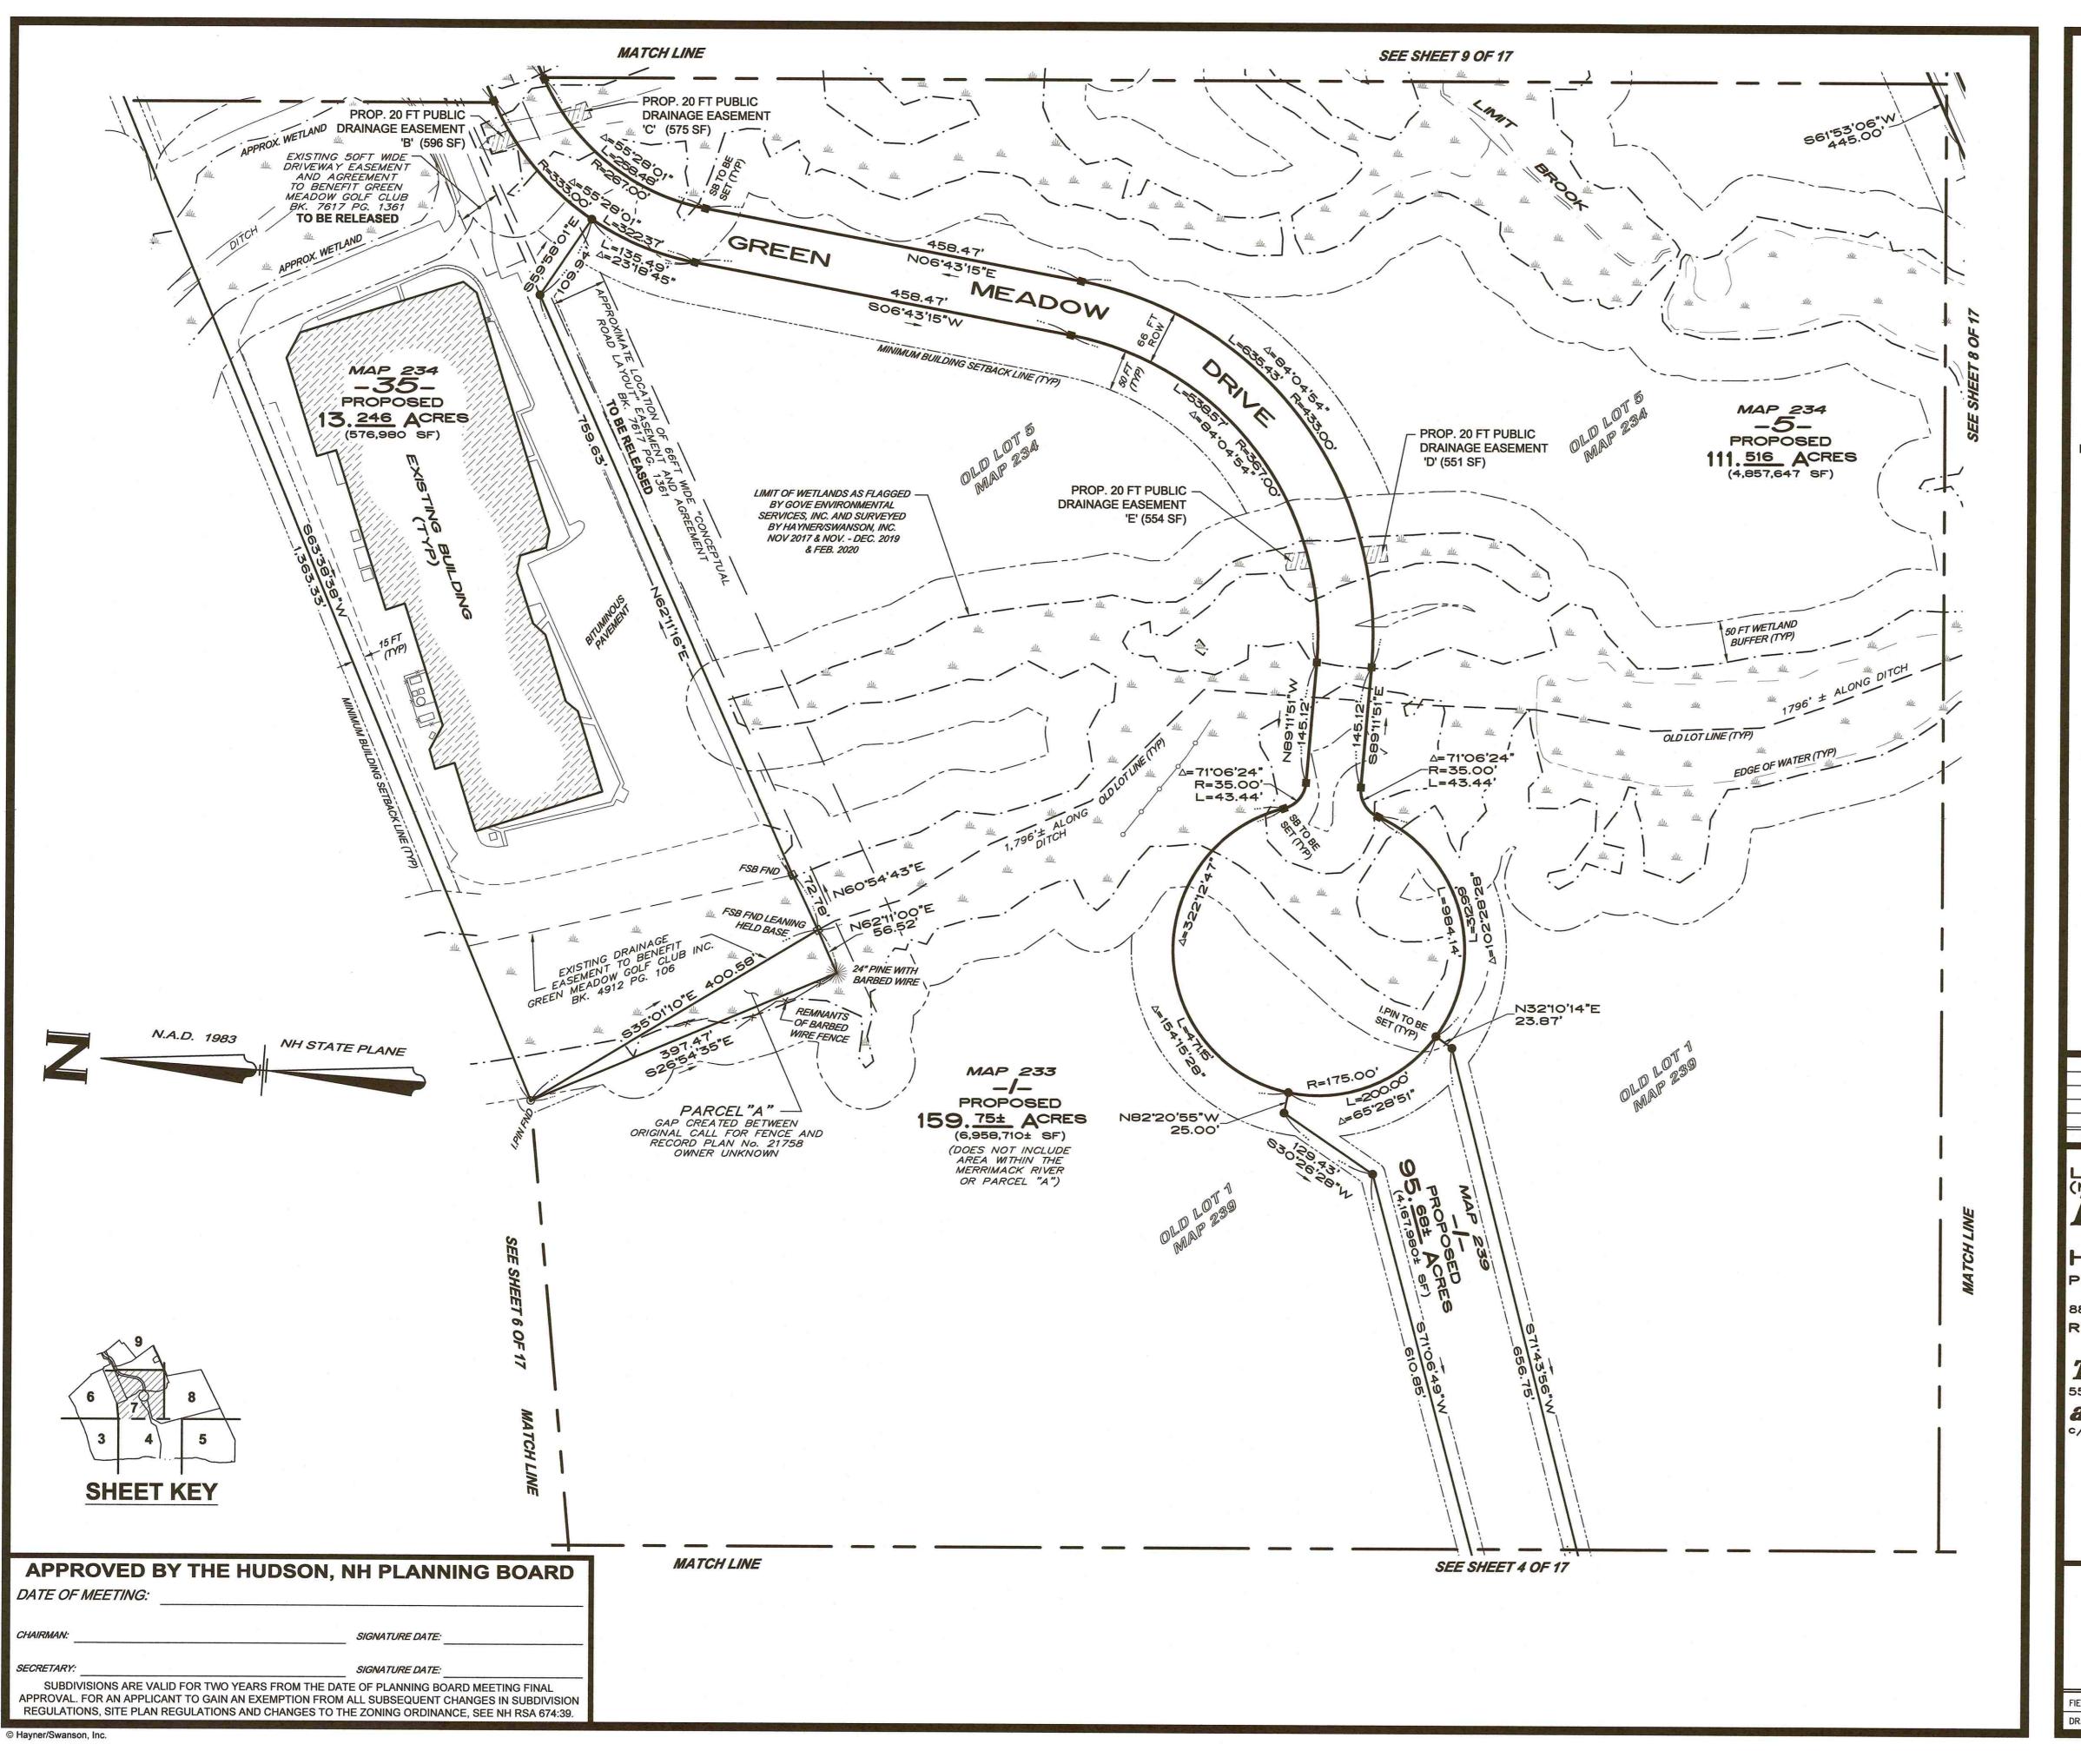

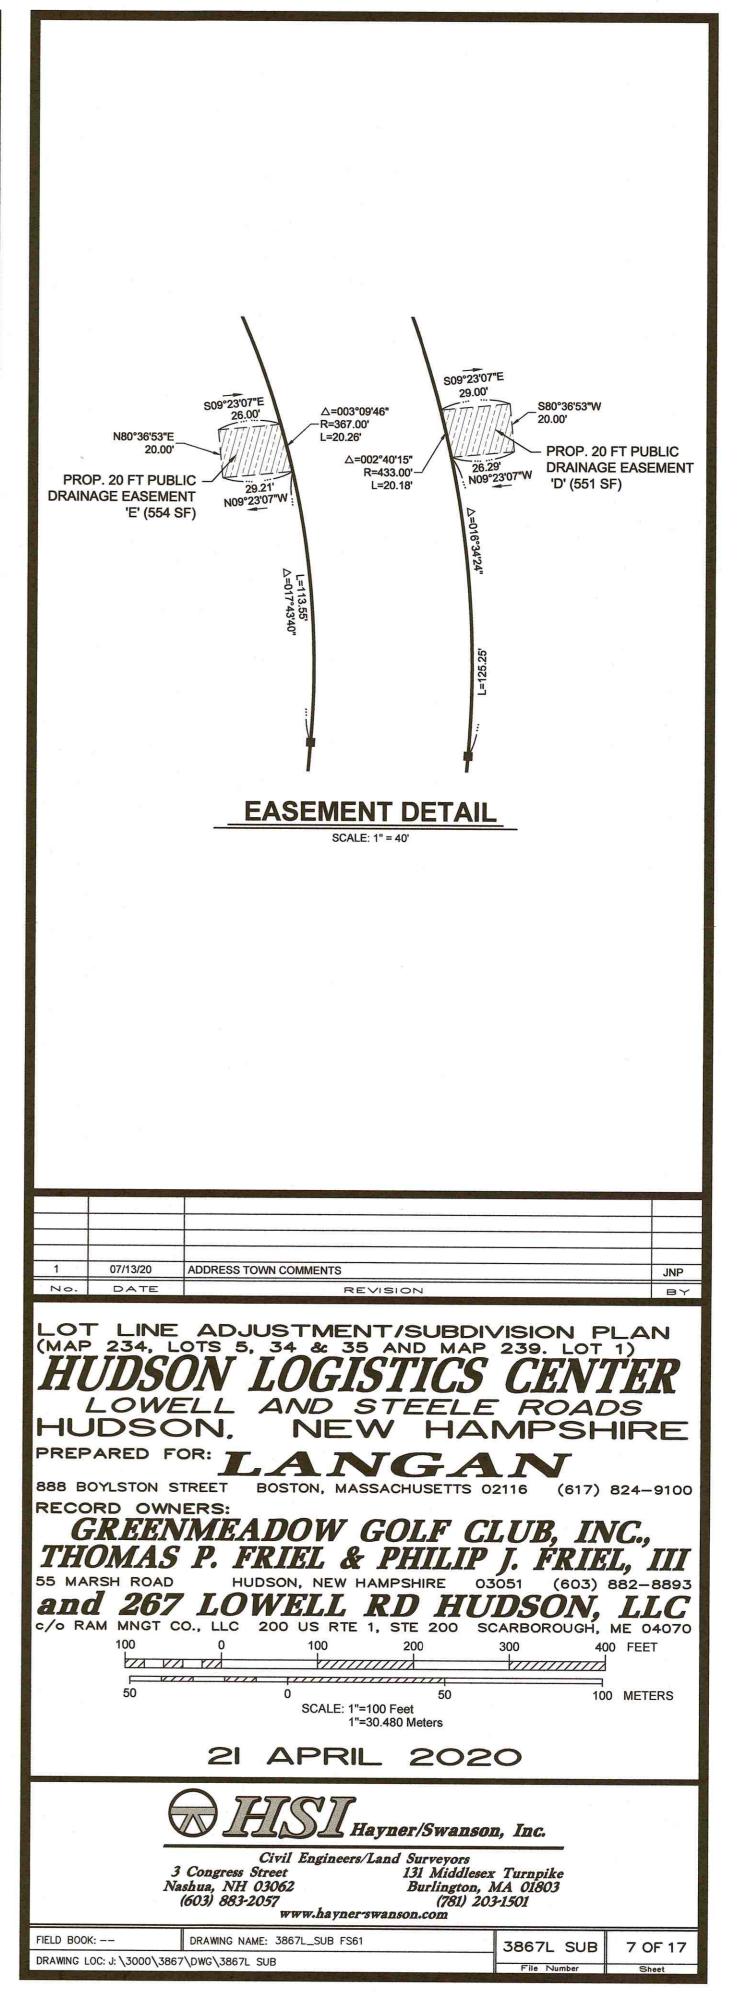

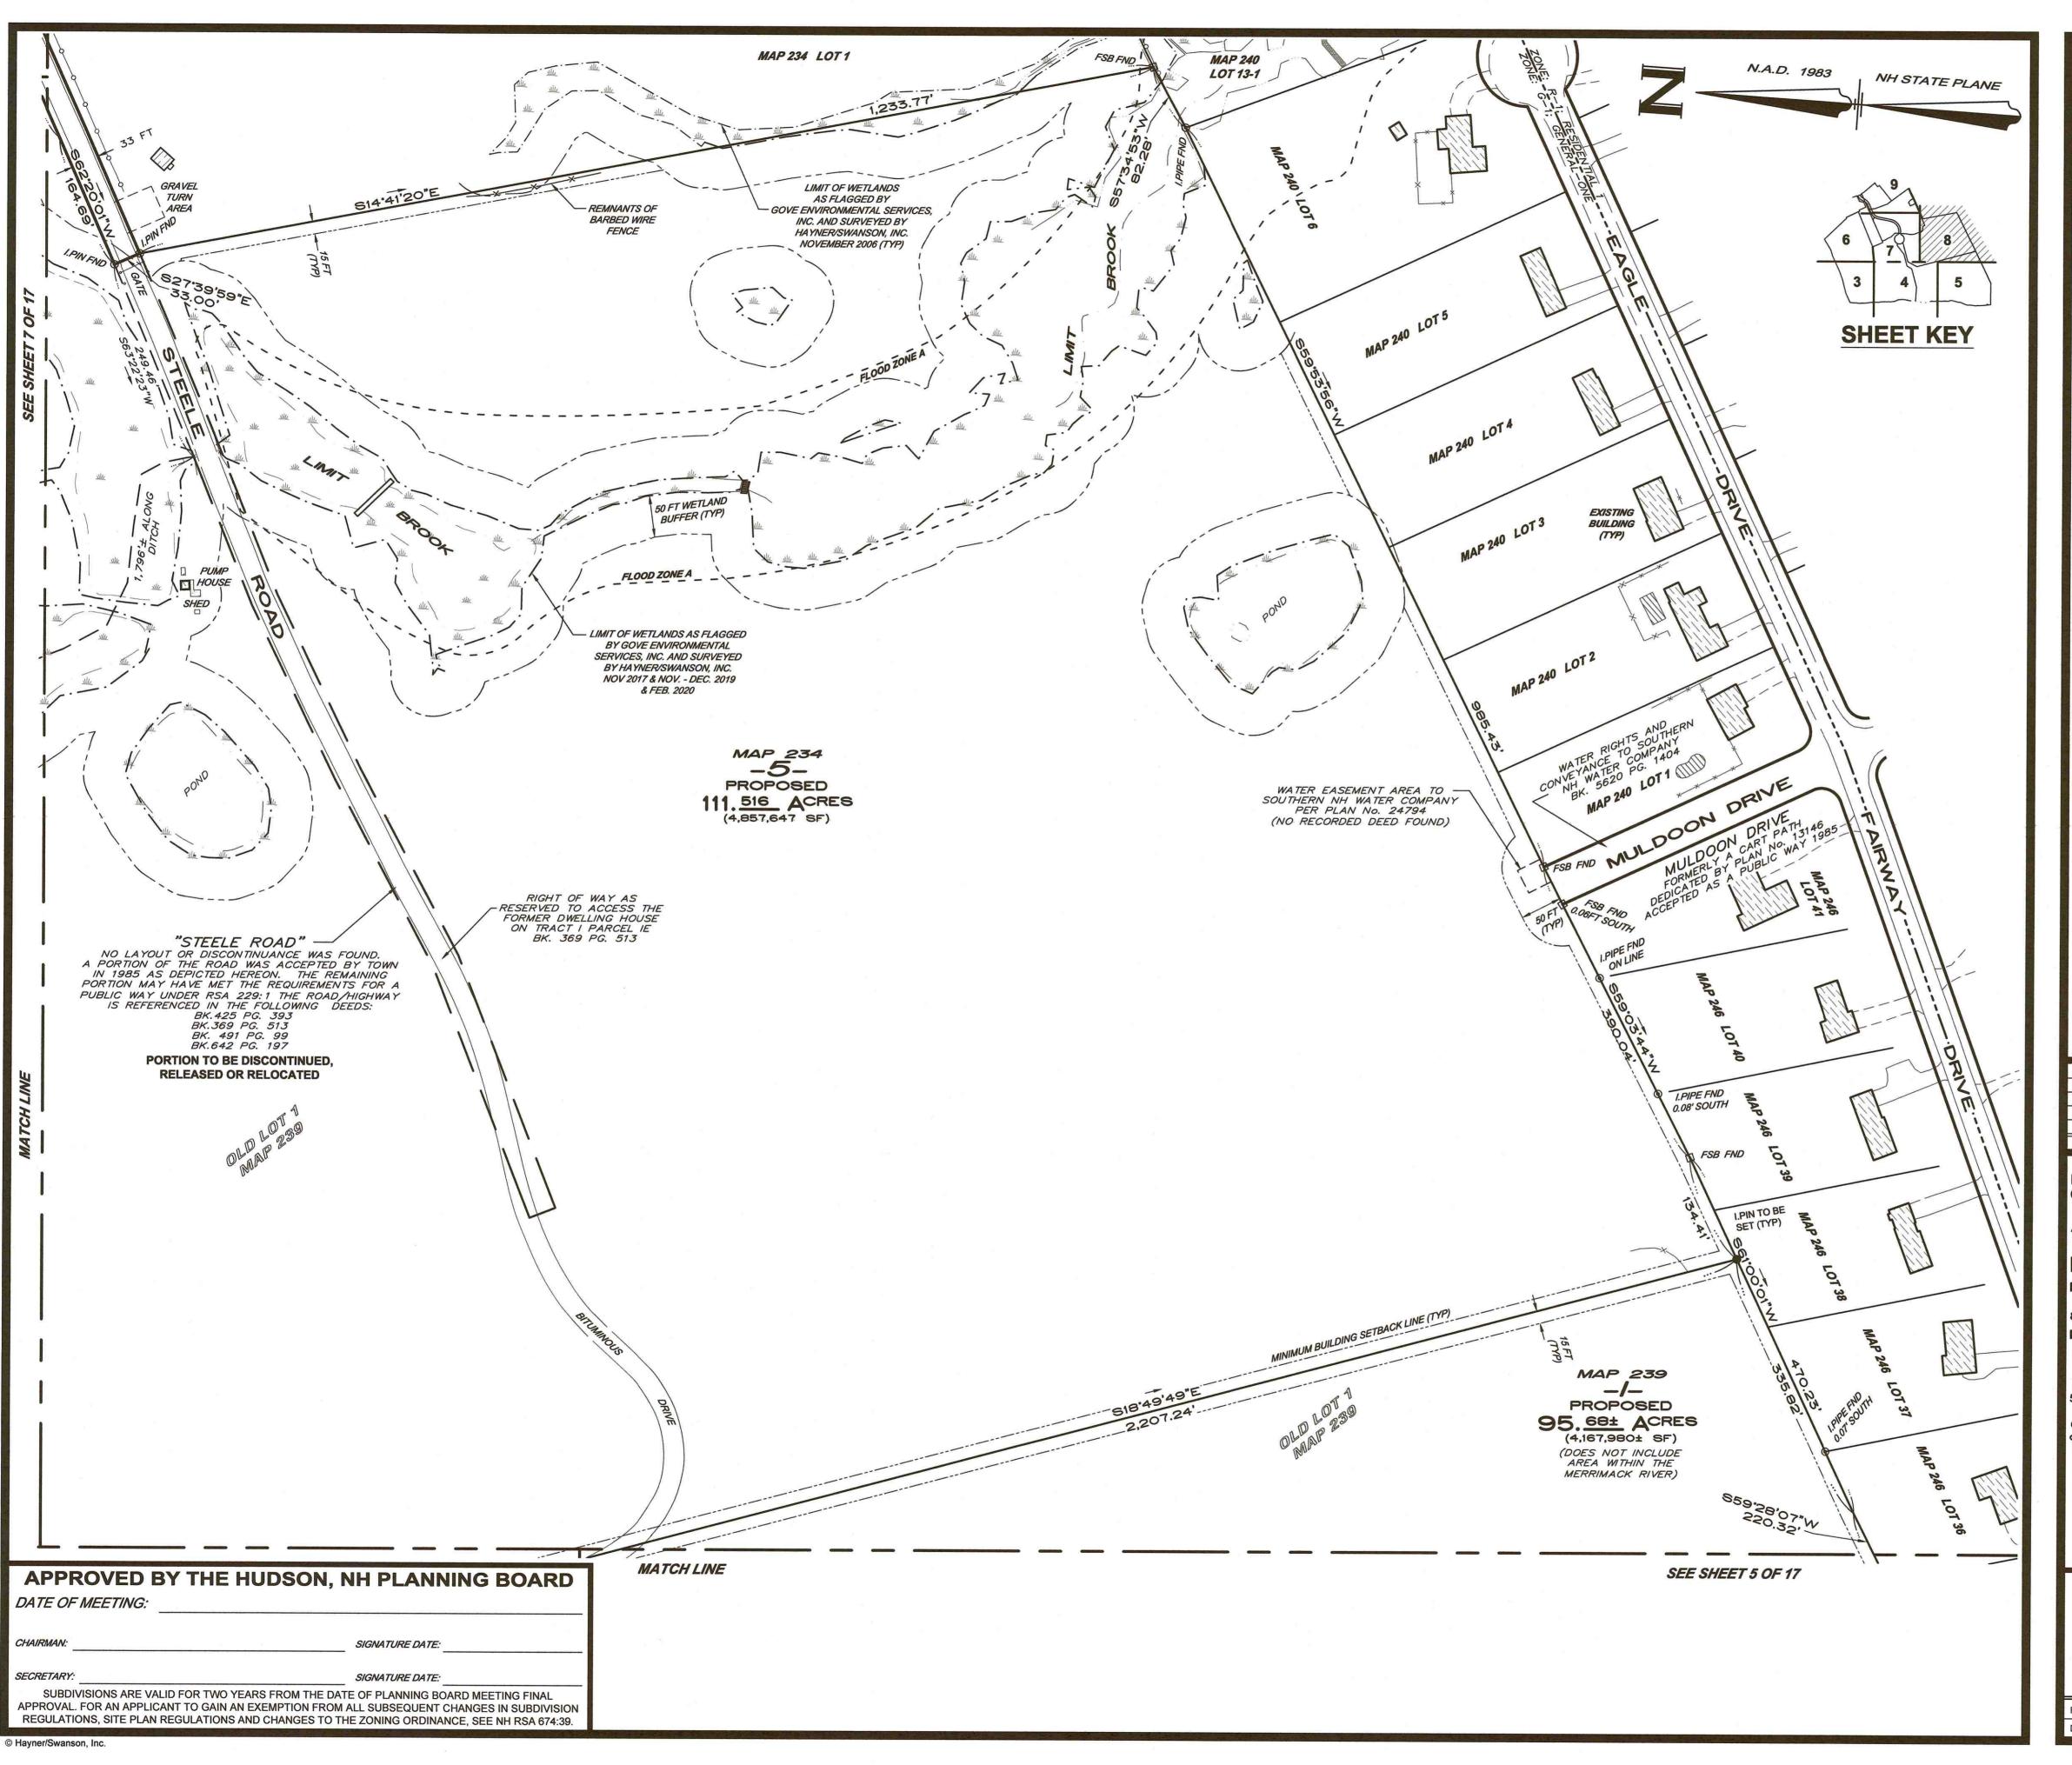

07/13/20 ADDRESS TOWN COMMENTS No. DATE REVISION LOT LINE ADJUSTMENT/SUBDIVISION PLAN (MAP 234, LOTS 5, 34 & 35 AND MAP 239, LOT 1)

HUDSON LOGISTICS CENTER

LOWELL AND STEELE ROADS

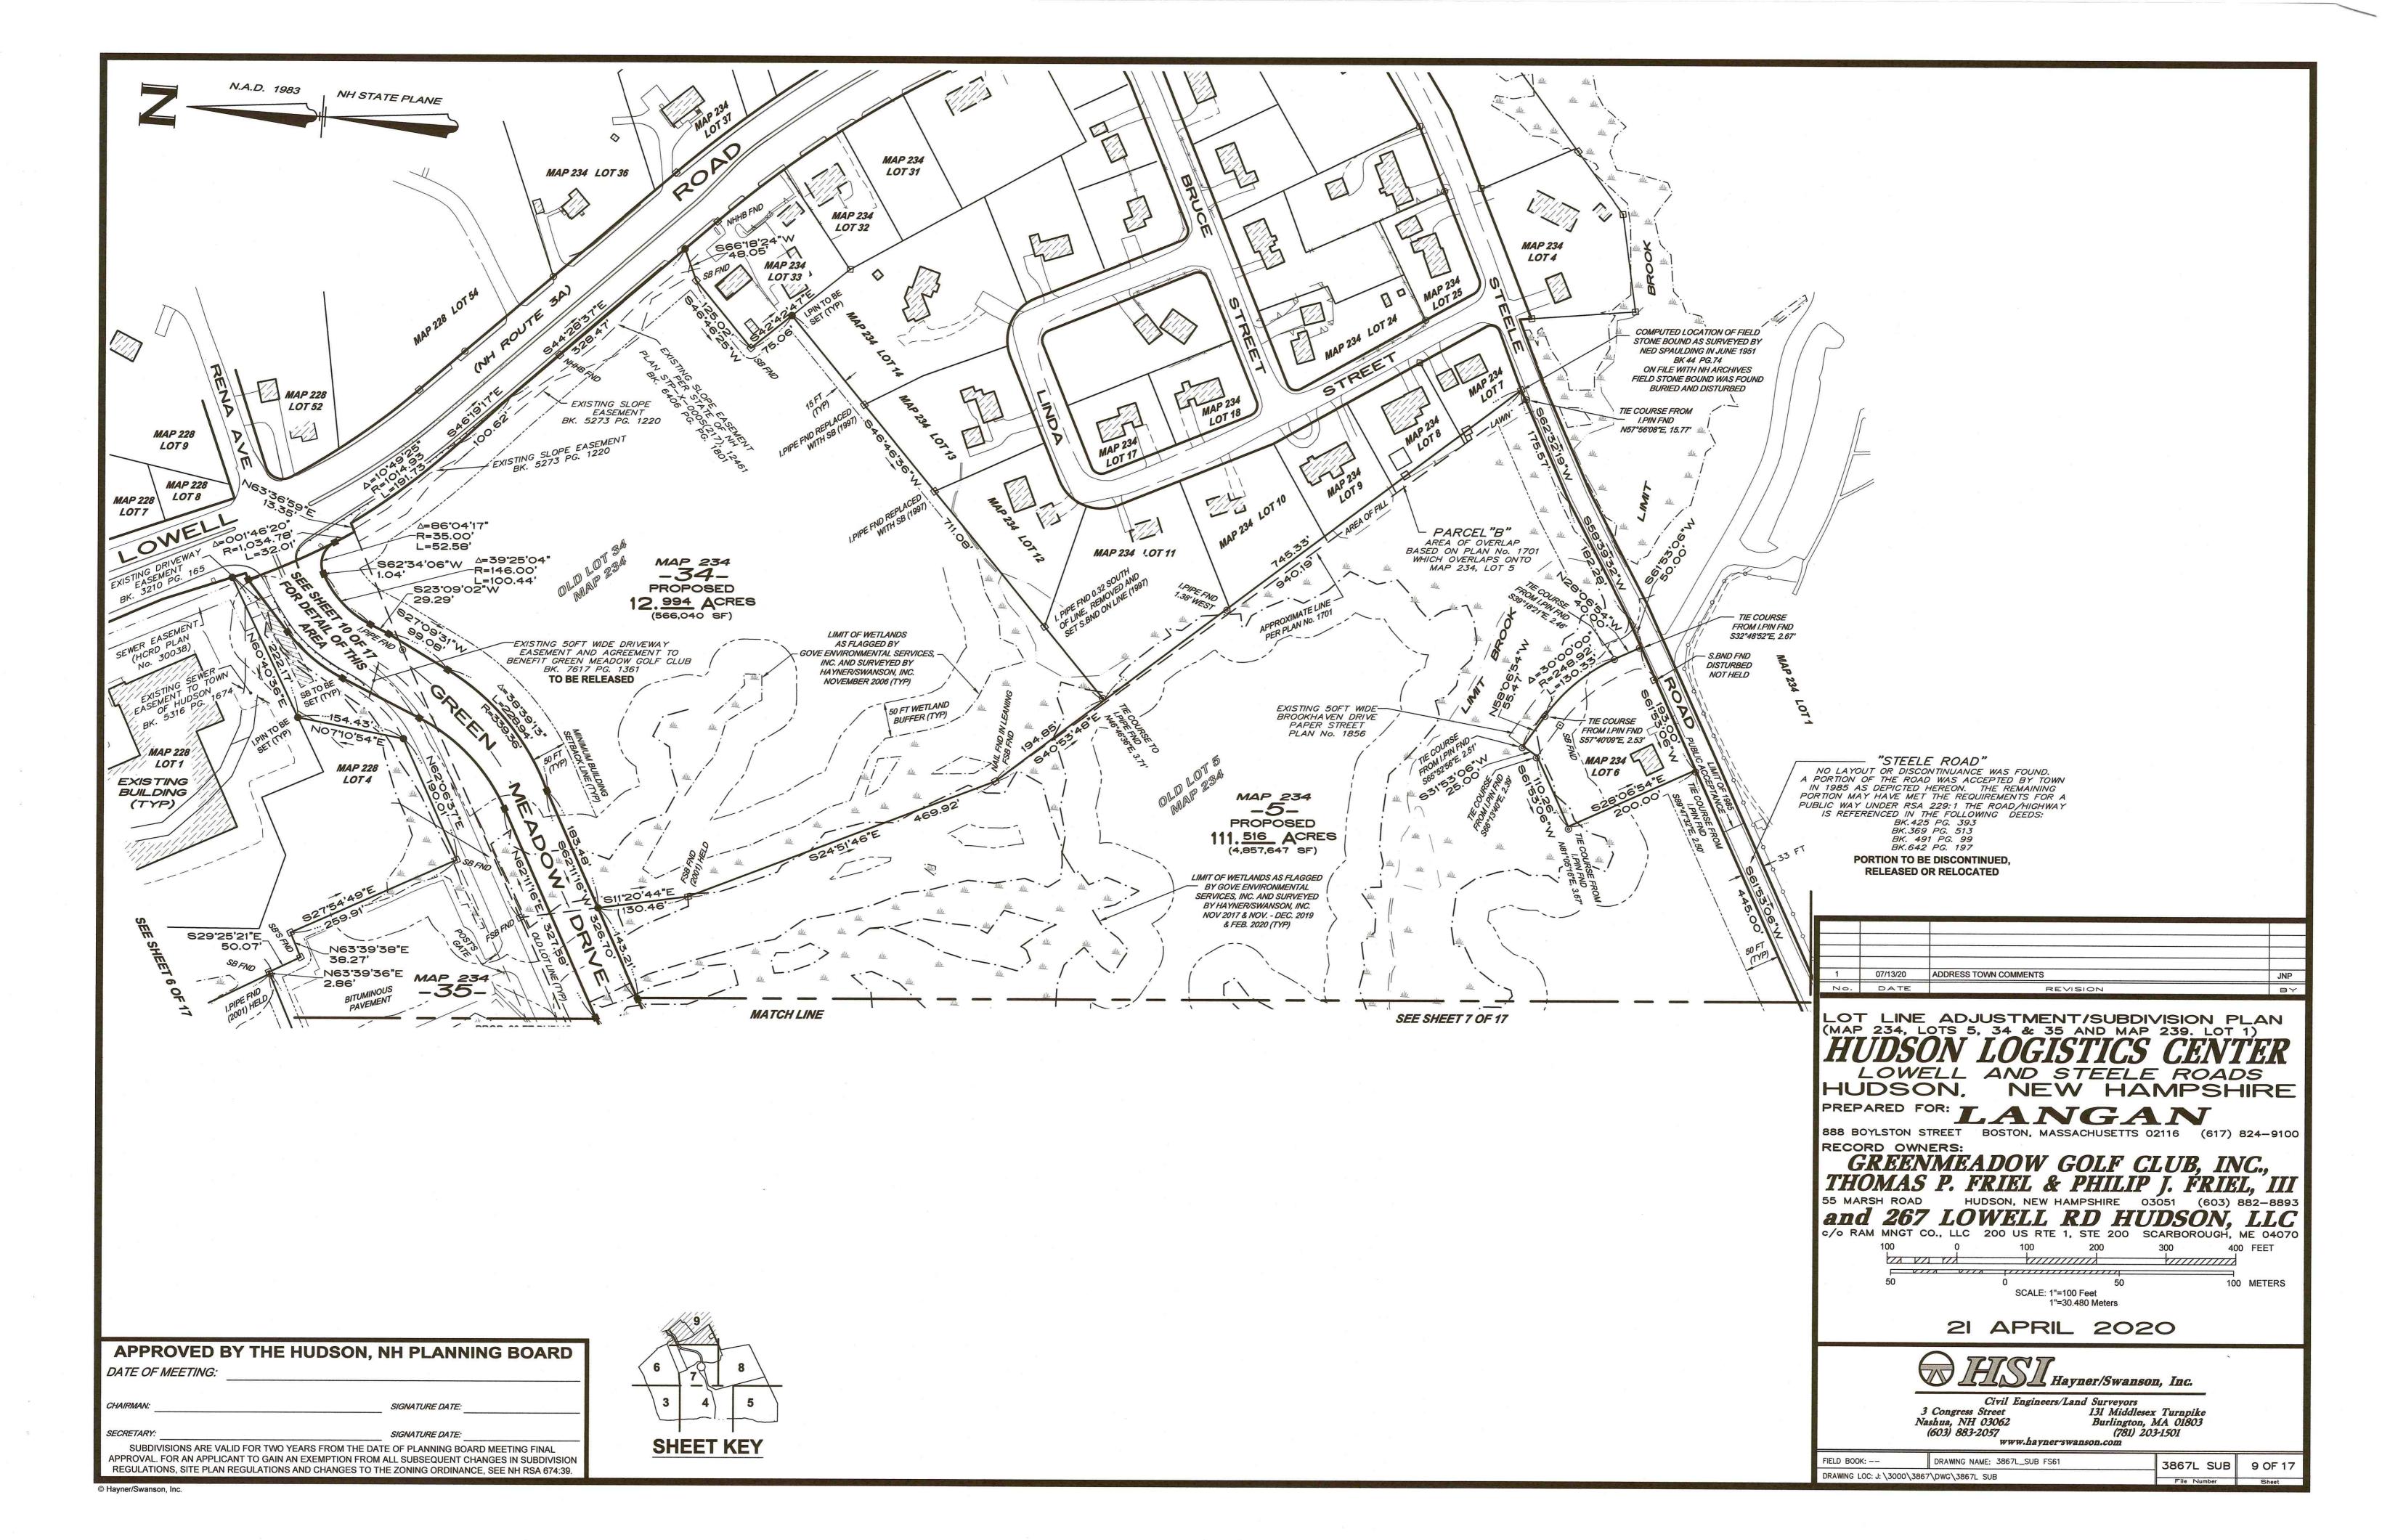
HUDSON, NEW HAMPSHIRE PREPARED FOR: LANGAN

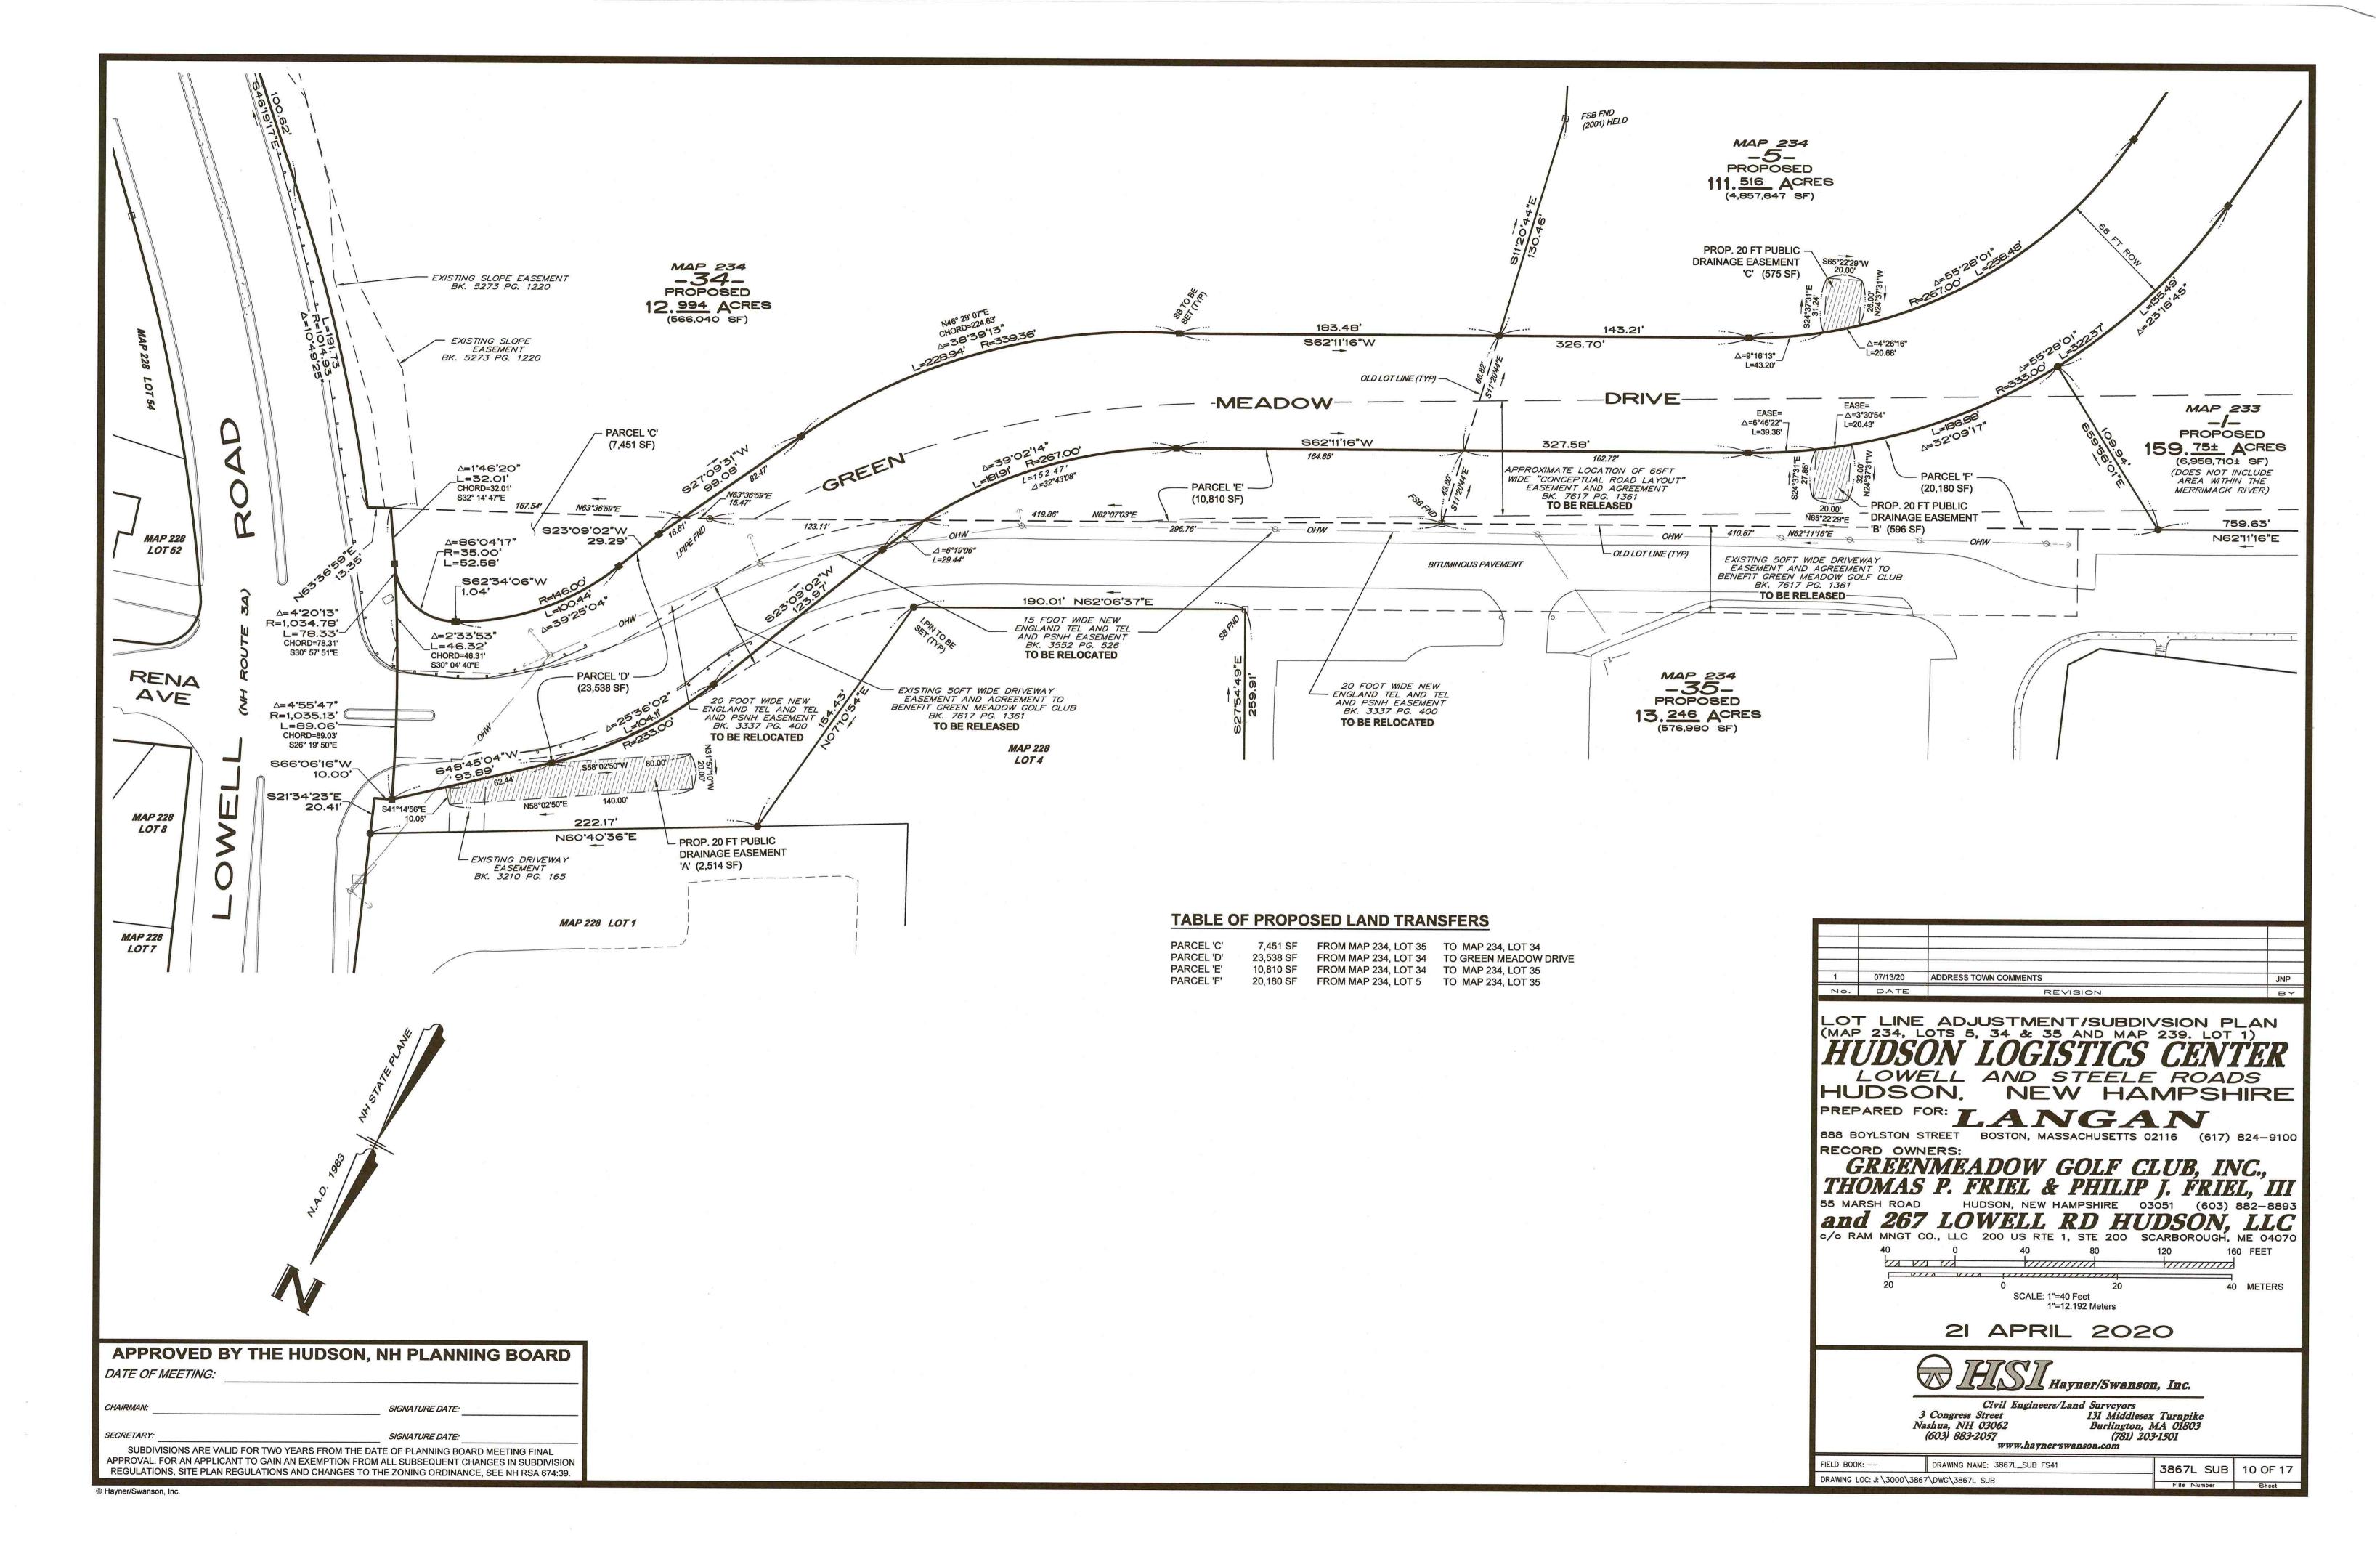
888 BOYLSTON STREET BOSTON, MASSACHUSETTS 02116 (617) 824-9100 GREENMEADOW GOLF CLUB, INC.,
THOMAS P. FRIEL & PHILIP J. FRIEL, III

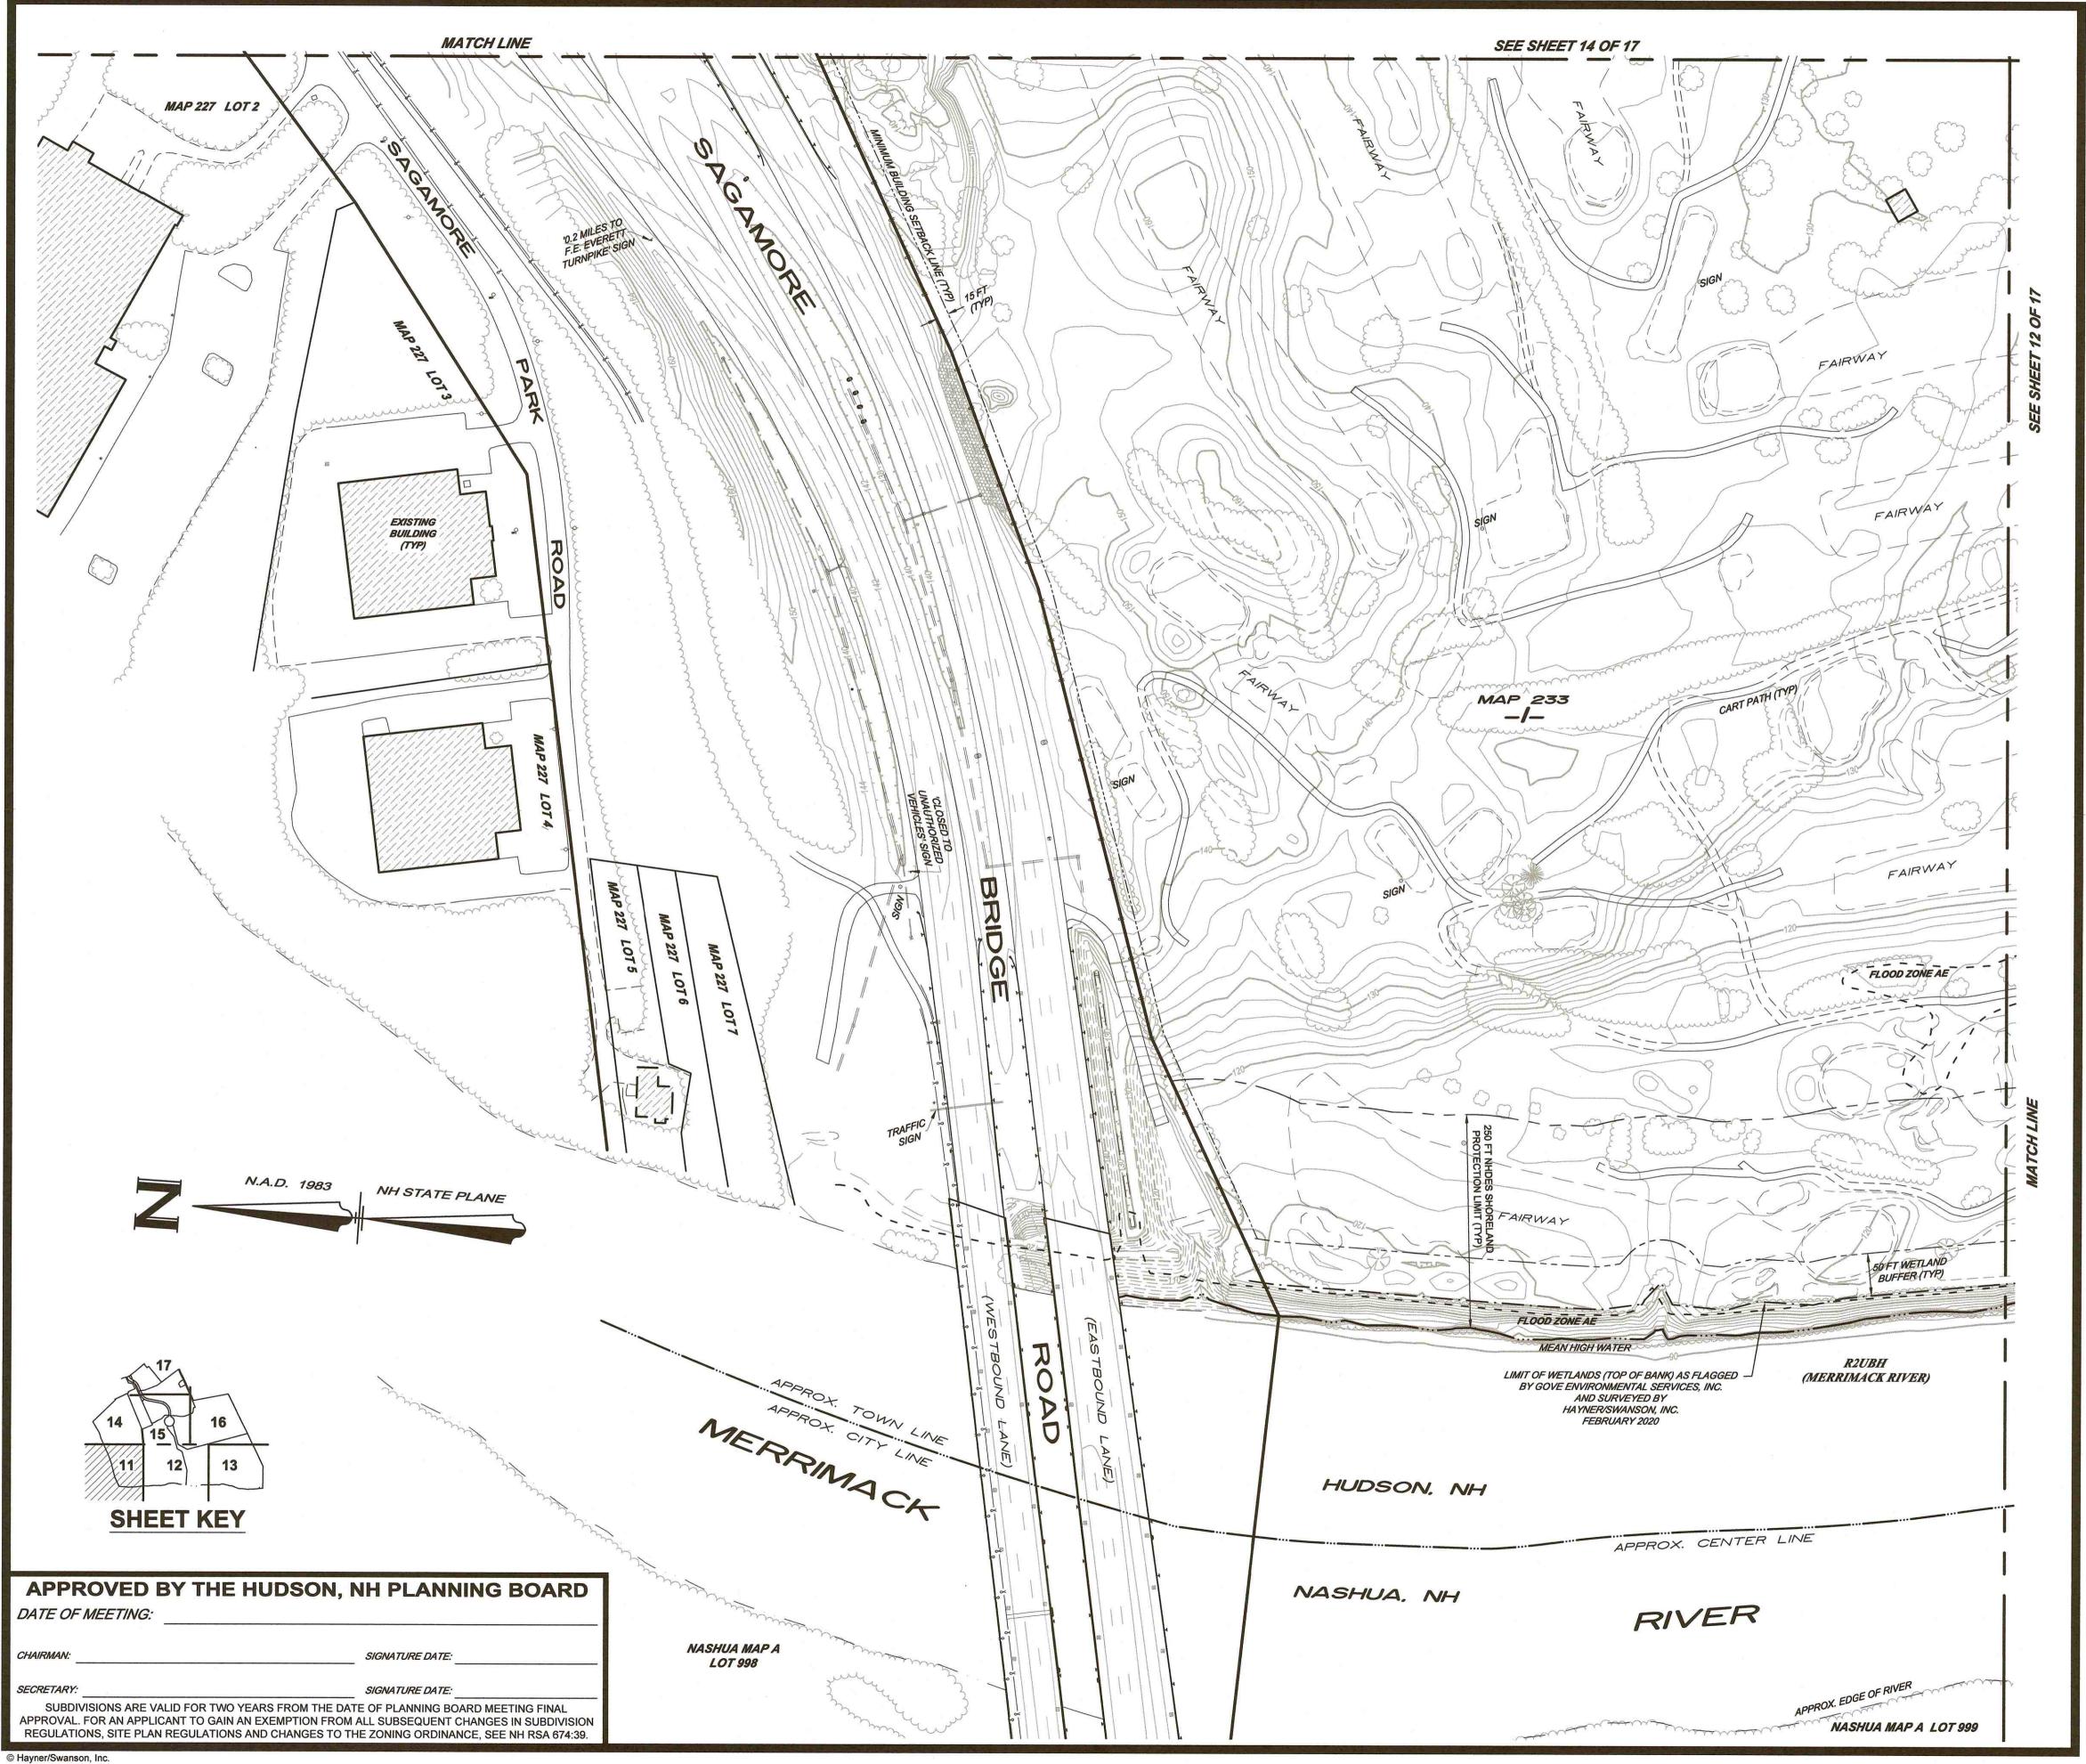
55 MARSH ROAD HUDSON, NEW HAMPSHIRE 03051 (603) 882-8893

and 267 LOWELL RD HUDSON, LLC

c/o RAM MNGT CO., LLC 200 US RTE 1, STE 200 SCARBOROUGH, ME 04070 SCALE: 1"=100 Feet 1"=30.480 Meters 21 APRIL 2020 Hayner/Swanson, Inc. Civil Engineers/Land Surveyors
ss Street 131 Middlesex Turnpike
NH 03062 Burlington, MA 01803
(781) 203-1501 3 Congress Street Nashua, NH 03062 (603) 883-2057 www.hayner-swanson.com FIELD BOOK: --DRAWING NAME: 3867L_SUB FS61 3867L SUB 8 OF 17 DRAWING LOC: J: \3000\3867\DWG\3867L SUB







NOTES:

- THE EXISTING TOPOGRAPHY, AS SHOWN ON THE PLANS, IS BASED ON AERIAL PHOTO MAPPING IN 2001 AND LIMITED FIELD TOPOGRAPHY MADE ON THE GROUND BETWEEN MARCH 2004 AND
- IT SHALL BE THE CONTRACTOR'S RESPONSIBILITY TO VERIFY THE ACCURACY OF THE EXISTING TOPOGRAPHY PRIOR TO EARTHWORK OPERATIONS. NO CLAIM FOR EXTRA WORK DUE TO TOPOGRAPHIC INACCURACY SHALL BE CONSIDERED AFTER EARTHWORK HAS COMMENCED.
- SURVEY CONTROL DATA:
 - HORIZONTAL DATUM: NAD83(1986)*
 HORIZONTAL PROJECTION: NH STATE PLANE
 - NGVD29 (FORMERLY KNOWN AS USGS DATUM)* VERTICAL DATUM: US SURVEY FEET
 - HORIZONTAL AND VERTICAL DATUMS WERE VERIFIED USING G.P.S. (KEYNET NETWORK) WITH OBSERVATIONS ON SITE AND ON NGS (FORMERLY USGS) "DISK D-26" LOCATED ON THE NORTHERLY SIDE OF NH ROUTE 101A, APPROXIMATELY 4.5 MILES WEST OF THE NASHUA LIBRARY.

LEGEND

**************************************	EXISTING GROUND CONTOUR	├ ⊤BM 1	TEMPORARY BENCHMARK
— II — —	STORM DRAIN & CATCH BASIN		BUILDING SETBACK LINE
= = ==================================	STORM DRAIN & MANHOLE		WETLAND FLAGGING LIMIT
= $=$ $($	STORM DRAIN & HEADWALL	PF01B	WETLAND DESIGNATION
$\triangleright = = =$	STORM DRAIN & END SECTION		WETLAND BUFFER LINE
	SANITARY SEWER & MANHOLE	—	WIRE FENCE
-W(d)	WATER MAIN & HYDRANT		CHAINLINK FENCE
-W(b)	WATER MAIN & GATE VALVE		CURBING
-G(b)	GAS LINE & GATE VALVE	• • • • • •	GUARDRAIL
€Φ	UTILITY POLE WITH GUY SUPPORT	• • • • •	CONCRETE
**	STREET LIGHT	PO CONSONO	
— <i>ОНW</i>	OVERHEAD ELECTRIC & TELEPHONE		RIPRAP / STONE
-©— <i>UGW(c)</i> —-⊕-	UNDERGROUND ELEC/TEL & MANHOLES	XXXXXXXXXXXX	RETAINING WALL
▼	SIGN		CONIFEROUS TREE
\sim	TREE LINE		CONIFEROUS TREE
		25	DECIDUOUS TREE
		and the	



1-888-DIG-SAFE 1-888-344-7233

▶ UTILITY NOTE ◀

THE UNDERGROUND UTILITIES DEPICTED HEREON HAVE BEEN LOCATED FROM FIELD SURVEY INFORMATION AND PLOTTED FROM EXISTING DRAWINGS. THE SURVEYOR MAKES NO GUARANTEES THAT THE UNDERGROUND UTILITIES DEPICTED COMPRISE ALL SUCH UTILITIES IN THE AREA, EITHER IN SERVICE OR ABANDONED. THE SURVEYOR FURTHER DOES NOT WARRANT THAT THE UNDERGROUND UTILITIES SHOWN ARE IN THE EXACT LOCATION INDICATED ALTHOUGH THEY ARE LOCATED AS ACCURATELY AS POSSIBLE FROM THE INFORMATION AVAILABLE. THE SURVEYOR HAS NOT PHYSICALLY LOCATED THE UNDERGROUND PORTIONS OF THE UTILITIES.

1	07/13/20	ADDRESS TOWN COMMENTS	JN
No.	DATE	REVISION	В

TOPOGRAPHIC SUBDIVISION PLAN (MAP 234, LOTS 5, 34 & 35 AND MAP 239. LOT 1) HUDSON LOGISTICS CENTER LOWELL AND STEELE ROADS HUDSON, NEW HAMPSHIRE

PREPARED FOR: LANGAN 888 BOYLSTON STREET BOSTON, MASSACHUSETTS 02116 (617) 824-9100

RECORD OWNERS:

GREENMEADOW GOLF CLUB, INC.,
THOMAS P. FRIEL & PHILIP J. FRIEL, III

55 MARSH ROAD HUDSON, NEW HAMPSHIRE 03051 (603) 882-8893 and 267 LOWELL RD HUDSON, LLC c/o RAM MNGT CO., LLC 200 US RTE 1, STE 200 SCARBOROUGH, ME 04070

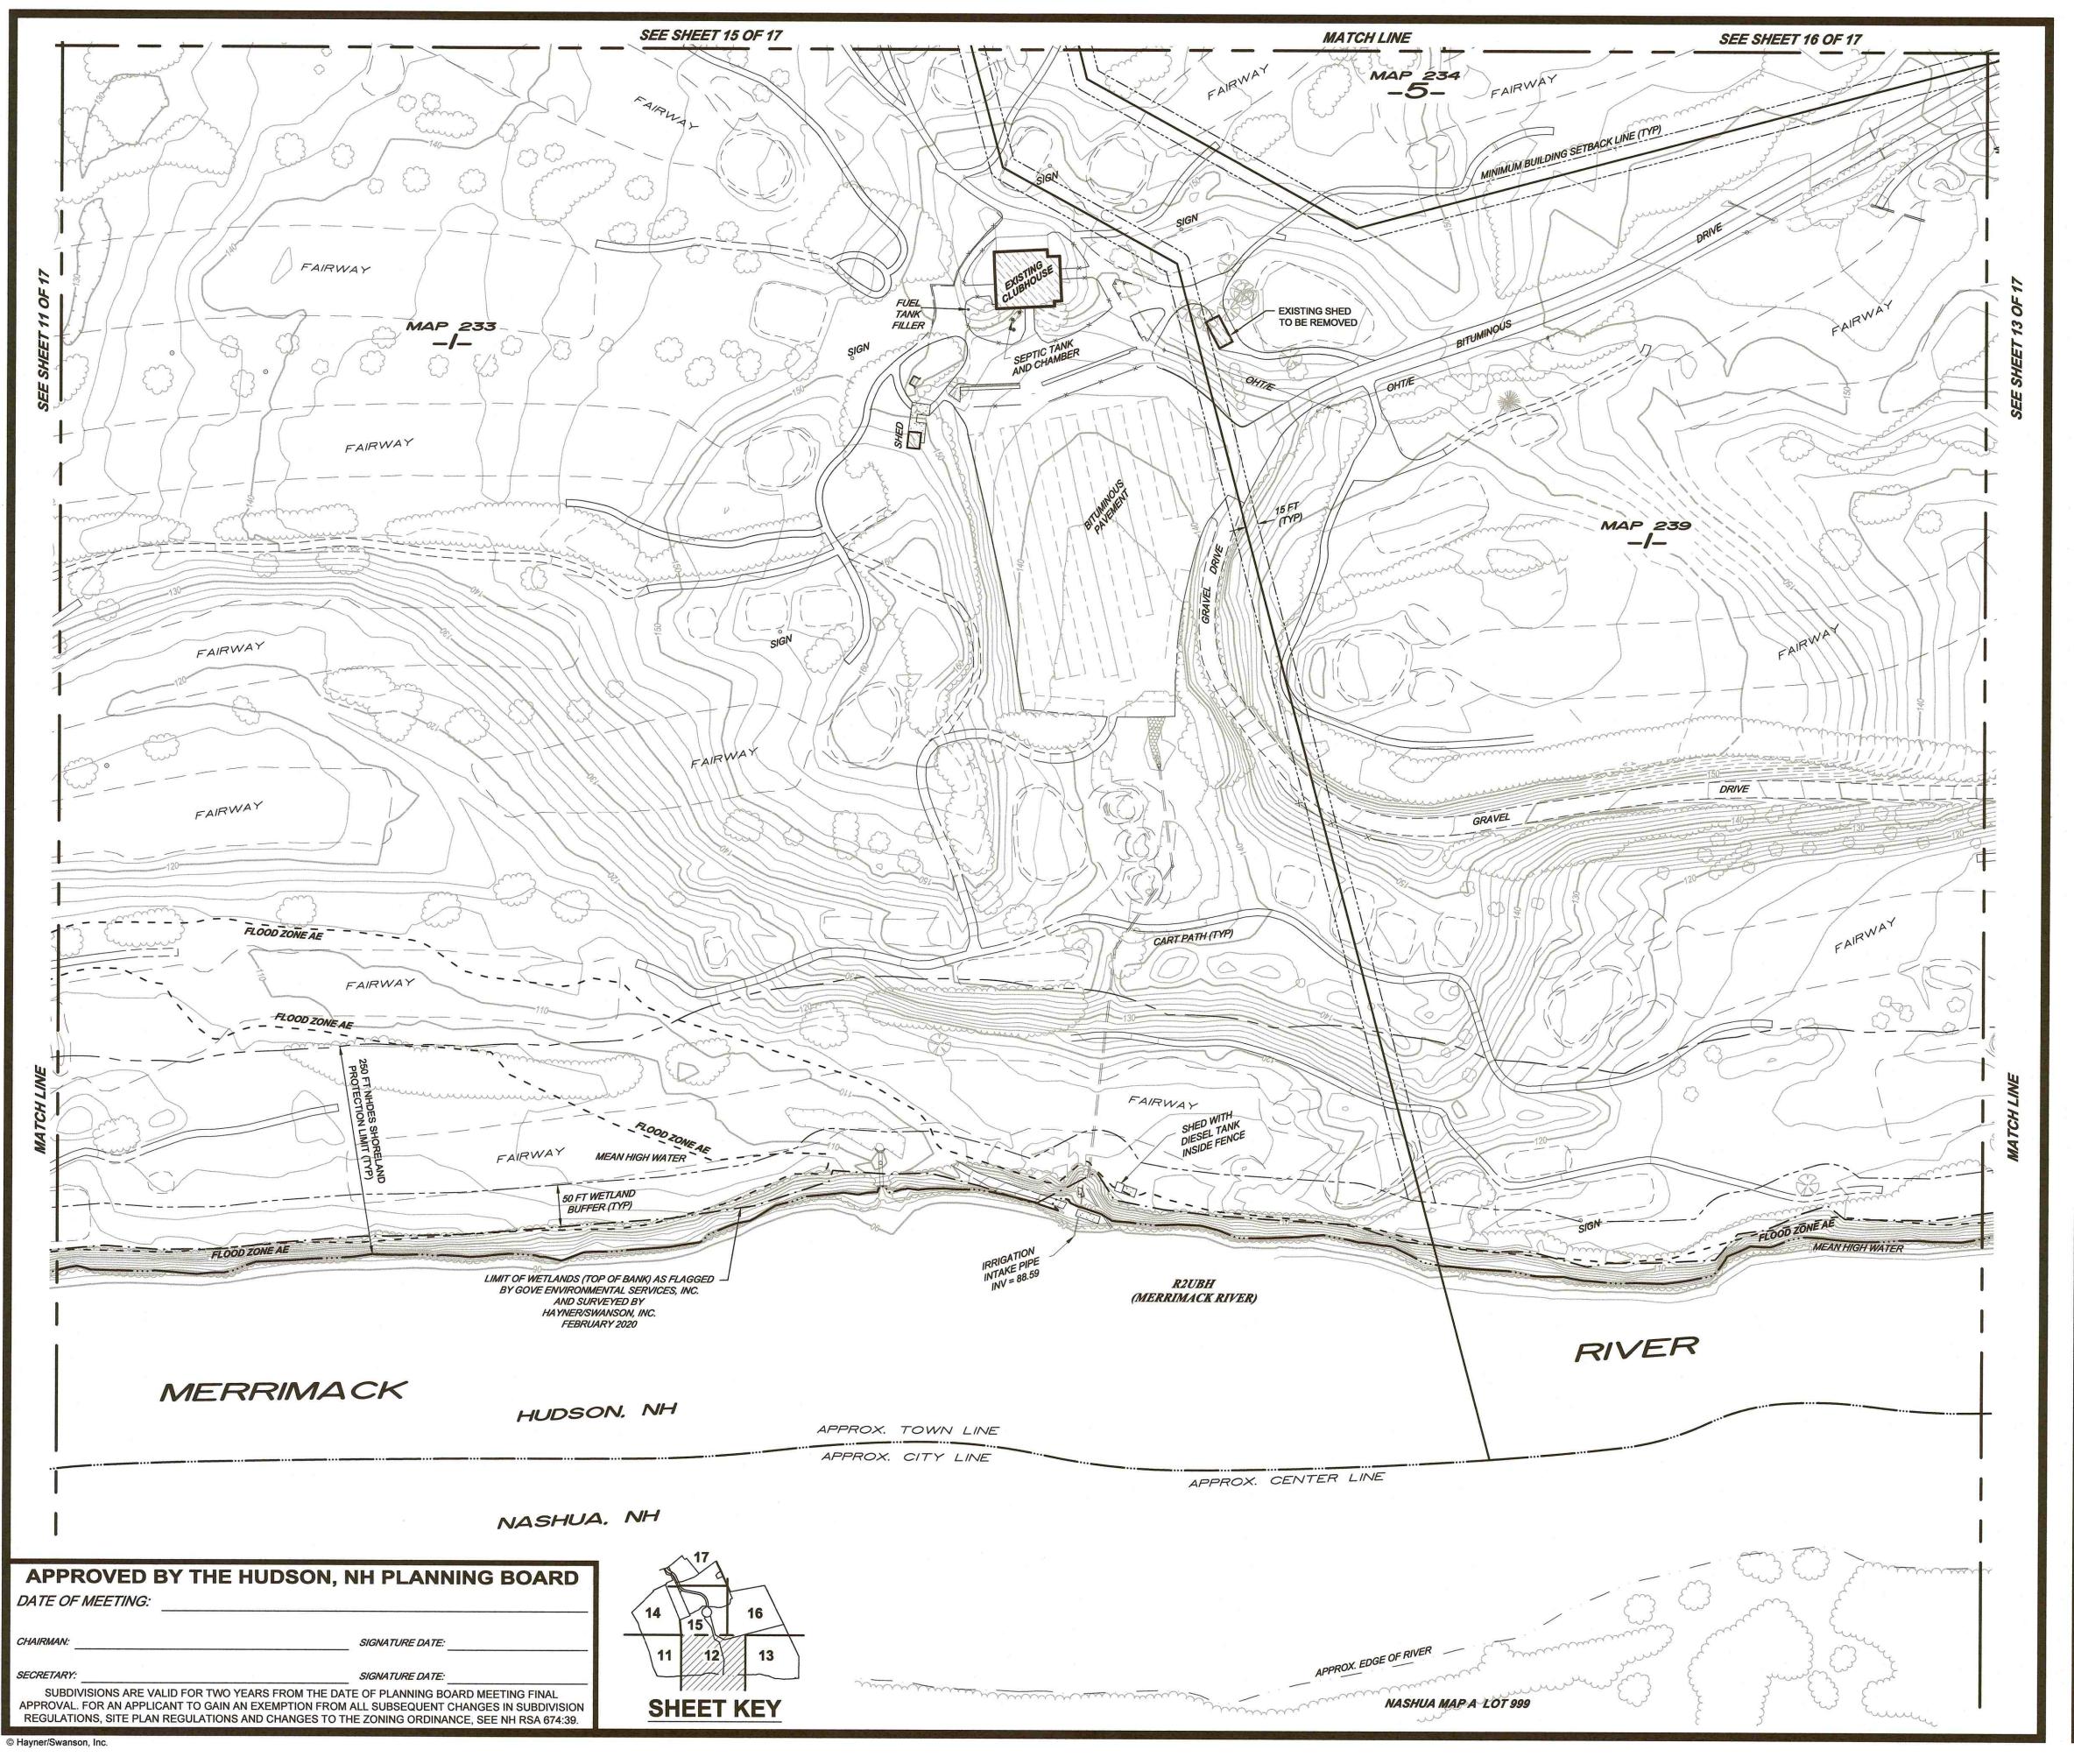
VIIA VIIA (IIIIIIIIIIIIII 100 METERS SCALE: 1"=100 Feet 1"=30.480 Meters

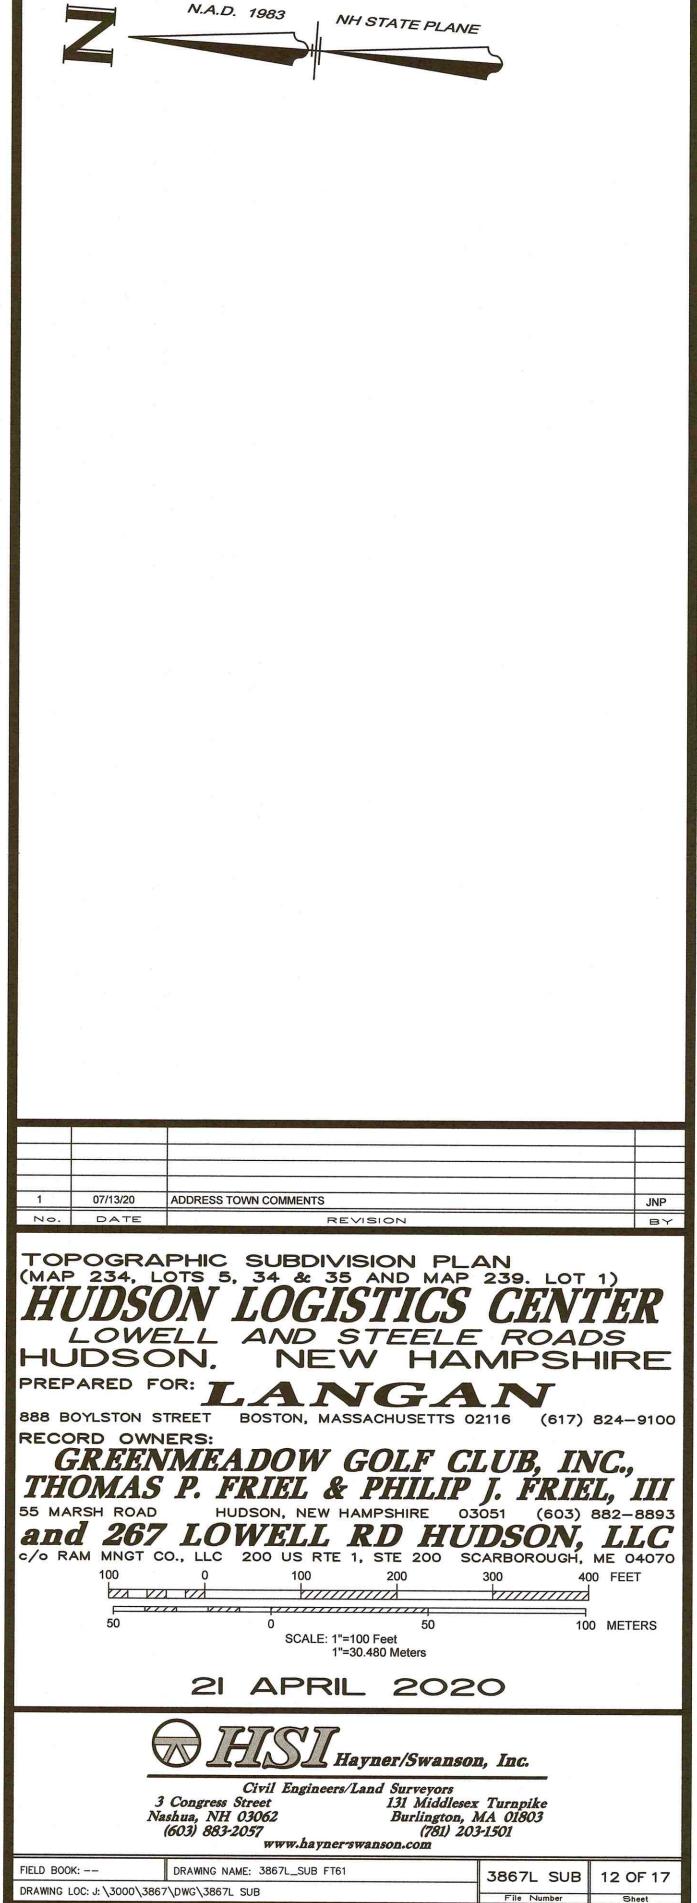
21 APRIL 2020

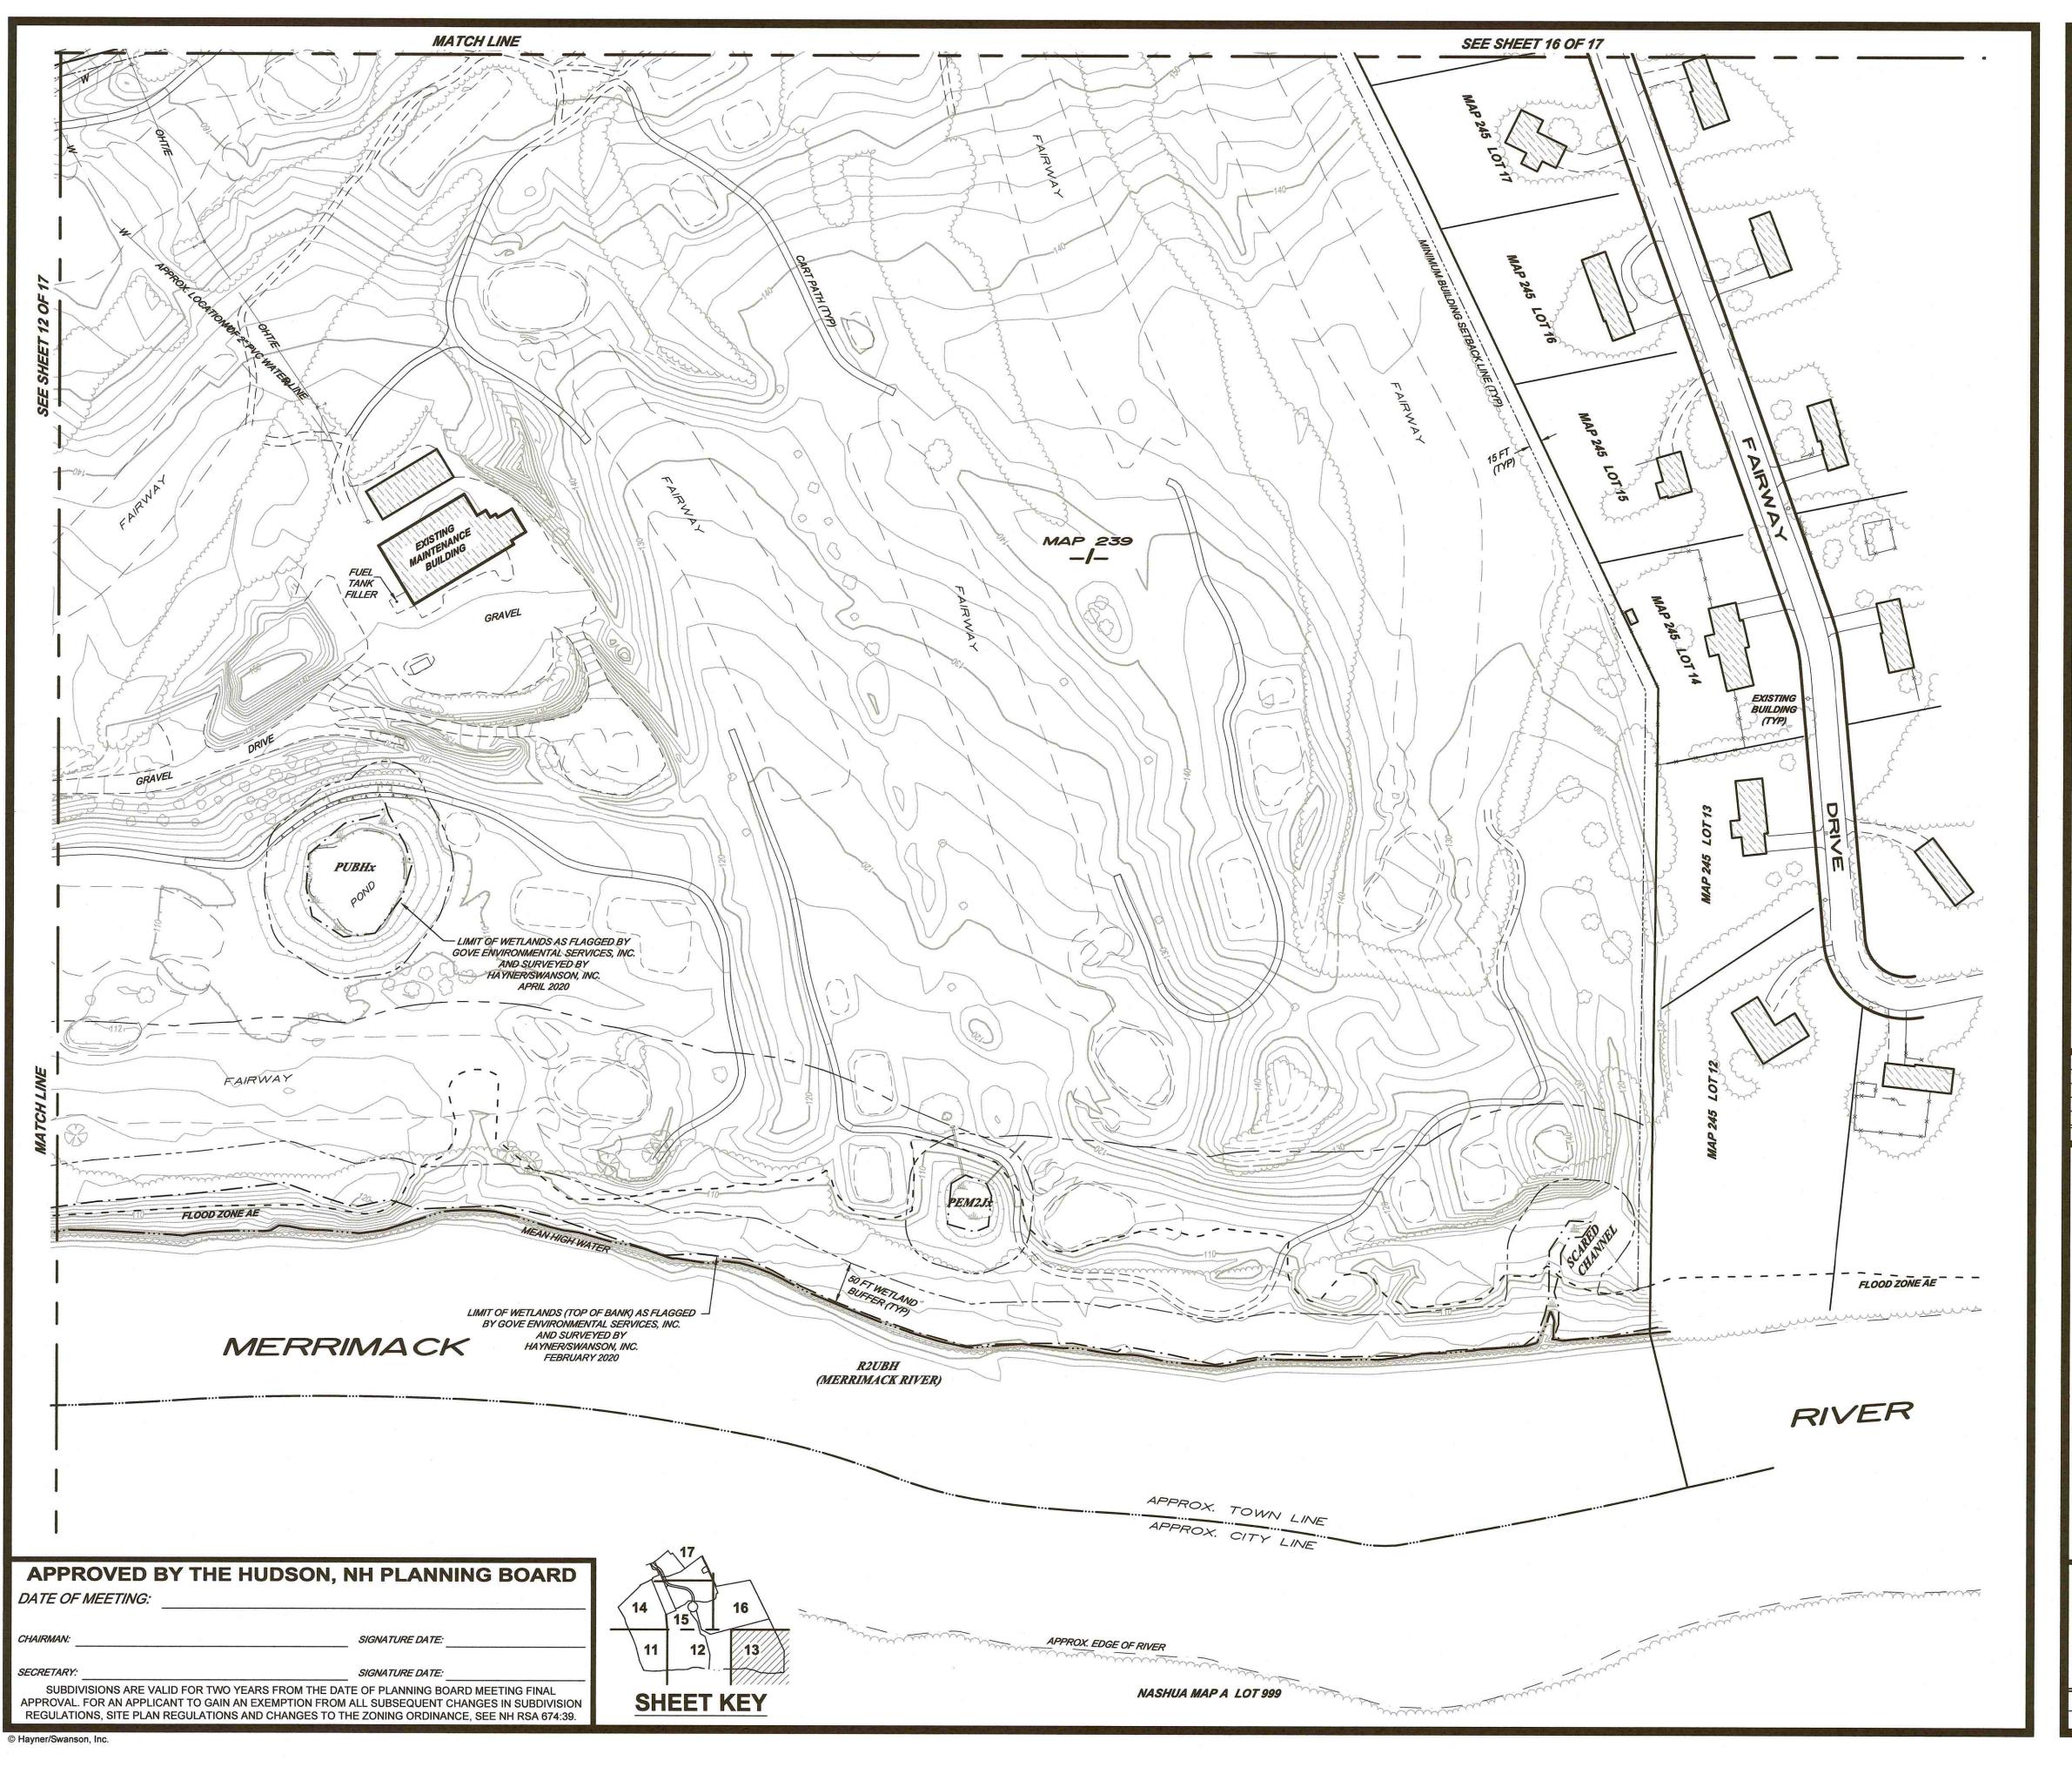


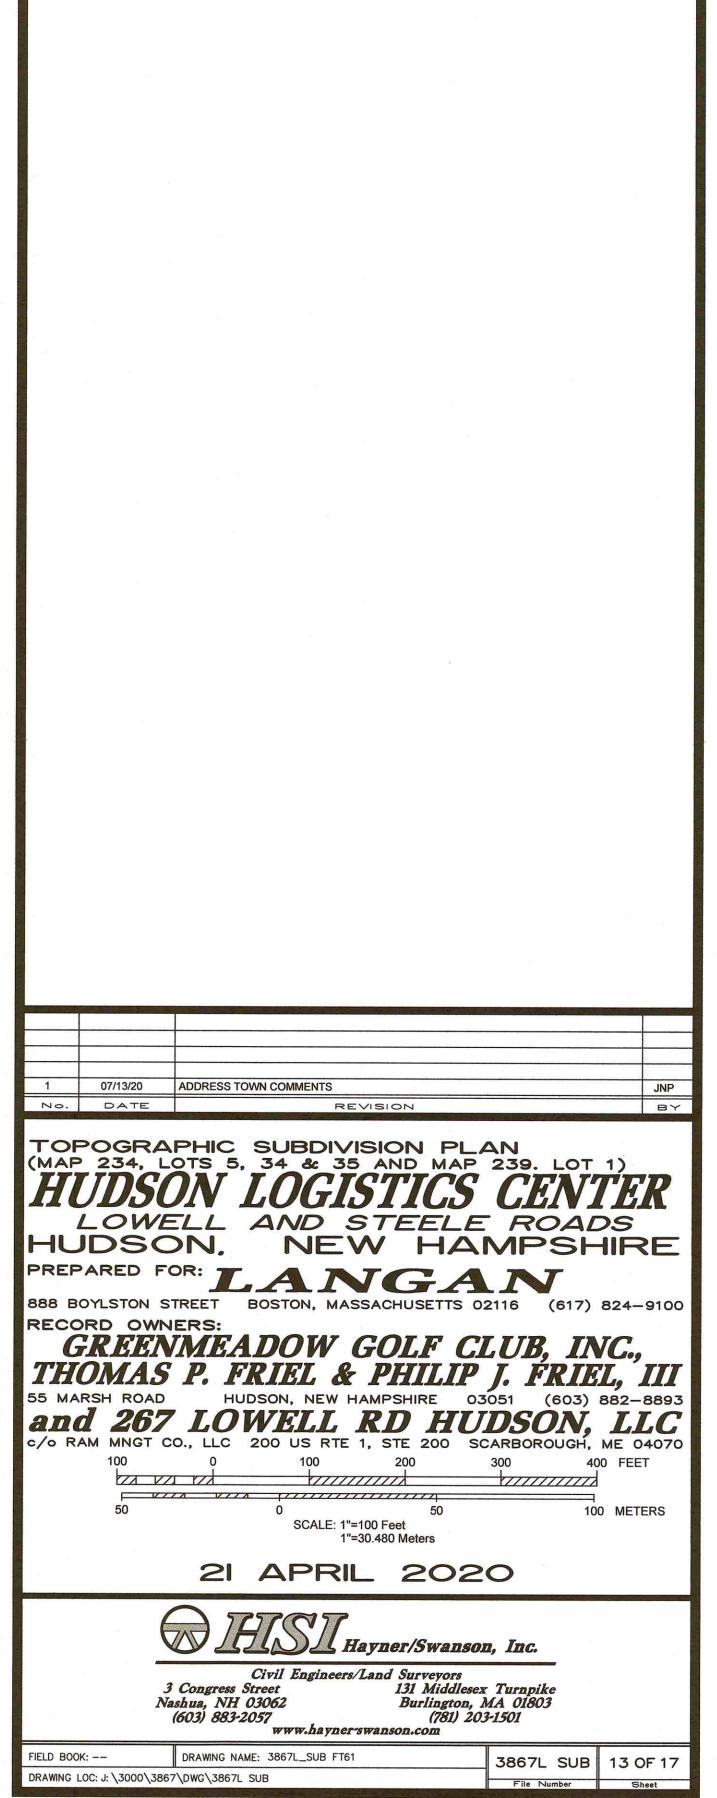
Civil Engineers/Land Surveyors
s Street 131 Middlesex Turnpike
H 03062 Burlington, MA 01803
P2_2057 (781) 203-1501 3 Congress Street Nashua, NH 03062 (603) 883-2057 www.hayner-swanson.com

FIELD BOOK: --DRAWING NAME: 3867L_SUB FT61 3867L SUB 11 OF 17 DRAWING LOC: J: \3000\3867\DWG\3867L SUB File Number Sheet













NH STATE PLANE

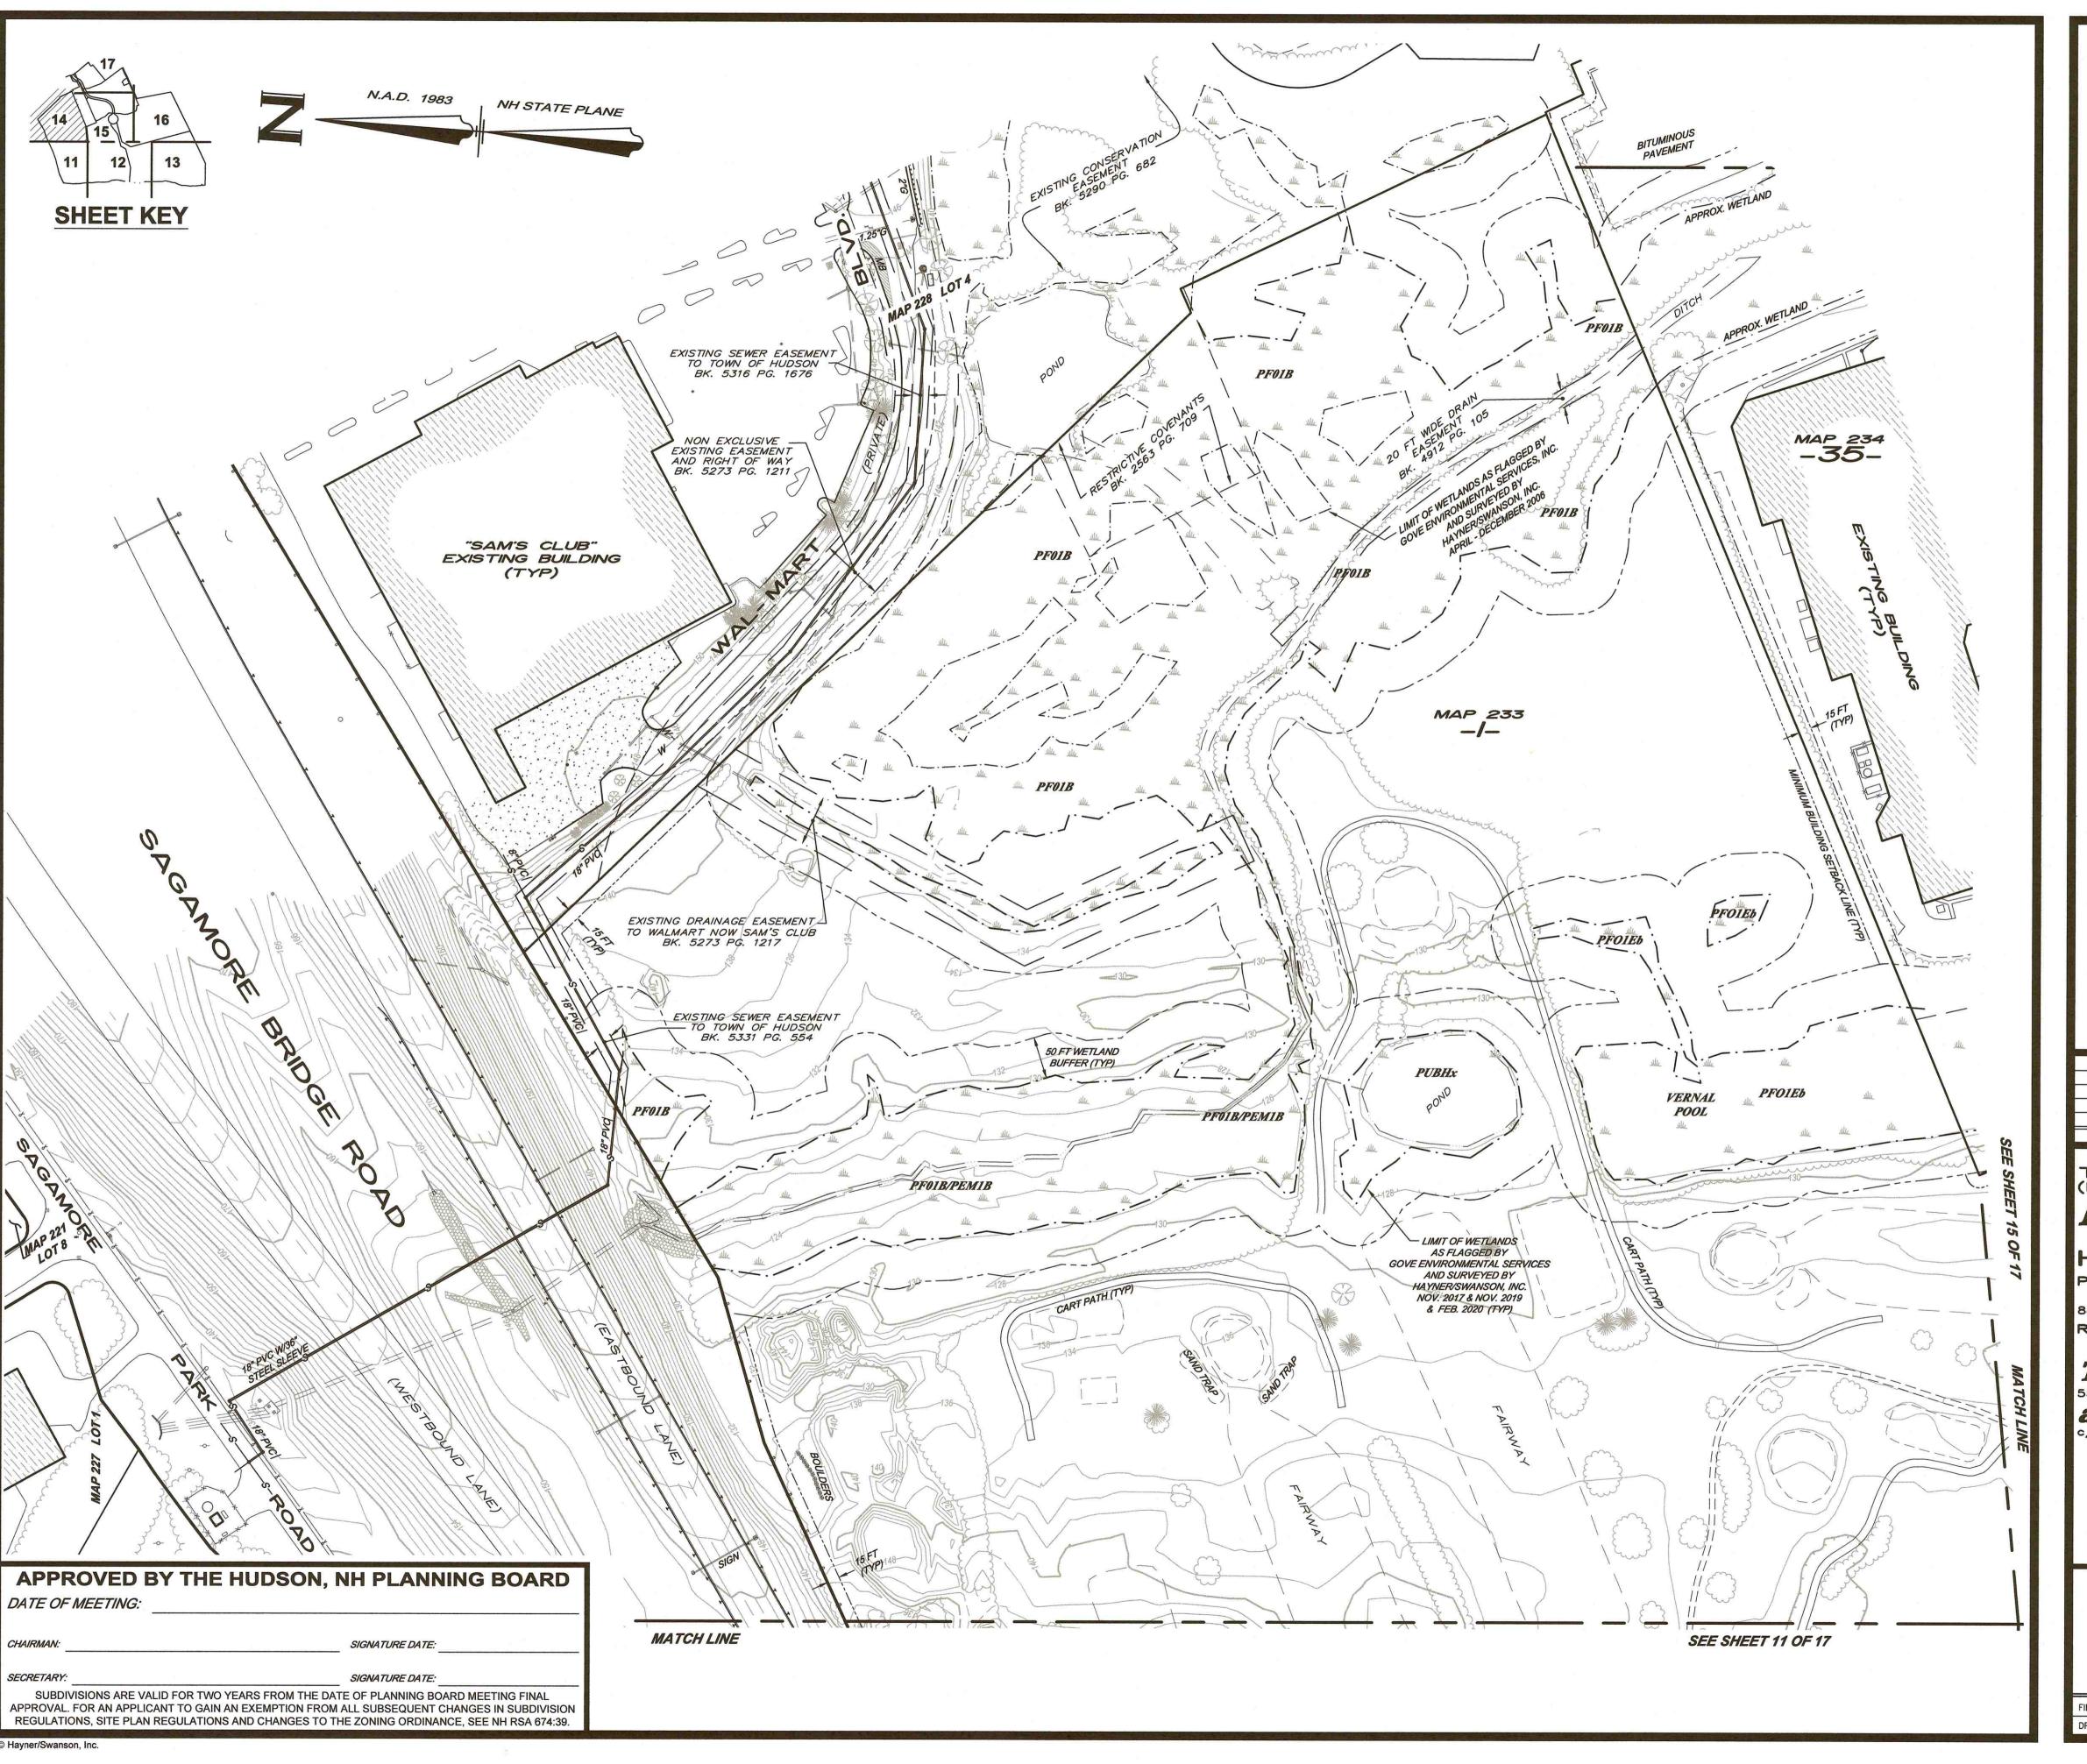

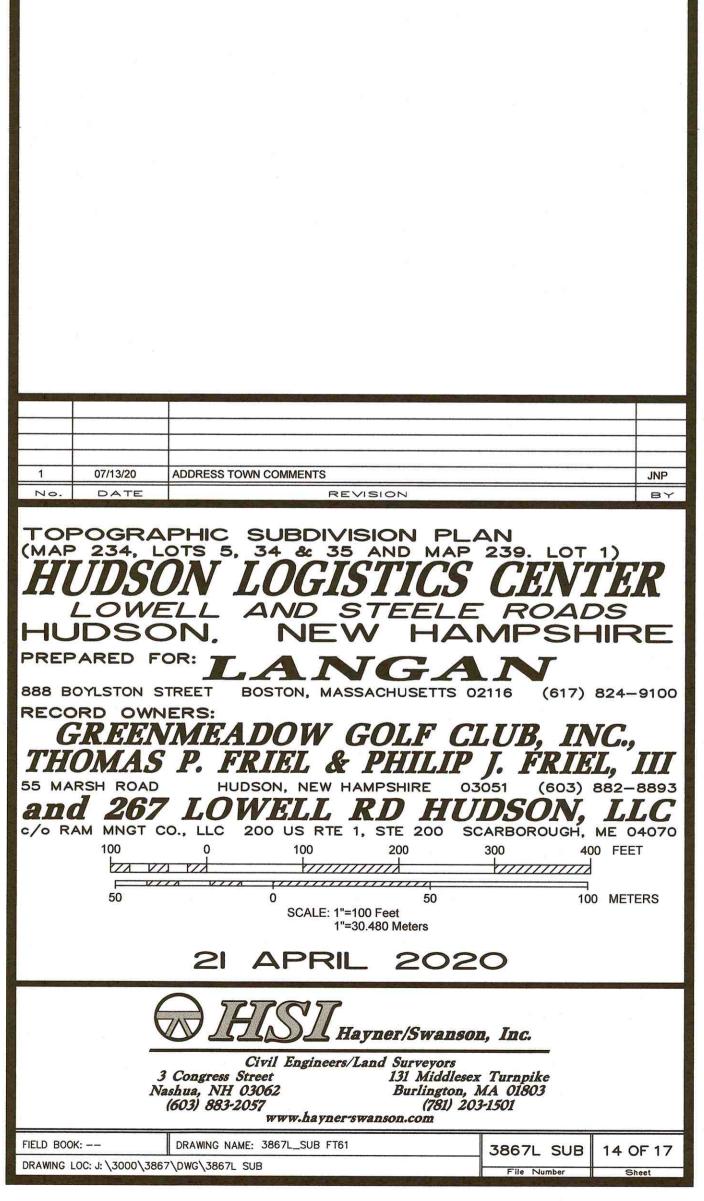


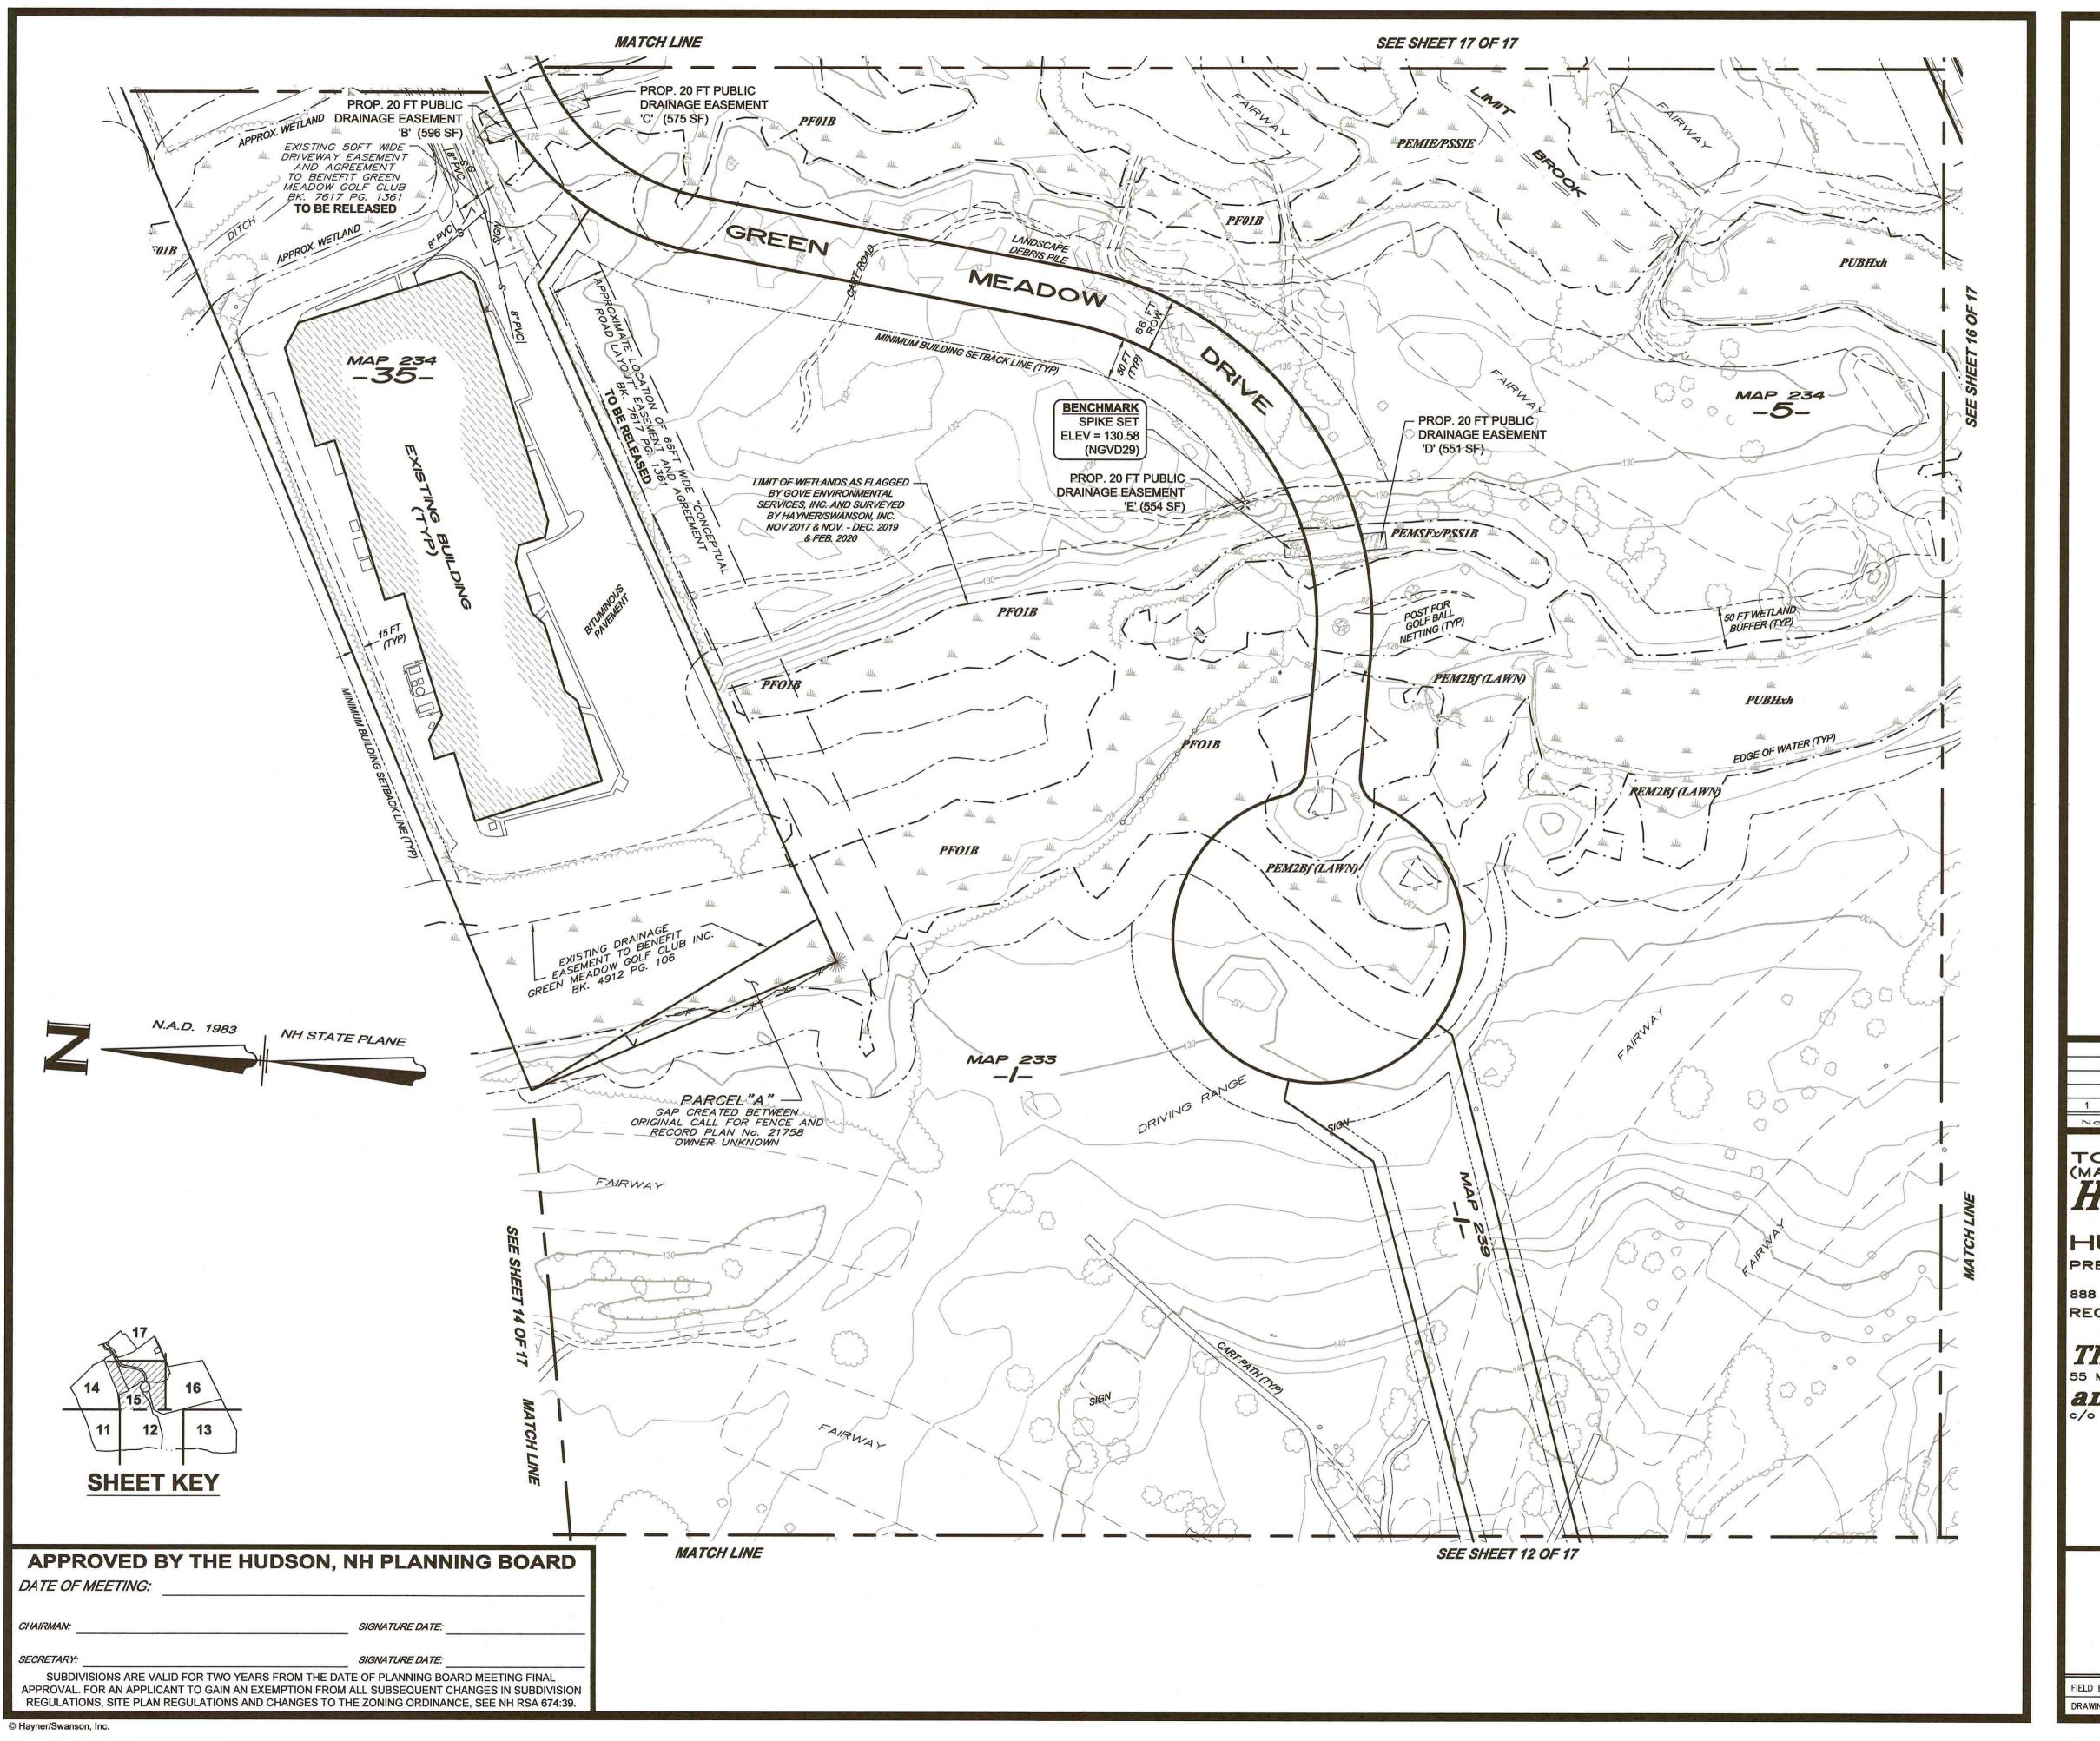


	Mark Property					88. ZI		
TOF	07/13/20 DATE POGRA 234, L	PHIC OTS 5	, 34 &	PEVISION SE AN	N PL	AN 239. L	.от 1 V7	
TOF (MAP) HU PREP 888 BG RECO G THO 55 MA	POGRA 234, L 1DS LOW DSC ARED F OYLSTON S PRD OWN REEN OMAS RSH ROAD	PHIC OTS 5 ON ELL ON. FOR: I STREET NERS: VME.	SUBC. 34 & LOG. AND. NE. BOSTON, BOSTON, NE. JOSON, NE. 100	IVISIO 35 AN IST STI STI W MASSACH W HAMPS L RI RTE 1, ST	ID MAP ICS EELE HA IUSETTS OF HU E 200 S 500	CEI RO MPS MPS 2116 (6)	VI AD SH S17) 8: IN (RIEI 603) 8: N, JGH, M	ER SIRE 24-9100 C., III 32-8893 LLC
TOF (MAP) HU PREP 888 BG RECO G THO 55 MA	POGRA 234, L 1DS DSC ARED F OYLSTON S REEN OMAS RSH ROAD MINGT O 100 ZAL Z 50	PHIC OTS 5 ON ELL ON. OR: I STREET NERS: VMEA OO., LLC O O OO., LLC O O OO., LLC O O OO., LLC O O O OO., LLC O O OO., LLC O O O OO., LLC O O O O O O O O O O O O O O O O O O	SUBE 34 & LOG AND NE BOSTON, NE BOSTON, NE WELL 200 US 100 100 100 100 100 100 100 100	IVISION 35 AND STATE OF A PROPERTY OF A PROP	IN PLID MAP ICS ICS EFLE HA IUSETTS OF ILF CONTROL SHIP SHIRE OF SHIP SHIRE OF SHIP SHIRE OF SHIP SHIP SHIP SHIP SHIP SHIP SHIP SHIP	Z39. L CEI ROS NPS 22116 (6 LUB, J. FR 3051 (6 LUB, GARBOROL 300	VI AD SH S17) 8: IN (RIEI 603) 8: N, JGH, M	ER SIRE 24-910 C., J. III 32-889 E 0407 FEET
TOF (MAP) HU PREP 888 BG RECO G THO 55 MA	POGRA 234, L JDS LOW DSC ARED F OYLSTON S REEN OMAS RSH ROAD M MNGT O 100 ZAL Z 50	PHIC OTS 5 ON ELL ON. OR: I STREET NERS: VMEA P. I OO., LLC OO., LLC OO SIASHUA, NH (603) 883-	SUBE 34 & LOG AND NE BOSTON, NE BOSTON, NE WELL 200 US 100 100 100 100 100 100 100 100	IVISION 35 AND STATE OF STATE	IN PLID MAP ICS ICS EFLE HA IUSETTS OF ILF CONTROL SHIP SHIRE OF SHIP SHIRE OF SHIP SHIRE OF SHIP SHIP SHIP SHIP SHIP SHIP SHIP SHIP	Z39. L CEI ROS NPS 22116 (6 LUB, J. FR 3051 (6 LUB, GARBOROL 300	VI AD 5H 517) 8: IN (RIEI 603) 8: 400 100	ER SIRE 24-9100 C., J. III 32-8893 LLC E 04070 FEET

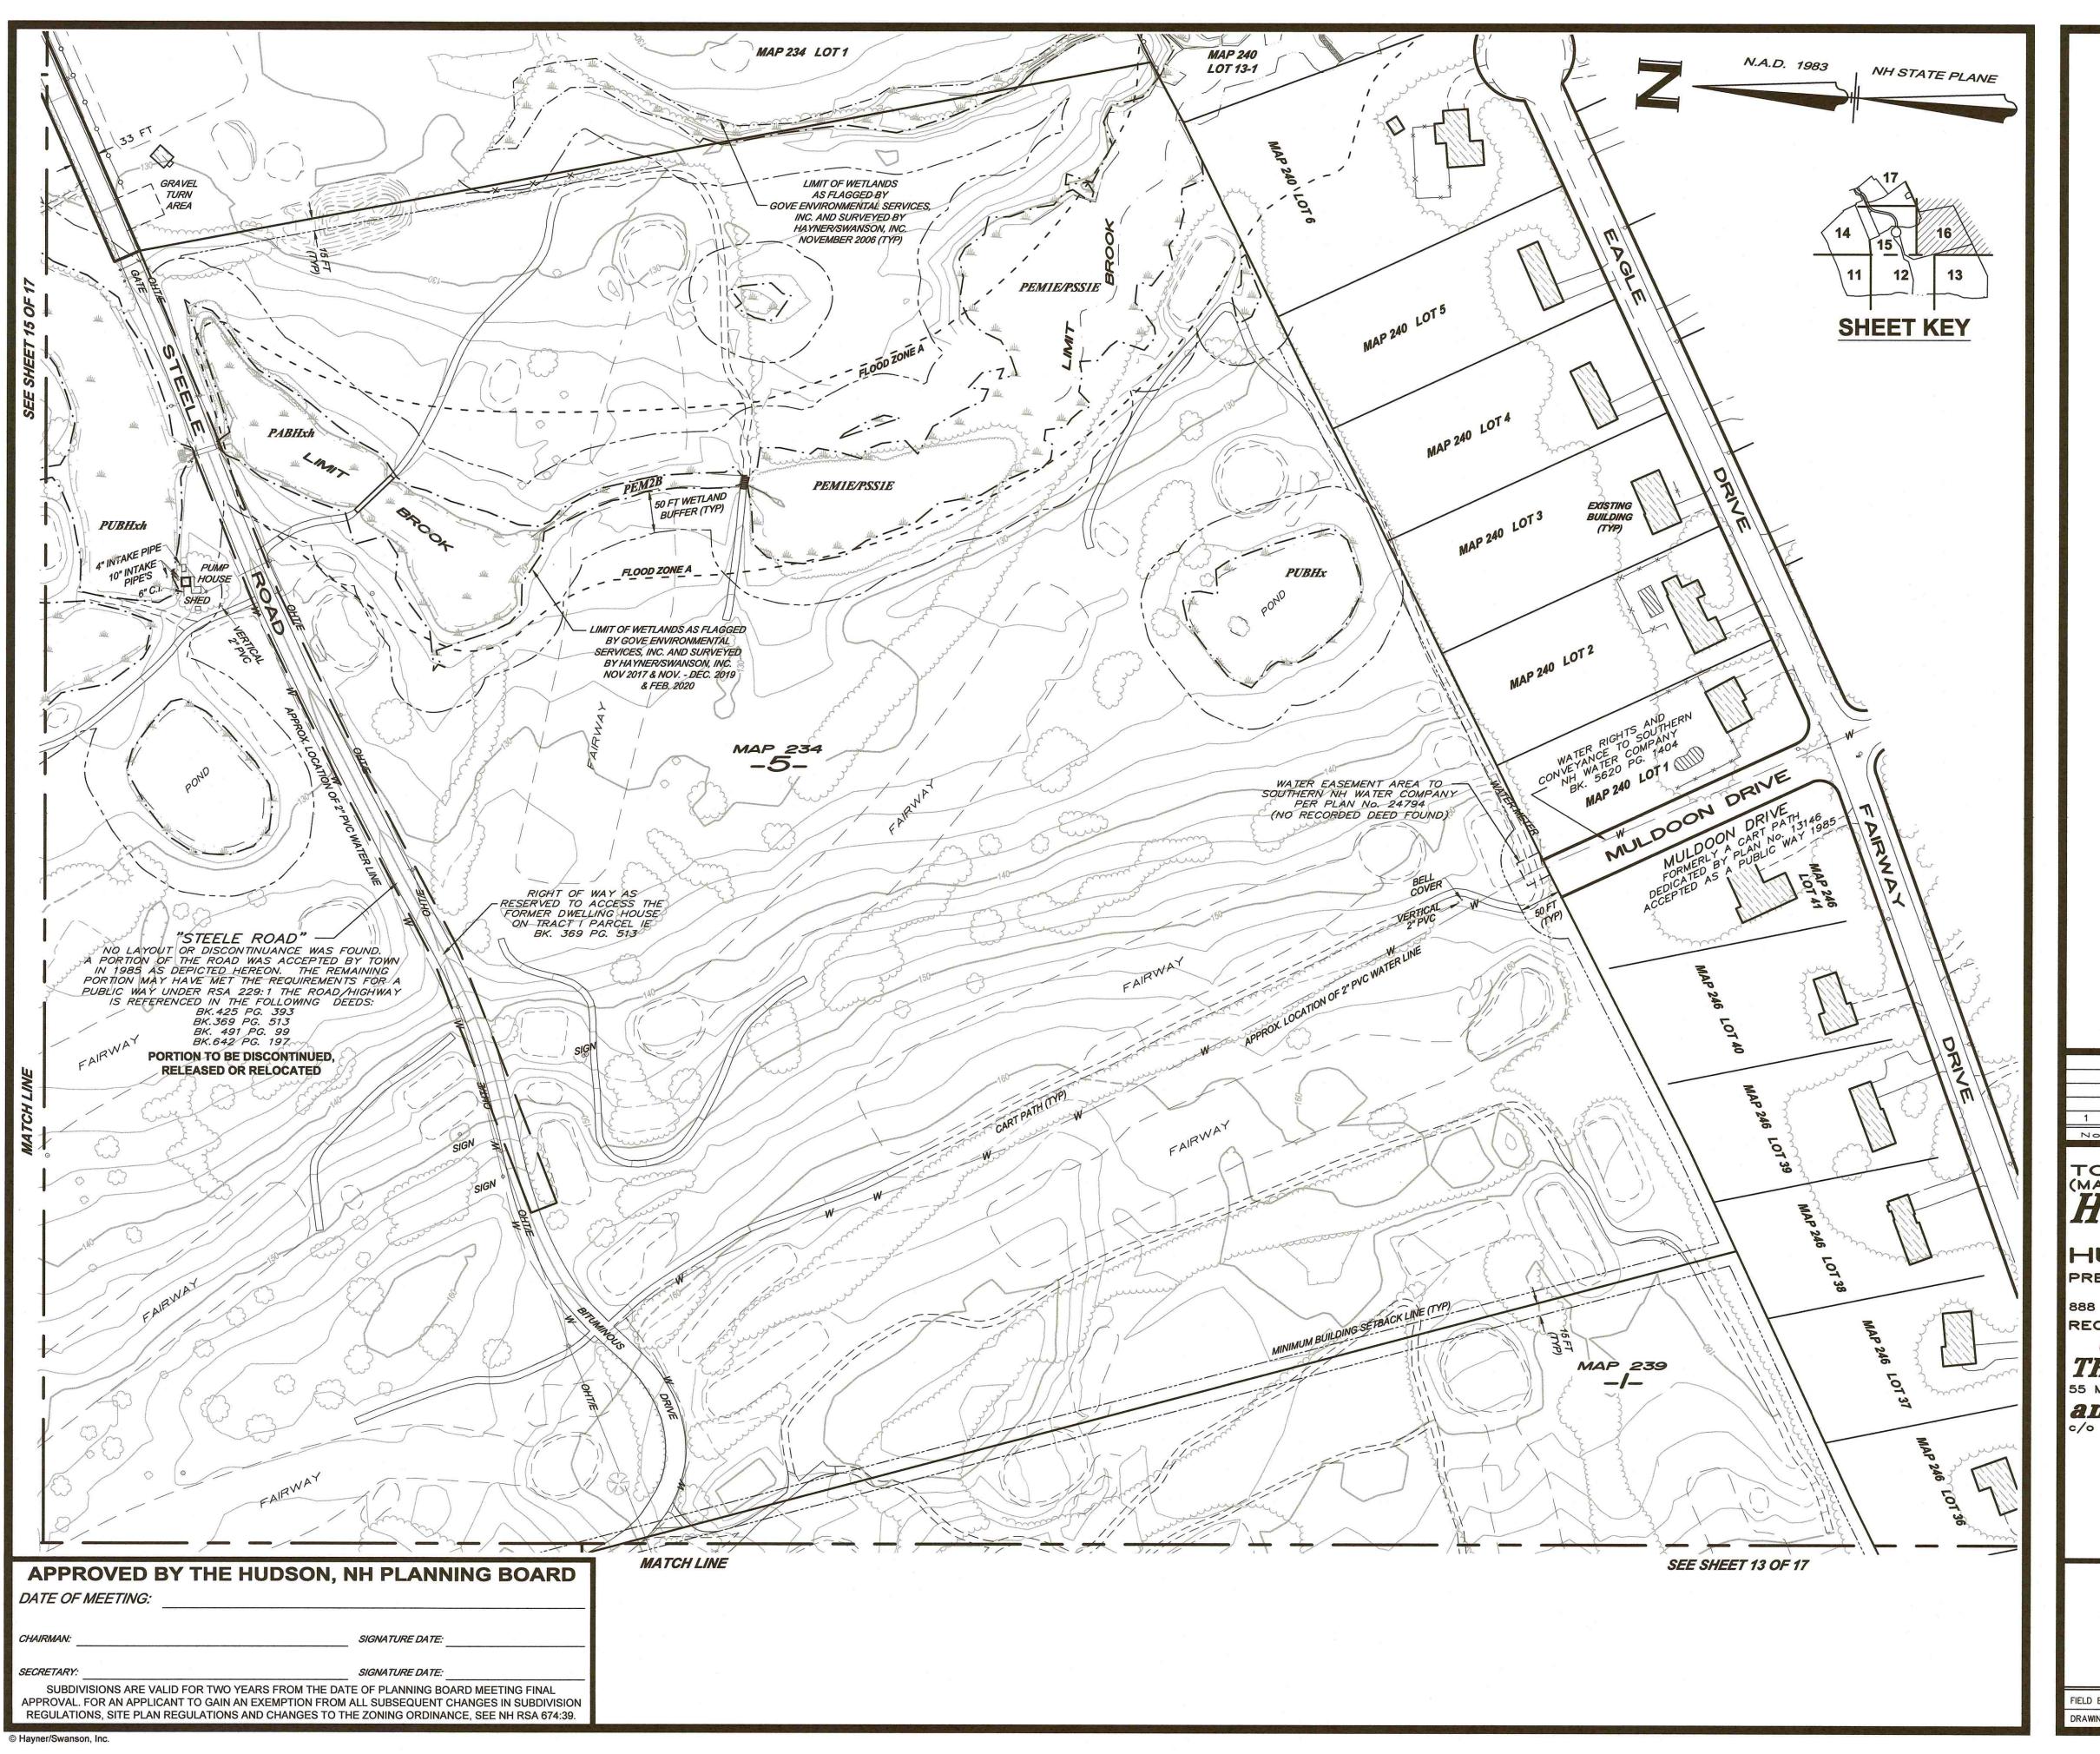

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1 07/13/20 No. DATE	APHIC S	REVIS	VIS 国际第二届作品的12%	N	JNP
No. DATE	PHIC S OTS 5, 3	REVIS	ION PLA	N 239. LOT CENI ROAL	BY
TOPOGRA (MAP 234, L HUDS LOWE HUDS PREPARED FOR	PHIC SOTS 5, 3 ON LONG ON. OR: LONG TREET BO	UBDIVIS 14 & 35 NO S NEW	ION PLA	CENT ROAL MPSH	BY
TOPOGRA (MAP 234, L HUDS LOWE HUDS PREPARED FOR SECORD OWN GREEN THOMAS	PHIC S OTS 5, 3 ON L ON. OR: L	DEVISOR OF THE WAIN AND STON, MASSA	ION PLA AND MAP 2 TICS TEELE HAN GA ACHUSETTS 021 PHILIP	CENT CENT ROAL APSH 16 (617) UB, IN	1) TER OS HIRE 824-9100
TOPOGRA (MAP 234, L HUDS LOWE HUDS PREPARED FOR SECORD OWN GREEN	PHIC S OTS 5, 3 ON L ELL A ON. OR: I. STREET BO HUDSO LOW	DEVISOR OF THE VIELL & TON, NEW HAMPELL & TON, MEN HAMPELL & TON, MEN HAMPELL & TON, NEW	ION PLA AND MAP 2 TICS TEELE HAN GA ACHUSETTS 021 OLF CL PHILIP APSHIRE 030 ED HUL STE 200 SCA	CENT ROAL APSH 16 (617) UB, IN FRIE 51 (603) DSON, RBOROUGH,	1) TER DS HIRE 824-9100 NC., L, III 882-8893 LLC
TOPOGRA (MAP 234, L HUDSC HUDSC PREPARED FOR SECORD OWN GREEN THOMAS 55 MARSH ROAD and 267 c/o RAM MNGT CO 100	PHIC S. OTS 5, 3 ON L. ON. OR: I. J. OR: II. J. OR: I.	SUBDIVIS OGIS NEW AND STON, MASSA ON, NEW HAM FILL R O US RTE 1, 100 SCALE: 1"=100 1"=30.4	ION PLA AND MAP 2 ITICS TEELE HAN GA ACHUSETTS 021 OLF CL PHILIP MPSHIRE 030 STE 200 SCA 200 3	CENT ROAL APSH 16 (617) UB, IN I. FRIE 51 (603) DSON, RBOROUGH, 00 40	1) IER DS HIRE 824-9100 IC., III 882-8893 LLC ME 04070
TOPOGRA (MAP 234, L HUDS LOWE HUDS PREPARED FOR 888 BOYLSTON S RECORD OWN GREEN THOMAS 55 MARSH ROAD and 267 c/o RAM MNGT OF 100	PHIC S. OTS 5, 3 ON L. ON. OR: I. J. OR: II. J. OR: I.	DOW GIEL & 100 SCALE: 1"=100 1"=30.4	ION PLA AND MAP 2 ITICS TEELE HAN GAA ACHUSETTS 021 OLF CL PHILIP APSHIRE 030 STE 200 SCA 200 3	CENTAROAL APSH 16 (617) UB, IN I. FRIE 51 (603) DSON, IRBOROUGH, 100 100	1) TER DS HIRE 824-9100 NC., L, III 882-8893 LLC ME 04070 00 FEET
TOPOGRA (MAP 234, L HUDS) LOWE HUDS PREPARED FOR 888 BOYLSTON S RECORD OWN GREEN THOMAS 55 MARSH ROAD AND 267 c/o RAM MNGT OF 50	PHIC S OTS 5, 3 ON L ELL A ON. OR: I. STREET BO HUDSO ON, LLC 20 ON CON, LLC 20 O	DUBDIVIS A & 35 OGIS NEW AND STON, MASSA OW G IEL & 1 ON, NEW HAM FELL R O US RTE 1, 100 100 1"=30.4 APRIL FILE OUS RIE 1, 100 1"=30.4 APRIL OUS RIE 1, 100 1"=30.4 APRIL OUS RIE 1, 100 1"=30.4	ION PLA AND MAP 2 ITICS ITICS ITEELE HAN CHUSETTS 021 OLF CL PHILIP IN THE 030 IN THE 03	CENTAROAL APSH 16 (617) UB, IN FRIE 51 (603) SON, RBOROUGH, 00 40 100 Inc. Turnpike 4 01803	1) TER DS HIRE 824-9100 NC., L, III 882-8893 LLC ME 04070 00 FEET

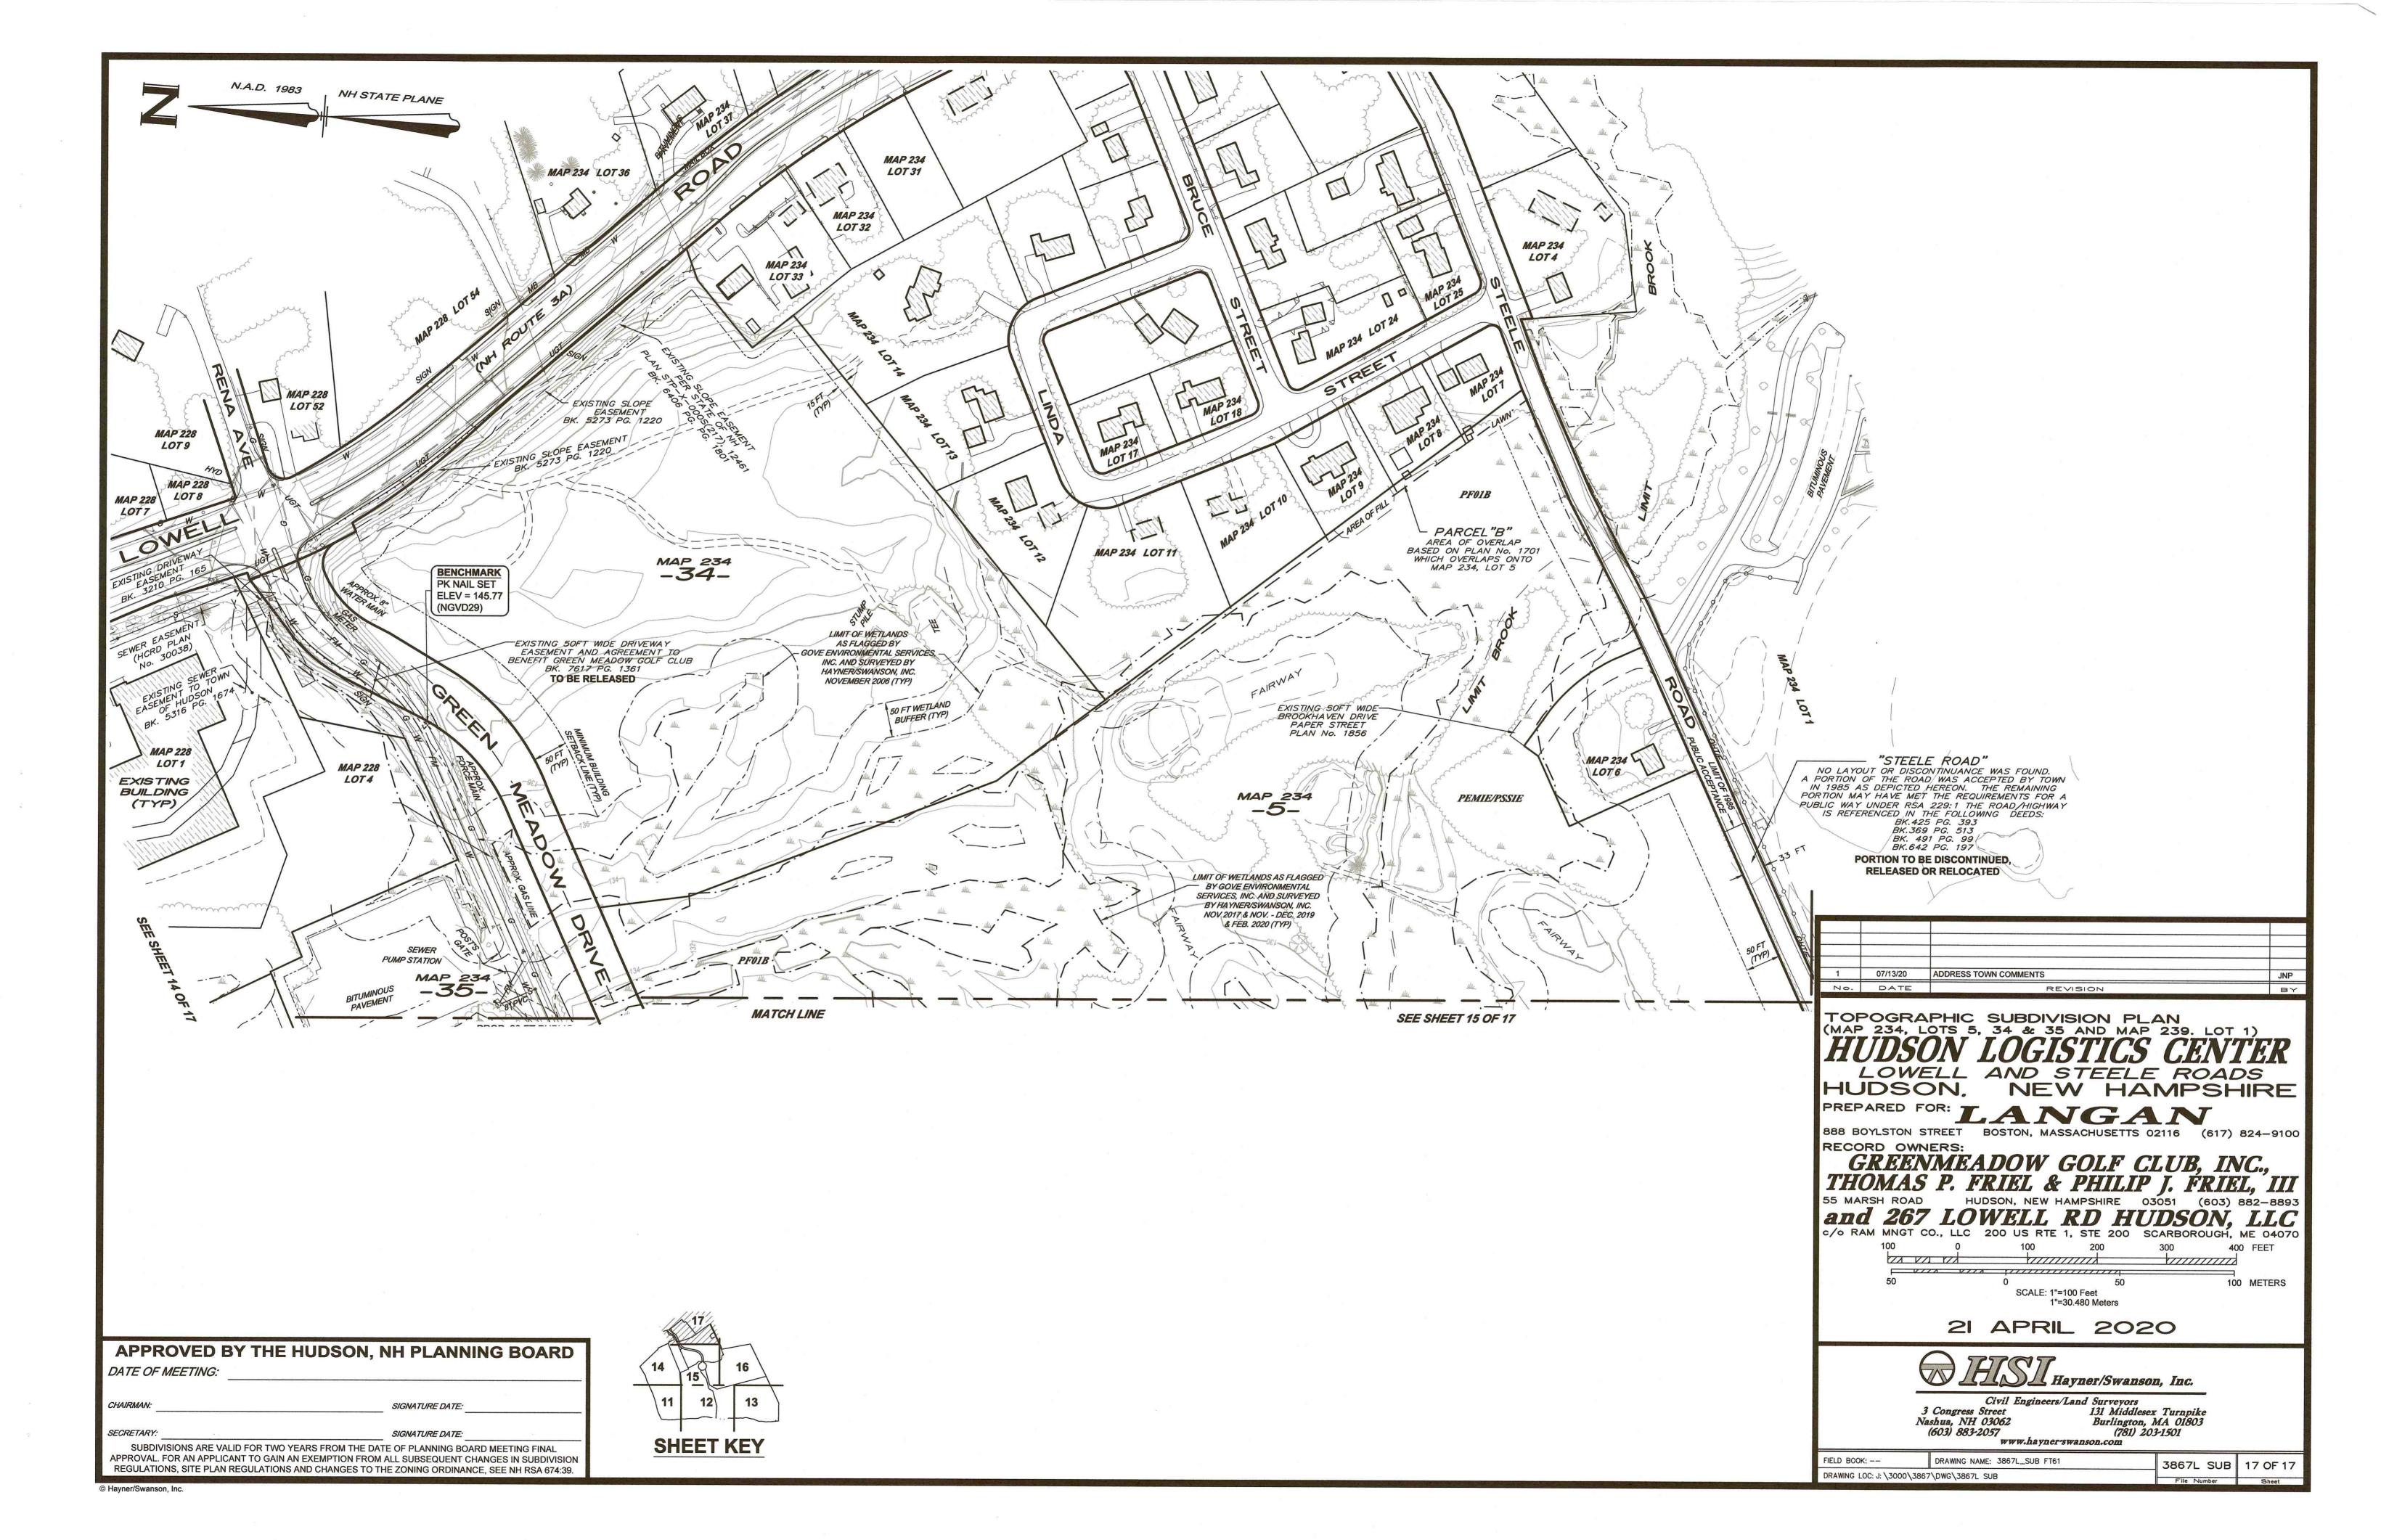

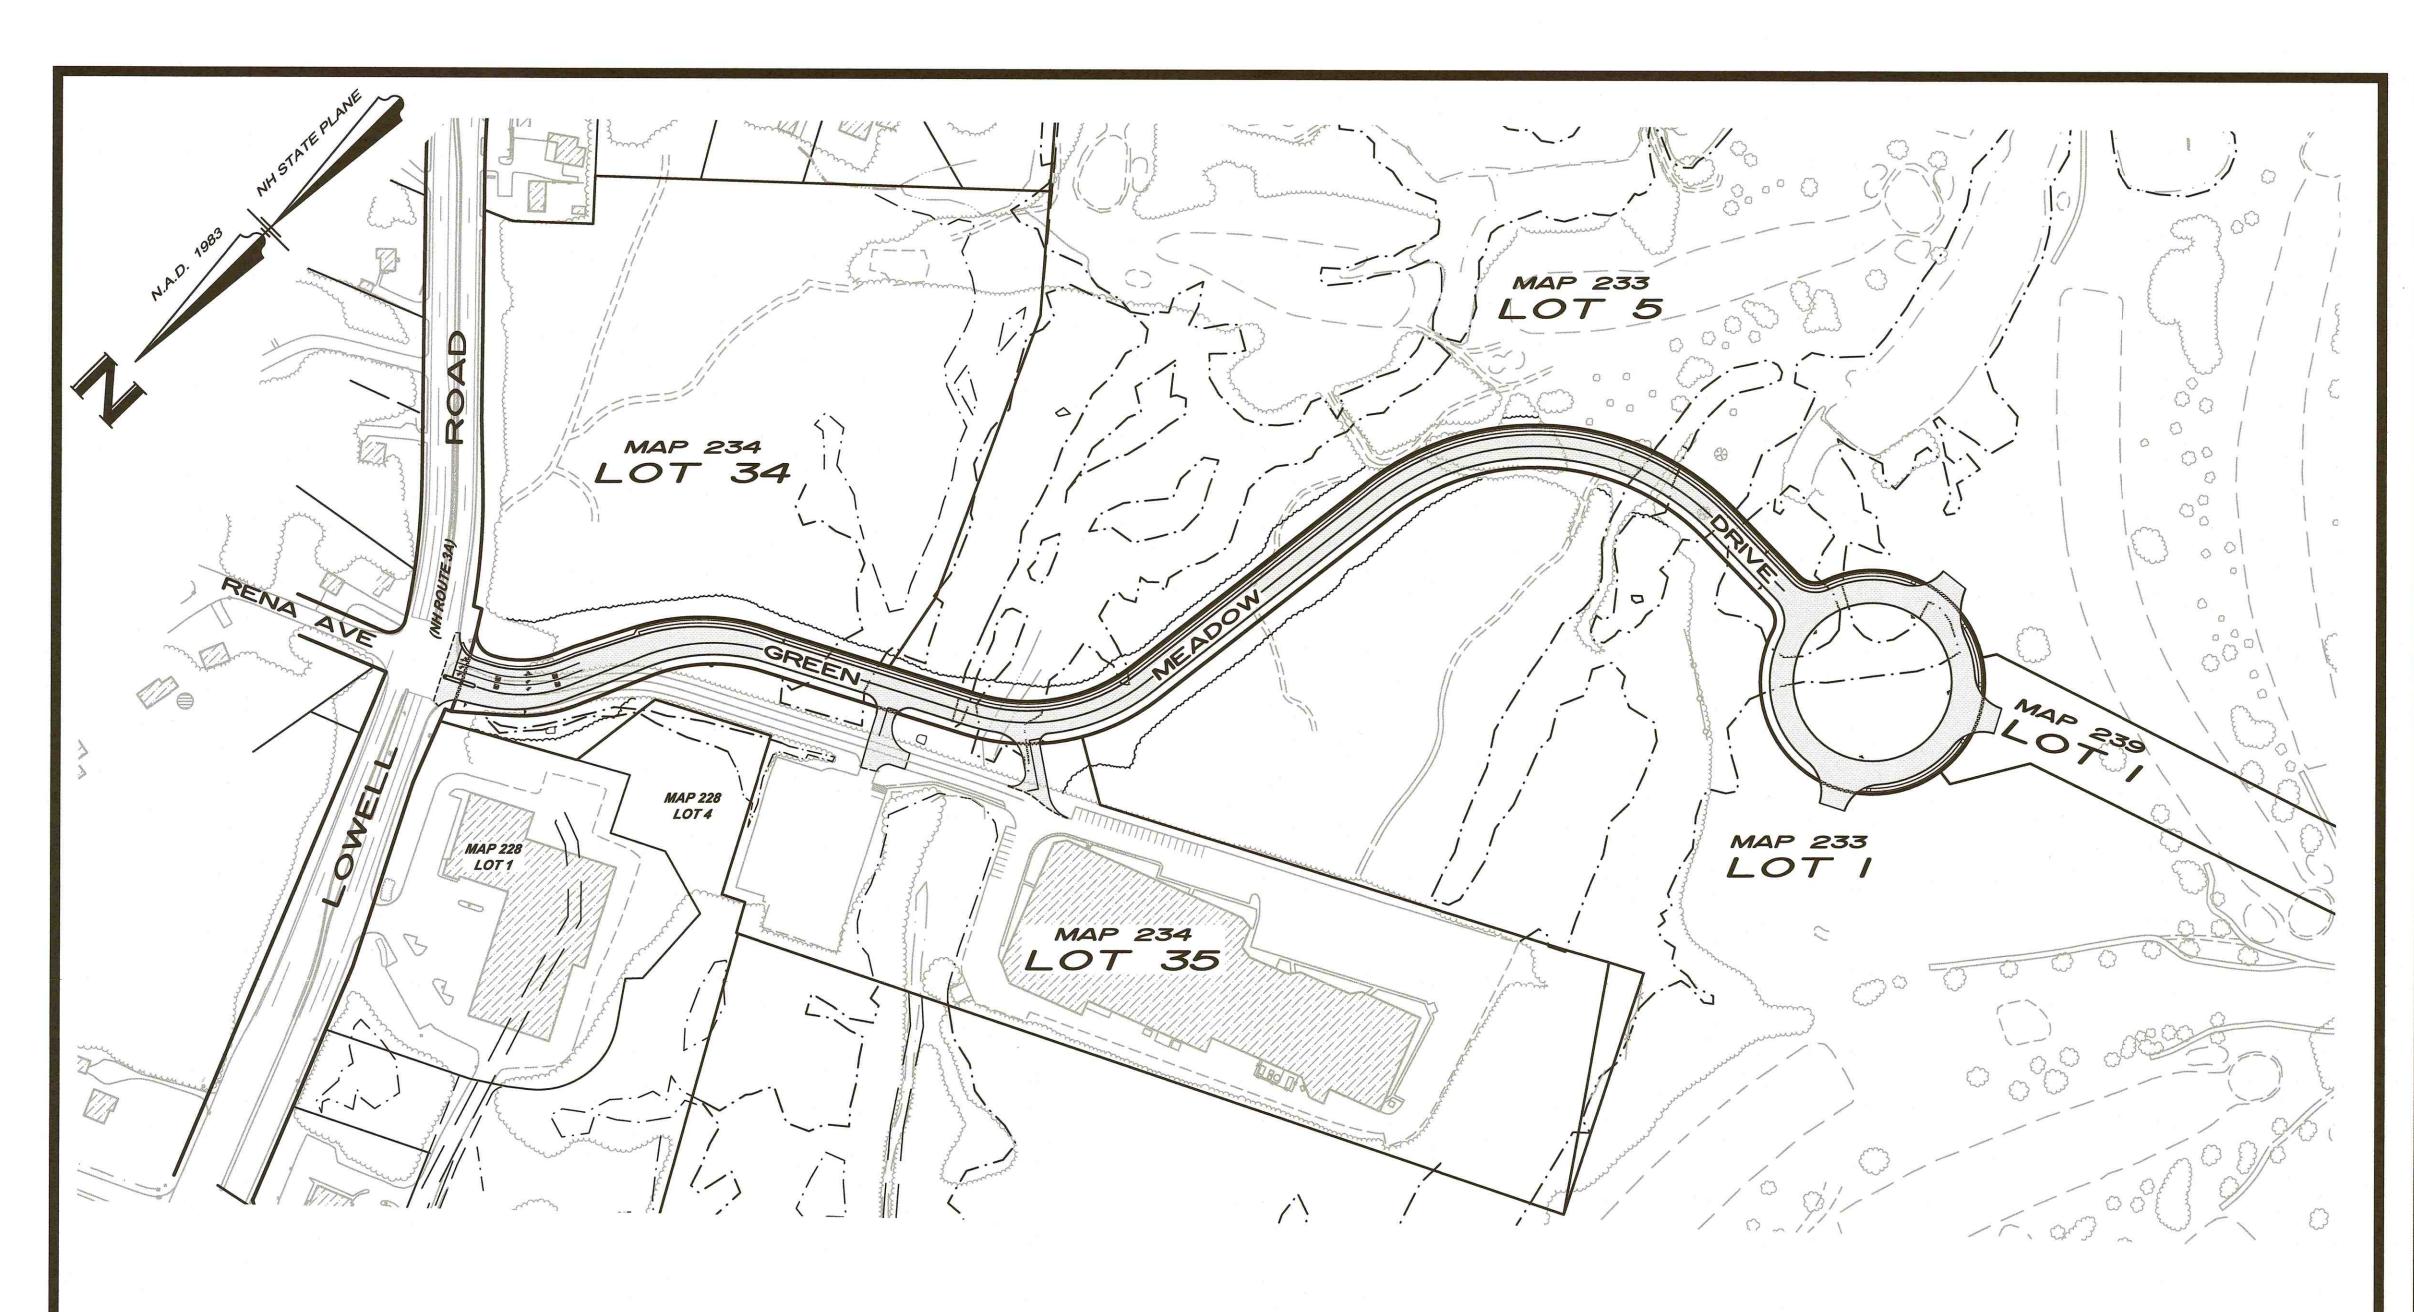


LEGEND

	EXISTING GROUND CONTOUR		STONE BOUND TO BE SET
x100.5	EXISTING SPOT ELEVATION	•	IRON PIN TO BE SET
100	PROPOSED GRADE	├ TBM 1	TEMPORARY BENCHMARK
+100.5	PROPOSED SPOT GRADE		WETLAND FLAGGING LIMIT
= ====	STORM DRAIN & CATCH BASIN		WETLAND BUFFER LINE
=====	STORM DRAIN & MANHOLE	—×——×—	WIRE FENCE
= $=$ $($	STORM DRAIN & HEADWALL		CHAINLINK FENCE
$ = = \overset{v}{=} $	STORM DRAIN & END SECTION		CURBING
S(c)	SANITARY SEWER & MANHOLE		VERTICAL GRANITE CURBING
-W(d)	WATER MAIN & HYDRANT		SLOPE GRANITE CURBING
-W(b)	WATER MAIN & GATE VALVE	~ ~ ~ ~ ~ ~ ~	GUARDRAIL
- <i>G(b)</i> ^G G	GAS LINE & GATE VALVE		PAVEMENT SAWCUT
€φ	UTILITY POLE WITH GUY SUPPORT		
-0 *	STREET LIGHT	The state of the s	PROPOSED FULL-DEPTH PAVEMI
OHW	OVERHEAD ELECTRIC & TELEPHONE		RIPRAP / STONE
-©— <i>UGW(c)</i> ————————————————————————————————————	UNDERGROUND ELEC/TEL & MANHOLES	RECEIVED	111111111111111111111111111111111111111
	SIGN		WETLAND IMPACT AREA
$\sim\sim$	TREE LINE	20+00	CENTER LINE STATIONING
			LIMIT OF WORK

INTERSECTION SIGHT DISTANCE FOR PROPOSED DRIVEWAYS

LOCATION	LOOKING LEFT	LOOKING RIGHT
MAP 234 LOT 35 (EAST)	285 FT	340 FT
MAP 234 LOT 35 (WEST)	400+ FT	400+ FT
MAP 233 LOT 1 *	310+ FT	NA
MAP 239 LOT 1 *	285+ FT	N/A
MAP 234 LOT 5 *	290+ FT	N/A

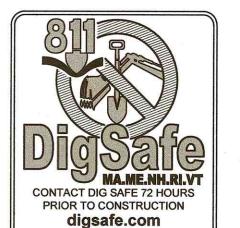* LOOKING LEFT ALONG GREEN MEADOW DRIVE CUL-DE-SAC. INTERSECTION SIGHT DISTANCE MEASUREMENTS WERE PERFORMED IN ACCORDANCE WITH U.S. DEPARTMENT OF TRANSPORTATION FEDERAL HIGHWAY ADMINISTRATION "ROUNDABOUTS, AN INFORMATIONAL GUIDE'



DIAL 811 or

1-888-DIG-SAFE

1-888-344-7233

PLAN REFERENCE:

SITE PLAN (166 SHEETS) HUDSON LOGISTICS CENTER, HUDSON, NH, PREPARED FOR HILL WOOD ALLENTOWN, PA, PREPARED BY LANGAN, BOSTON, MA, DATED: 21 APRIL 2020 WITH REVISIONS THRU

TOWN OF HUDSON CONTACTS PLANNING DEPARTMENT HUDSON PLANNING DEPT. 12 SCHOOL STREET HUDSON, NH 03051 ATT: BRIAN GROTH, AICP LAND USE DIRECTOR (603) 886-6008 **ENGINEERING DEPARTMENT** 12 SCHOOL STREET

HUDSON ENGINEERING DEPT. HUDSON, NH 03051 ATT: ELVIS DHIMA, P.E. TOWN ENGINEER (603) 886-6008

FIRE DEPARTMENT HUDSON FIRE DEPARTMENT 12 SCHOOL STREET HUDSON, NH 03051 ATT: ROBERT BUXTON, FIRE CHIEF (603) 886-6021

UTILITY CONTACTS

LIBERTY UTILITIES 130 ELM STREET MANCHESTER, NH 03103 ATT: ANDREW MORGAN (603) 327-5357

(603) 296-5998

TELEPHONE: CONSOLIDATED COMMUNICATIONS 257 DANIEL WEBSTER HIGHWAY MERRIMACK, NH 03054 ATT: HEATHER ARUJUO

POWER: **EVERSOURCE** 370 AMHERST STREET NASHUA, NH 03060 ATT: MARC GAGNON (603) 882-5894

SURVEY NOTES:

- THE EXISTING TOPOGRAPHY, AS SHOWN ON THE PLANS, IS BASED ON AERIAL PHOTO MAPPING IN 2001 AND LIMITED FIELD TOPOGRAPHY MADE ON THE GROUND BETWEEN MARCH 2004 AND
- IT SHALL BE THE CONTRACTOR'S RESPONSIBILITY TO VERIFY THE ACCURACY OF THE EXISTING TOPOGRAPHY PRIOR TO EARTHWORK OPERATIONS. NO CLAIM FOR EXTRA WORK DUE TO TOPOGRAPHIC INACCURACY SHALL BE CONSIDERED AFTER EARTHWORK HAS COMMENCED.

SURVEY CONTROL DATA: HORIZONTAL DATUM:

HORIZONTAL PROJECTION: NH STÀTE PLANE VERTICAL DATUM: NGVD29 US SURVEY FEET

GENERAL NOTES

- ALL WORK SHALL CONFORM TO THE APPLICABLE REGULATIONS AND STANDARDS OF THE TOWN OF HUDSON AND SHALL BE BUILT IN A WORKMANLIKE MANNER IN ACCORDANCE WITH THE PLANS AND DETAILS. THE STANDARD SPECIFICATION FOR ROAD AND BRIDGE CONSTRUCTION, STATE OF NEW HAMPSHIRE, DEPARTMENT OF TRANSPORTATION, LATEST EDITION AND THE TOWN OF HUDSON ENGINEERING DEPARTMENT, ENGINEERING TECHNICAL GUIDELINES & TYPICAL DETAILS, LATEST EDITION ARE HEREBY INCORPORATED BY REFERENCE.
 - THE CONTRACTOR SHALL BE RESPONSIBLE FOR VERIFYING AND DETERMINING THE LOCATION. SIZE AND ELEVATION OF ALL EXISTING UTILITIES, SHOWN OR NOT SHOWN ON THESE PLANS, PRIOR TO THE START OF ANY CONSTRUCTION. THE ENGINEER SHALL BE NOTIFIED IN WRITING OF ANY UTILITIES FOUND INTERFERING WITH THE PROPOSED CONSTRUCTION, AND APPROPRIATE REMEDIAL ACTION TAKEN BEFORE PROCEEDING WITH THE WORK.
- THE CONTRACTOR IS RESPONSIBLE FOR THE MEANS AND METHODS OF CONSTRUCTION AND FOR CONDITIONS AT THE SITE. THESE PLANS, PREPARED BY HSI, DO NOT EXTEND TO OR INCLUDE SYSTEMS PERTAINING TO THE SAFETY OF THE CONTRACTOR OR THEIR EMPLOYEES, AGENTS OR REPRESENTATIVES IN THE PERFORMANCE OF THE WORK. THE CONTRACTOR SHALL PREPARE OR OBTAIN THE APPROPRIATE SAFETY SYSTEMS WHICH MAY BE REQUIRED BY THE U.S. OCCUPATIONAL SAFETY AND HEALTH ADMINISTRATION (OSHA) AND/OR LOCAL
- IT SHALL BE THE CONTRACTOR'S RESPONSIBILITY TO FAMILIARIZE HIMSELF/HERSELF WITH THE SITE AND ALL EXISTING CONDITIONS SURROUNDING IT AND THEREON.
- THE CONTRACTOR SHALL NOTIFY DIG SAFE AT 1-888-344-7233 A MINIMUM OF 72 HOURS PRIOR TO BEGINNING CONSTRUCTION. THE CONTRACTOR SHALL REPAIR, AT HIS/HER OWN EXPENSE, ANY UNDERGROUND CABLES OR UTILITIES DAMAGED BY HIS/HER OPERATIONS INCLUDING ANY DAMAGE DONE DRIVING HIS/HER EQUIPMENT OVER EXISTING UNDERGROUND CABLES OR
- TRAFFIC TO MERCURY SYSTEMS (MAP 234, LOT 35) MUST BE MAINTAINED AT ALL TIMES DURING CONSTRUCTION. THE CONTRACTOR SHALL PROVIDE SIGNAGE, BARRICADES AND FLAG PERSONS AS REQUIRED FOR TRAFFIC CONTROL. ALL CONSTRUCTION WARNING SIGNS MUST BE ERECTED PRIOR TO BEGINNING CONSTRUCTION.
- BLASTING, IF REQUIRED, SHALL BE PERFORMED BY A LICENSED BLASTING CONTRACTOR MEETING NHDOT AND TOWN OF HUDSON REQUIREMENTS. THE CONTRACTOR SHALL BE RESPONSIBLE FOR NOTIFICATION AND ALL COORDINATION WITH ALL AFFECTED UTILITIES PRIOR TO SCHEDULING BLASTING OPERATIONS.
- THE CONTRACTOR SHALL PROVIDE A MINIMUM OF 6" TOPSOIL AND SEED OVER ALL DISTURBED UNPAVED AREAS UNLESS OTHERWISE SPECIFIED.
- STUMPS SHALL BE DISPOSED OF OFF-SITE IN A LEGAL MANNER.
- ALL PAVEMENT CUTTING SHALL BE COMPLETED BY SAW-CUTTING ONLY. THE CONTRACTOR SHALL ENSURE A SMOOTH TRANSITION BETWEEN EXISTING AND PROPOSED PAVEMENT.
- LAYOUT OF THE PROPOSED IMPROVEMENTS INDICATED WITHIN THIS PROJECT SHALL BE CONDUCTED BY A LAND SURVEYOR LICENSED IN THE STATE OF NEW HAMPSHIRE, ALL MONUMENTATION TO BE SET OR AFFECTED BY THE PROJECT SHALL BE REMOVED AND RE-SET BY A LICENSED LAND SURVEYOR
- CONSTRUCTION HOURS ARE MONDAY THRU SATURDAY, 7:00 AM TO 7:00 PM, WITH NO CONSTRUCTION OCCURRING ON SUNDAYS. BLASTING, IF ANY, SHALL BE LIMITED TO 7:00 AM TO 5:00 PM MONDAY THRU FRIDAY ONLY. BLASTING OR RAMMING ROCK IS PROHIBITED ON
- ALL SIGNS ARE SUBJECT TO THE REQUIREMENTS OF THE HUDSON ZONING ORDINANCE AS DETERMINED DURING THE SIGN PERMIT APPLICATION PROCESS.
- ROADWAY LIGHTING SHALL CONFORM WITH THE APPLICABLE TOWN OF HUDSON REGULATIONS.
- IT SHALL BE UNLAWFUL TO MODIFY, CHANGE OR ALTER IMPROVEMENTS AS SHOWN ON THESE PLANS WITHOUT RECEIVING APPROVAL FROM THE TOWN OF HUDSON PLANNING BOARD.
- THE CONTRACTOR SHALL NOT IMPORT ANY FILL OVER THE AMOUNT OF TEN CUBIC YARDS CUMULATIVE TOTAL PER SOURCE TO ANY JOB SITE IN THE TOWN OF HUDSON WITHOUT SOILS TESTING VERIFYING THE ABSENCE OF ALL CONSTITUENTS OF CONCERN, AND WITHOUT PRIOR APPROVAL BY ENGINEERING DEPARTMENT STAFF. DOCUMENTATION SUCH AS TEST REPORTS, CERTIFICATIONS AND SIEVE ANALYZES OF FILL SHALL BE PROVIDED TO THE ENGINEERING DEPARTMENT FOR APPROVAL PRIOR TO TRANSPORTING THE MATERIAL TO HUDSON.

07/13/20	ADDRESS TOWN COMMENTS	JNP
DATE	REVISION	BY

MASTER PLAN - GREEN MEADOW DRIVE (MAP 234, LOTS 5, 34 & 35 AND MAP 239, LOT 1)
HUDSON LOGISTICS CENTER LOWELL AND STEELE ROADS HUDSON, NEW HAMPSHIRE

PREPARED FOR: LANGAN

888 BOYLSTON STREET BOSTON, MASSACHUSETTS 02116 (617) 824-9100

RECORD OWNERS:

GREENMEADOW GOLF CLUB, INC.,
THOMAS P. FRIEL & PHILIP J. FRIEL, III

55 MARSH ROAD HUDSON, NEW HAMPSHIRE 03051 (603) 882-8893 and 267 LOWELL RD HUDSON, LLC

c/o RAM MNGT CO., LLC 200 US RTE 1, STE 200 SCARBOROUGH, ME 04070 VIIA VIIA IIIIIIIIIIIII SCALE: 1"=150 Feet 1"=45.721 Meters

21 APRIL 2020



131 Middlesex Turnpike 3 Congress Street Nashua, NH 03062 Burlington, MA 01803 (781) 203-1501 (603) 883-2057 www.hayner-swanson.com

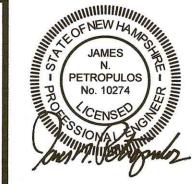
FIELD BOOK: --DRAWING NAME: 3867L-FQ81 1 OF 22 DRAWING LOC: J: \3000\3867\DWG\3867L SITE File Number

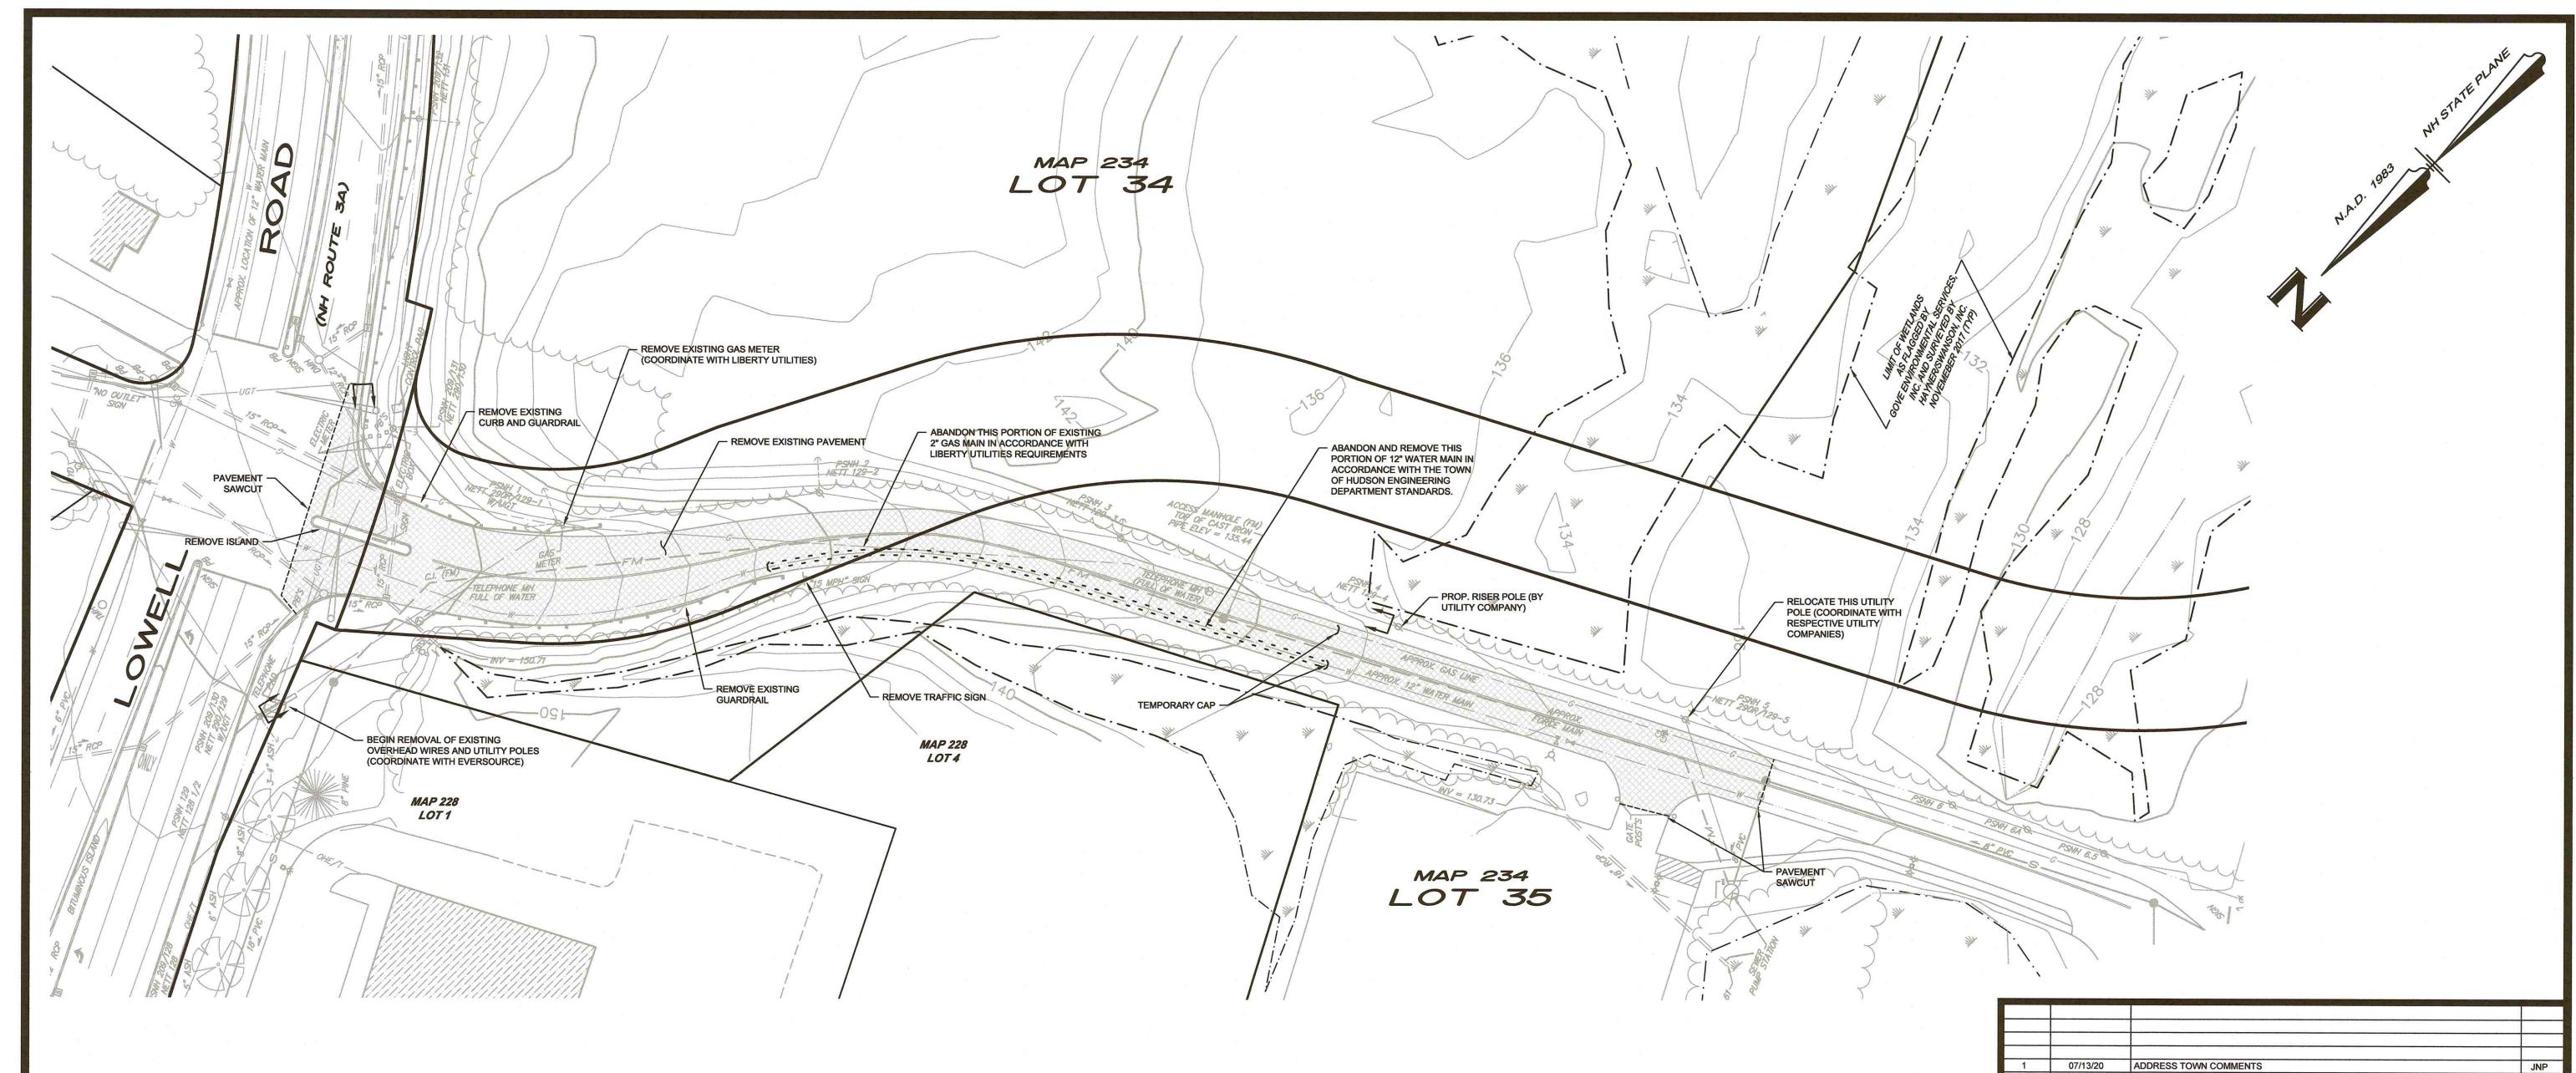
APPROVED BY THE HUDSON, NH PLANNING BOARD

SIGNATURE DATE: SECRETARY:

REGULATIONS, SITE PLAN REGULATIONS AND CHANGES TO THE ZONING ORDINANCE, SEE NH RSA 674:39.

DATE OF MEETING: **PETROPULOS** No. 10274 SIGNATURE DATE: SUBDIVISIONS ARE VALID FOR TWO YEARS FROM THE DATE OF PLANNING BOARD MEETING FINAL APPROVAL. FOR AN APPLICANT TO GAIN AN EXEMPTION FROM ALL SUBSEQUENT CHANGES IN SUBDIVISION





► UTILITY NOTE ◀

THE UNDERGROUND UTILITIES DEPICTED HEREON HAVE BEEN LOCATED FROM FIELD SURVEY INFORMATION AND PLOTTED FROM EXISTING DRAWINGS. THE SURVEYOR MAKES NO GUARANTEES THAT THE UNDERGROUND UTILITIES DEPICTED COMPRISE ALL SUCH UTILITIES IN THE AREA, EITHER IN SERVICE OR ABANDONED. THE SURVEYOR FURTHER DOES NOT WARRANT THAT THE UNDERGROUND UTILITIES SHOWN ARE IN THE EXACT LOCATION INDICATED ALTHOUGH THEY ARE LOCATED AS ACCURATELY AS POSSIBLE FROM THE INFORMATION AVAILABLE. THE SURVEYOR HAS NOT PHYSICALLY LOCATED THE UNDERGROUND PORTIONS OF THE UTILITIES.

APPROVED BY THE HUDSON, NH PLANNING BOARD DATE OF MEETING:

CHAIRMAN:


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SIGNATURE DATE:

PETROPULOS


No. 10274

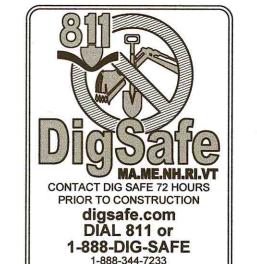SUBDIVISIONS ARE VALID FOR TWO YEARS FROM THE DATE OF PLANNING BOARD MEETING FINAL APPROVAL. FOR AN APPLICANT TO GAIN AN EXEMPTION FROM ALL SUBSEQUENT CHANGES IN SUBDIVISION REGULATIONS, SITE PLAN REGULATIONS AND CHANGES TO THE ZONING ORDINANCE, SEE NH RSA 674:39.



SITE DEMOLITION NOTES:

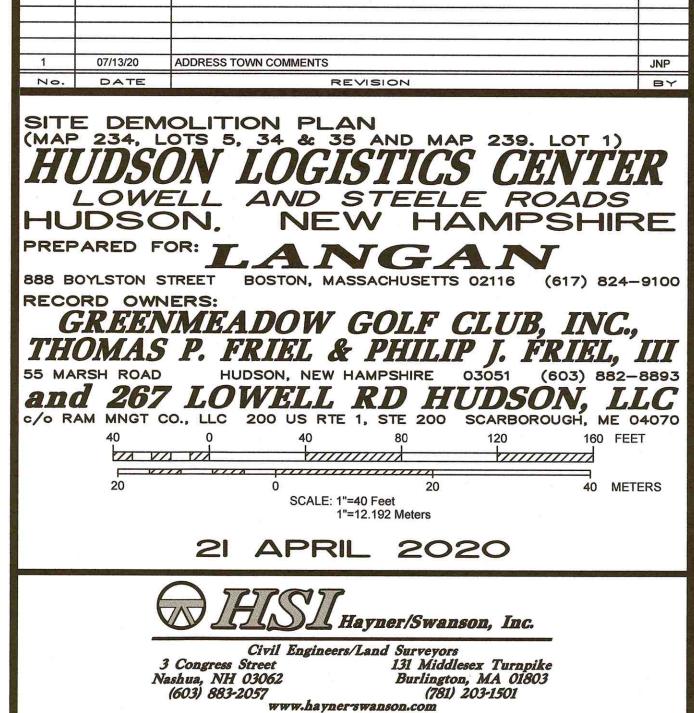- 1. THE CONTRACTOR IS RESPONSIBLE FOR THE DEMOLITION, REMOVAL, AND DISPOSAL IN A LOCATION APPROVED BY ALL GOVERNING AUTHORITIES, OF ALL STRUCTURES, PADS, WALLS, FOUNDATIONS, PARKING, DRIVES, DRAINAGE, STRUCTURES, UTILITIES, ETC., SUCH THAT THE IMPROVEMENTS SHOWN ON THE REMAINING PLANS CAN BE CONSTRUCTED. ALL FACILITIES TO BE REMOVED SHALL BE UNDERCUT TO SUITABLE MATERIAL AND BROUGHT TO GRADE WITH SUITABLE COMPACTED FILL MATERIAL PER THE GEOTECHNICAL SPECIFICATIONS.
- 2. THE CONTRACTOR IS RESPONSIBLE FOR REMOVING ALL DEBRIS FROM THE SITE AND DISPOSING THE DEBRIS IN A LAWFUL MANNER. THE CONTRACTOR IS RESPONSIBLE FOR OBTAINING ALL PERMITS REQUIRED FOR SITE DEMOLITION AND DISPOSAL.
- 3. THE CONTRACTOR SHALL COORDINATE WITH RESPECTIVE UTILITY COMPANIES PRIOR TO THE REMOVAL AND/OR RELOCATION OF UTILITIES. THE CONTRACTOR SHALL COORDINATE WITH THE UTILITY COMPANY CONCERNING PORTIONS OF WORK WHICH MAY BE PERFORMED BY THE UTILITY COMPANY'S FORCES AND ANY FEES WHICH ARE TO BE PAID TO THE UTILITY COMPANY FOR THEIR SERVICES. THE CONTRACTOR IS RESPONSIBLE FOR PAYING ALL FEES AND CHARGES
- THE LOCATIONS OF ALL EXISTING UTILITIES SHOWN ON THIS PLAN HAVE BEEN DETERMINED FROM THE BEST INFORMATION AVAILABLE AND ARE GIVEN FOR THE CONVENIENCE OF THE CONTRACTOR. THE ENGINEER ASSUMES NO RESPONSIBILITY FOR THEIR ACCURACY. PRIOR TO THE START OF ANY DEMOLITION ACTIVITY, THE CONTRACTOR SHALL NOTIFY THE UTILITY COMPANIES FOR ON SITE LOCATIONS OF EXISTING UTILITIES.
- 5. ALL EXISTING SEWERS, PIPING AND UTILITIES SHOWN ARE NOT TO BE INTERPRETED AS THE EXACT LOCATION, OR AS THE ONLY OBSTACLES THAT MAY OCCUR ON THE SITE. THE CONTRACTOR SHALL VERIFY EXISTING CONDITIONS AND PROCEED WITH CAUTION AROUND ANY ANTICIPATED FEATURES. THE CONTRACTOR SHALL GIVE NOTICE TO ALL UTILITY COMPANIES REGARDING DESTRUCTION AND REMOVAL OF ALL SERVICE LINES AND CAP ALL LINES BEFORE PROCEEDING WITH THE WORK.
- ELECTRICAL, TELEPHONE, CABLE, WATER, FIBER OPTIC CABLE AND/OR GAS LINES NEEDING TO BE REMOVED OR RELOCATED SHALL BE COORDINATED WITH THE AFFECTED UTILITY COMPANY. ADEQUATE TIME SHALL BE PROVIDED FOR RELOCATION AND CLOSE COORDINATION WITH THE UTILITY COMPANY IS NECESSARY TO PROVIDE A SMOOTH TRANSITION IN UTILITY SERVICE. THE CONTRACTOR SHALL PAY CLOSE ATTENTION TO EXISTING UTILITIES WITHIN THE ROAD RIGHT OF WAY DURING CONSTRUCTION.
- PRIOR TO SITE DEMOLITION OCCURRING, ALL APPROPRIATE EROSION CONTROL DEVICES ARE TO BE INSTALLED.
- 8. FOR ANY WORK WITHIN A PUBLIC STREET THE CONTRACTOR SHALL SUBMIT A TRAFFIC CONTROL PLAN TO THE TOWN OF HUDSON ENGINEERING DEPARTMENT



3867L

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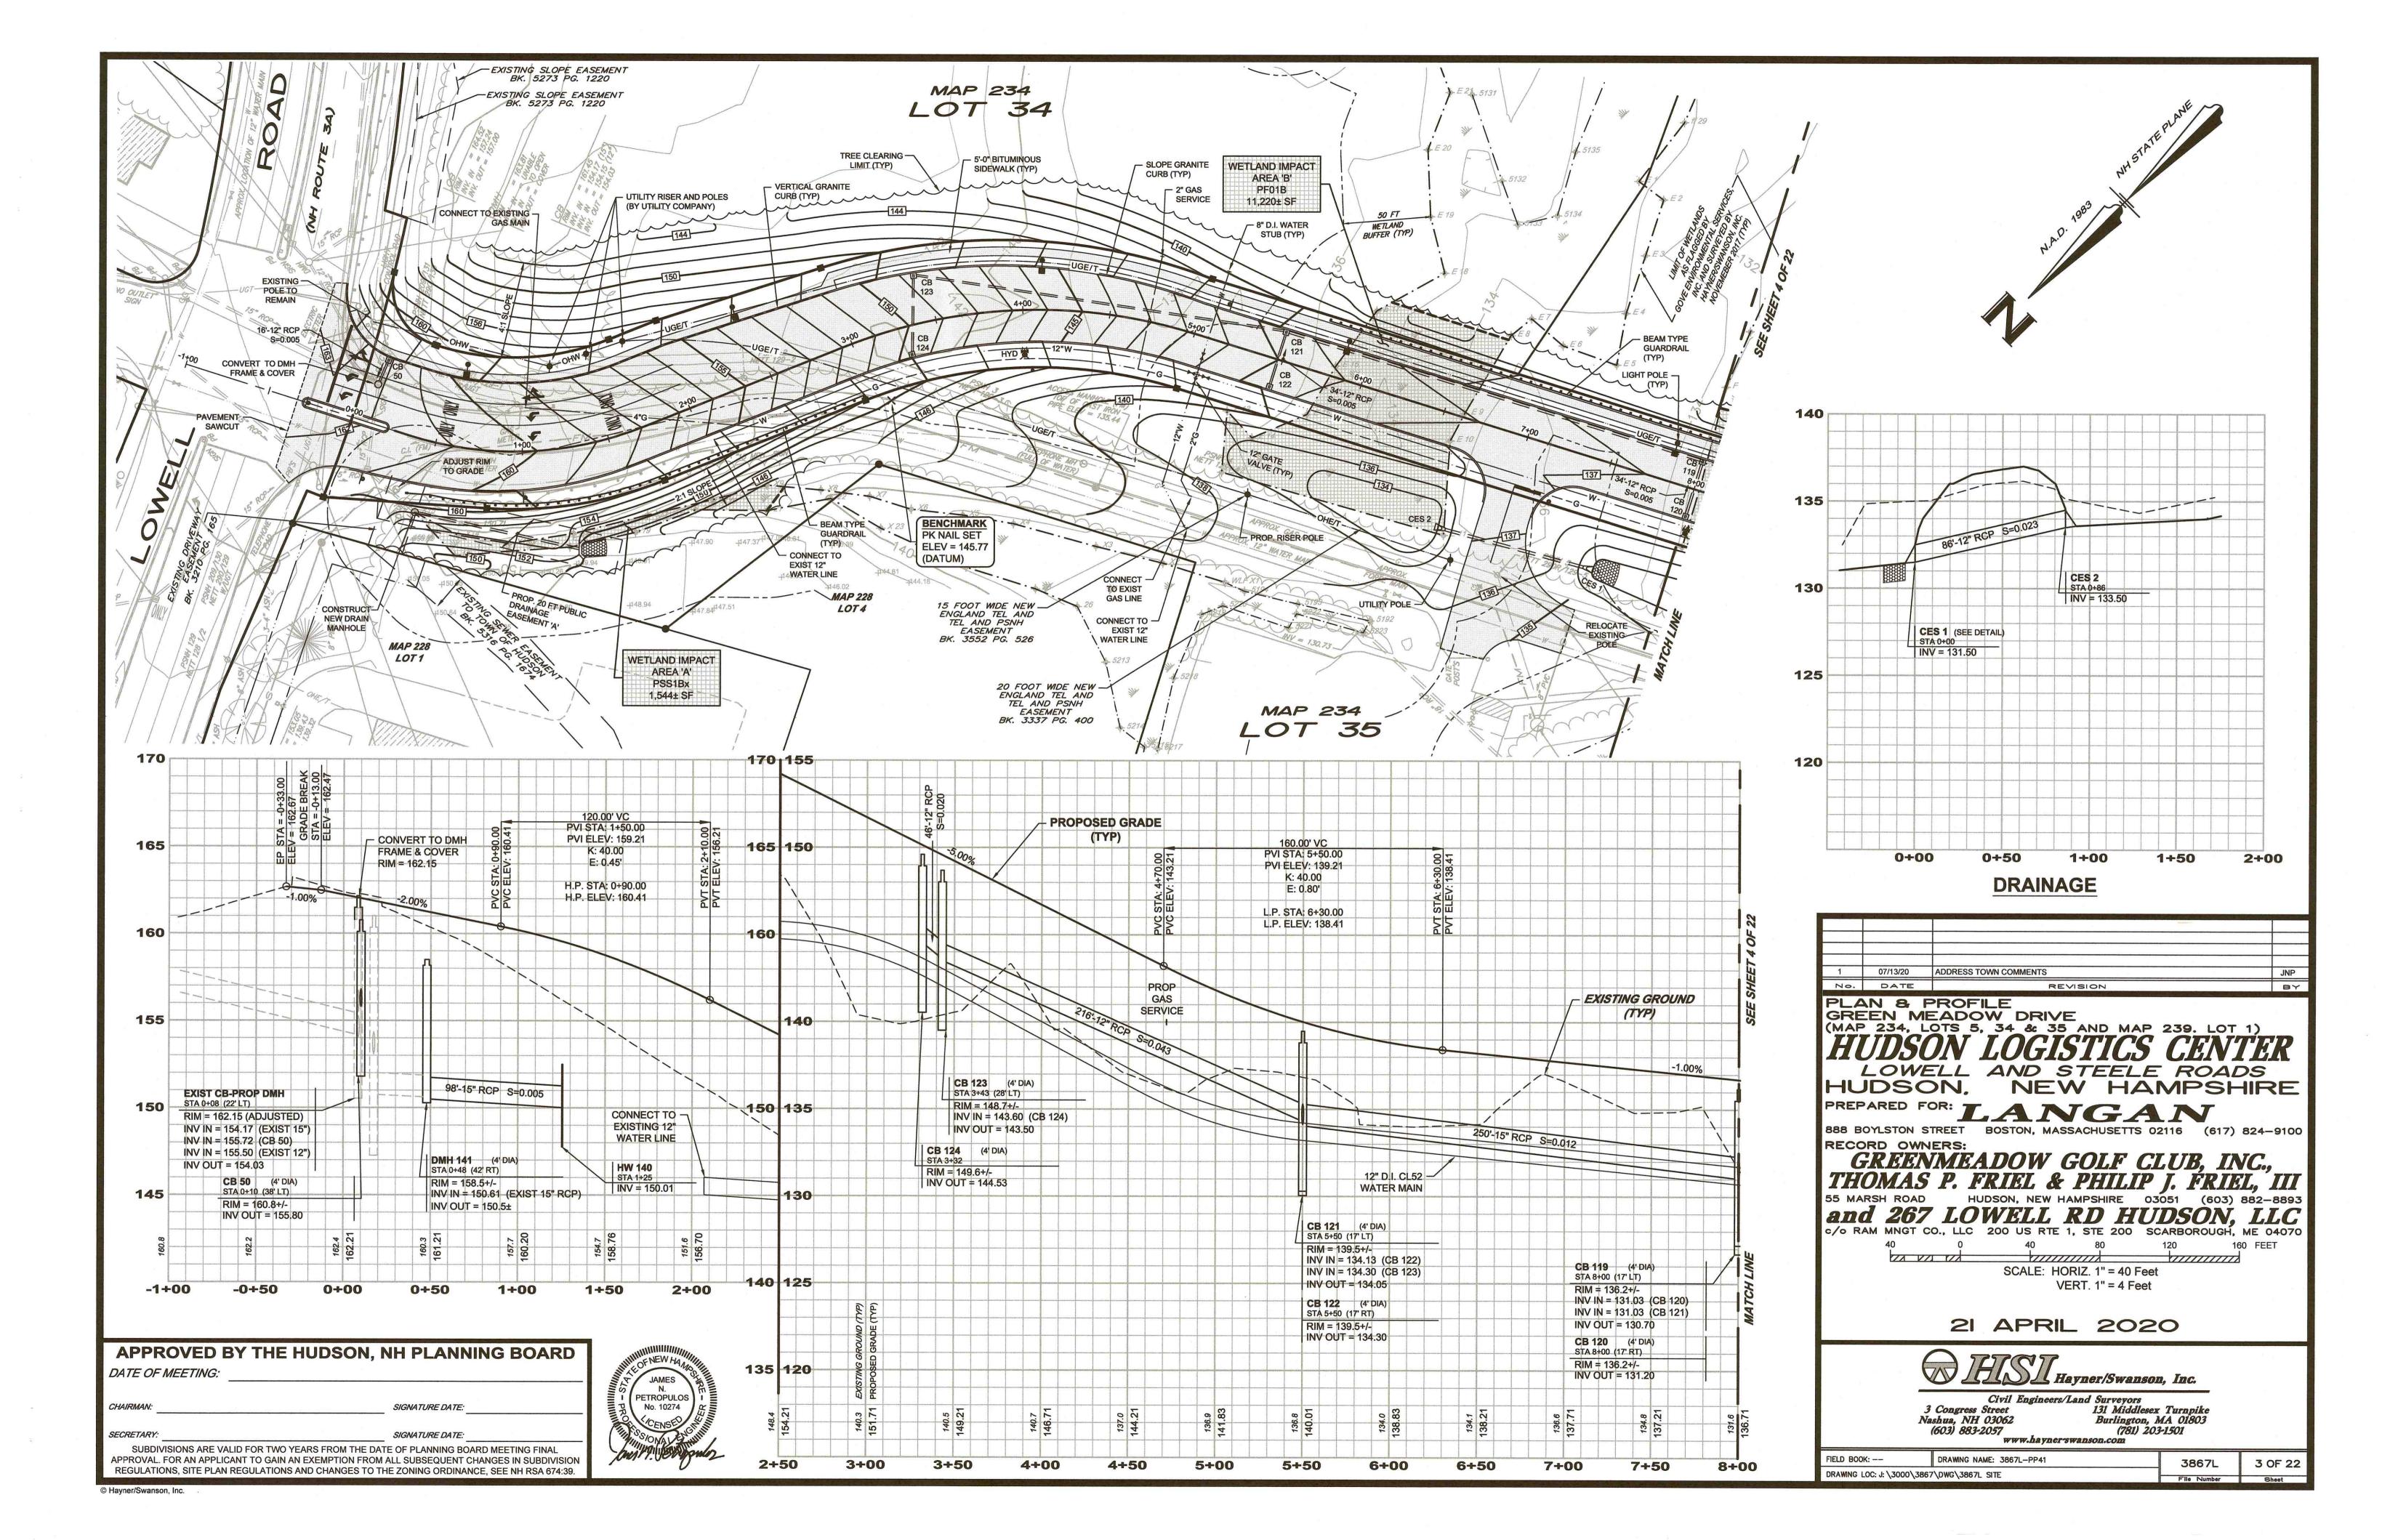
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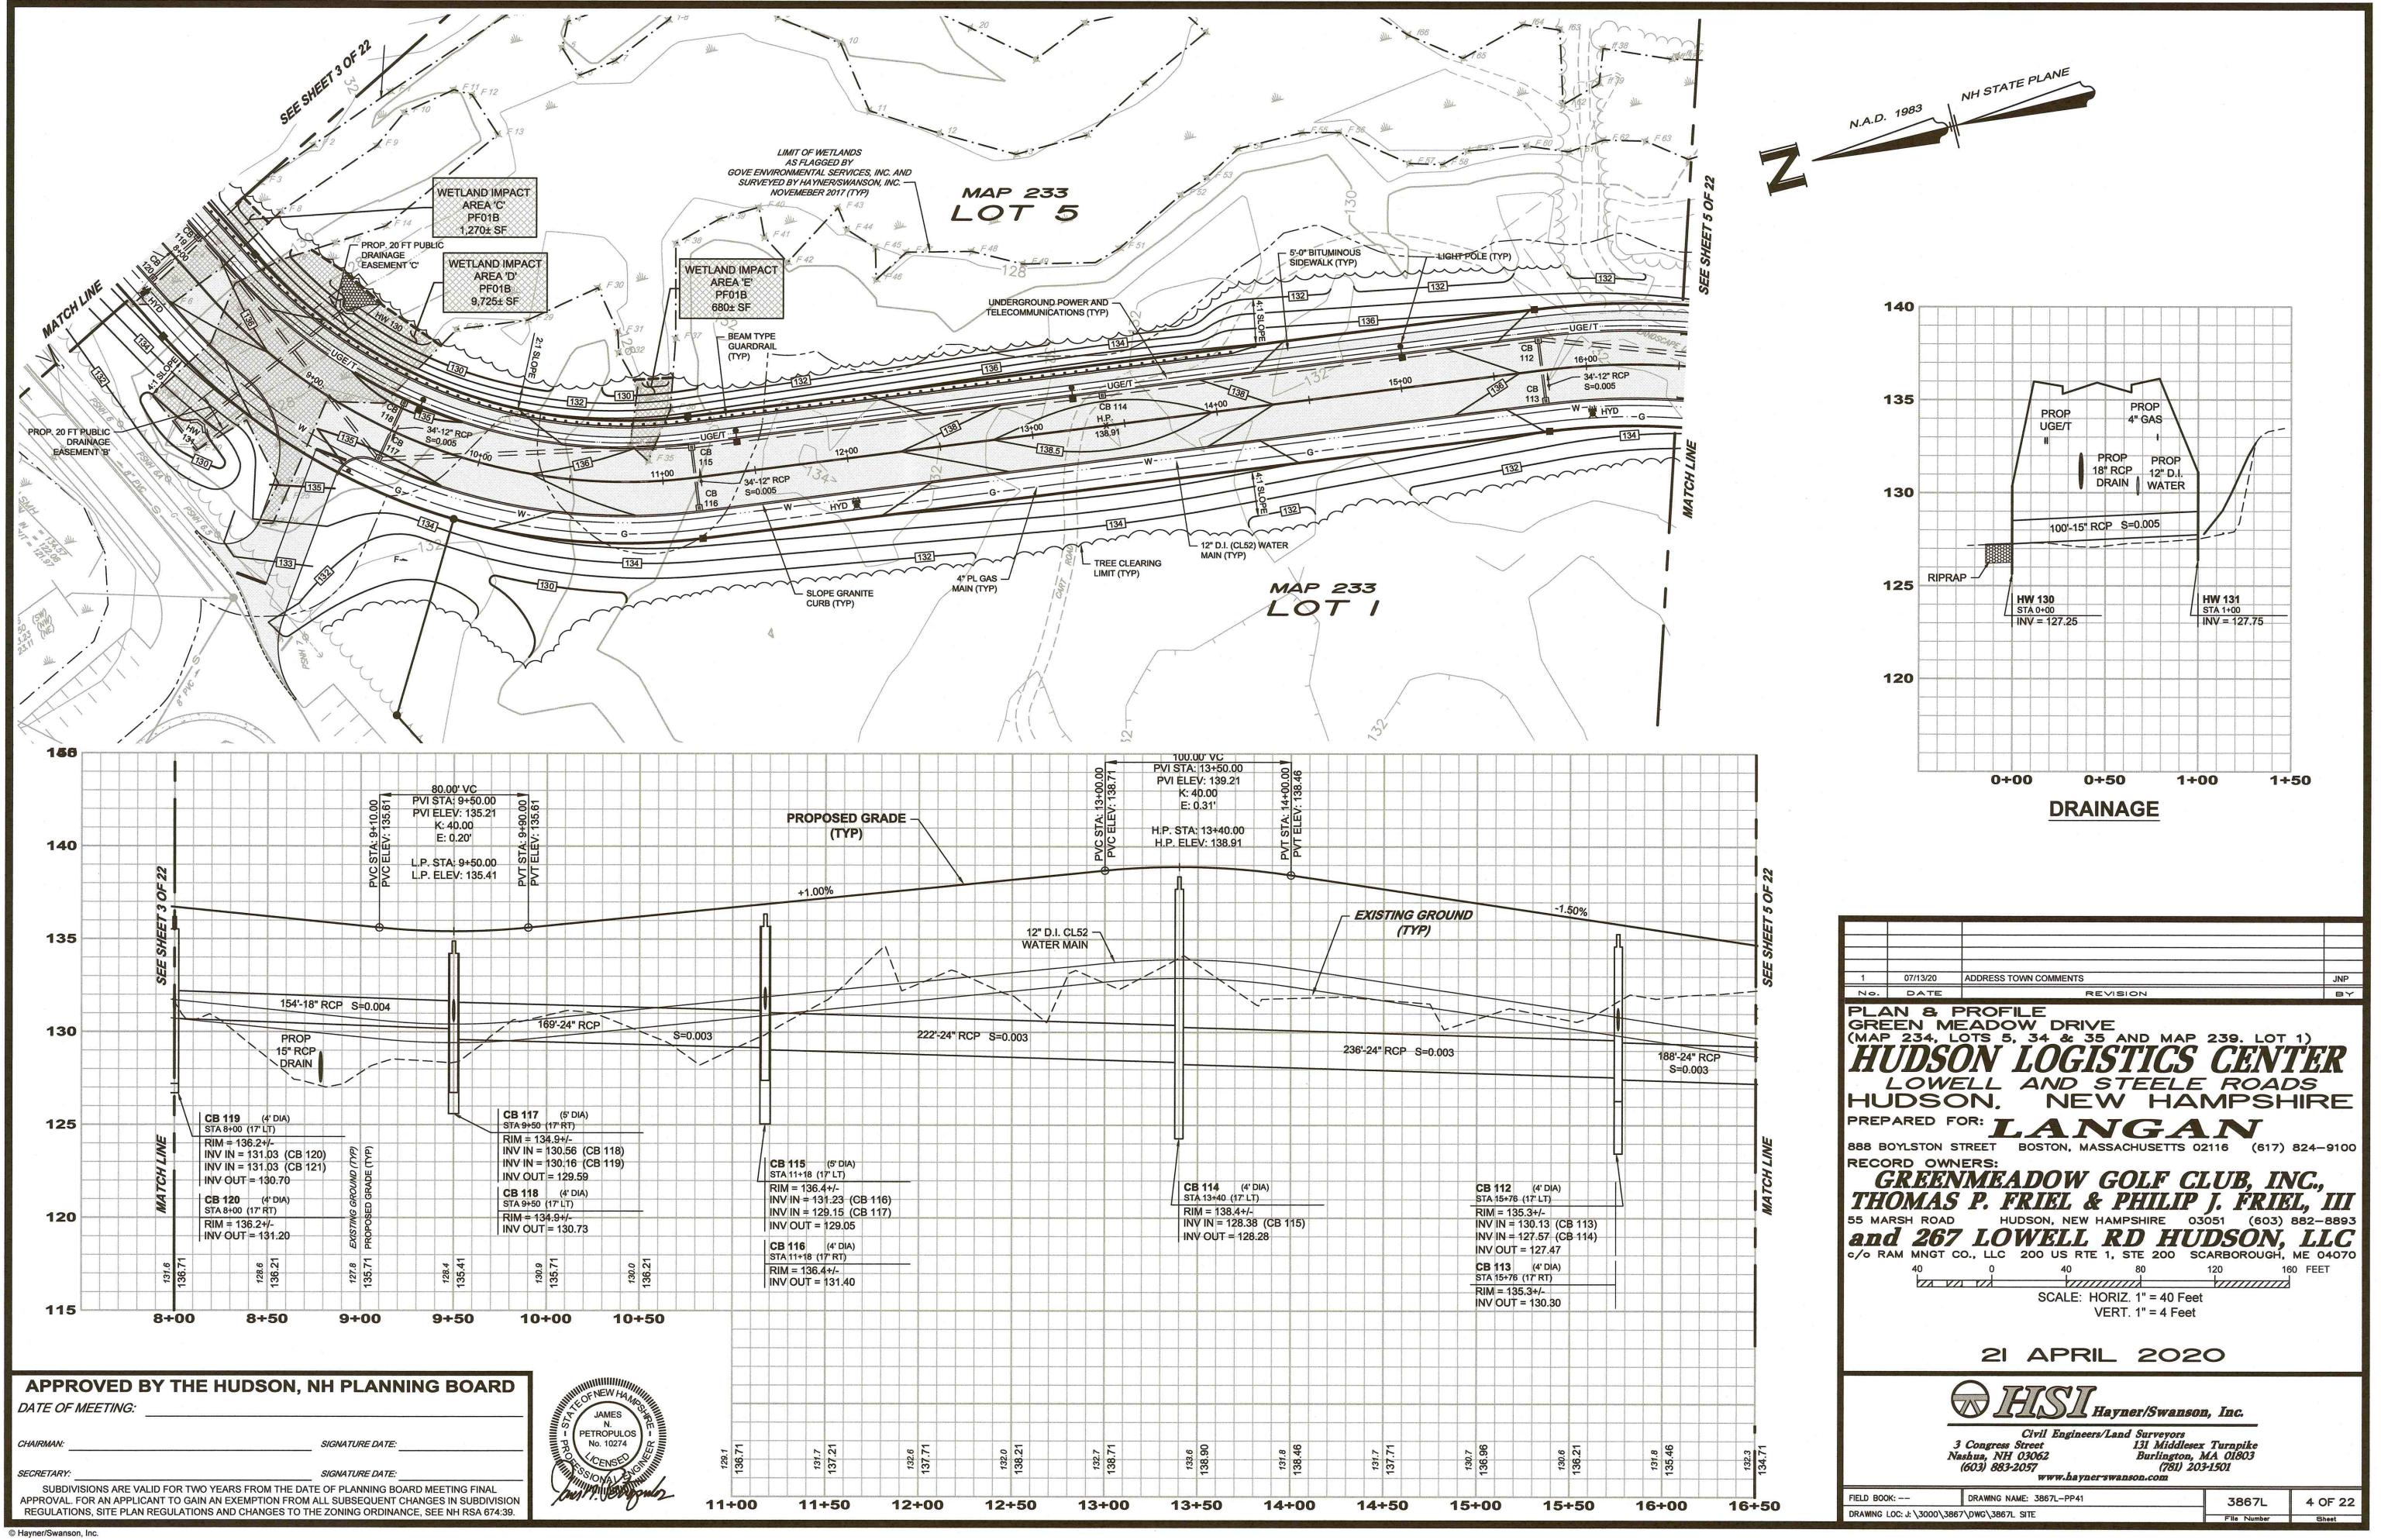
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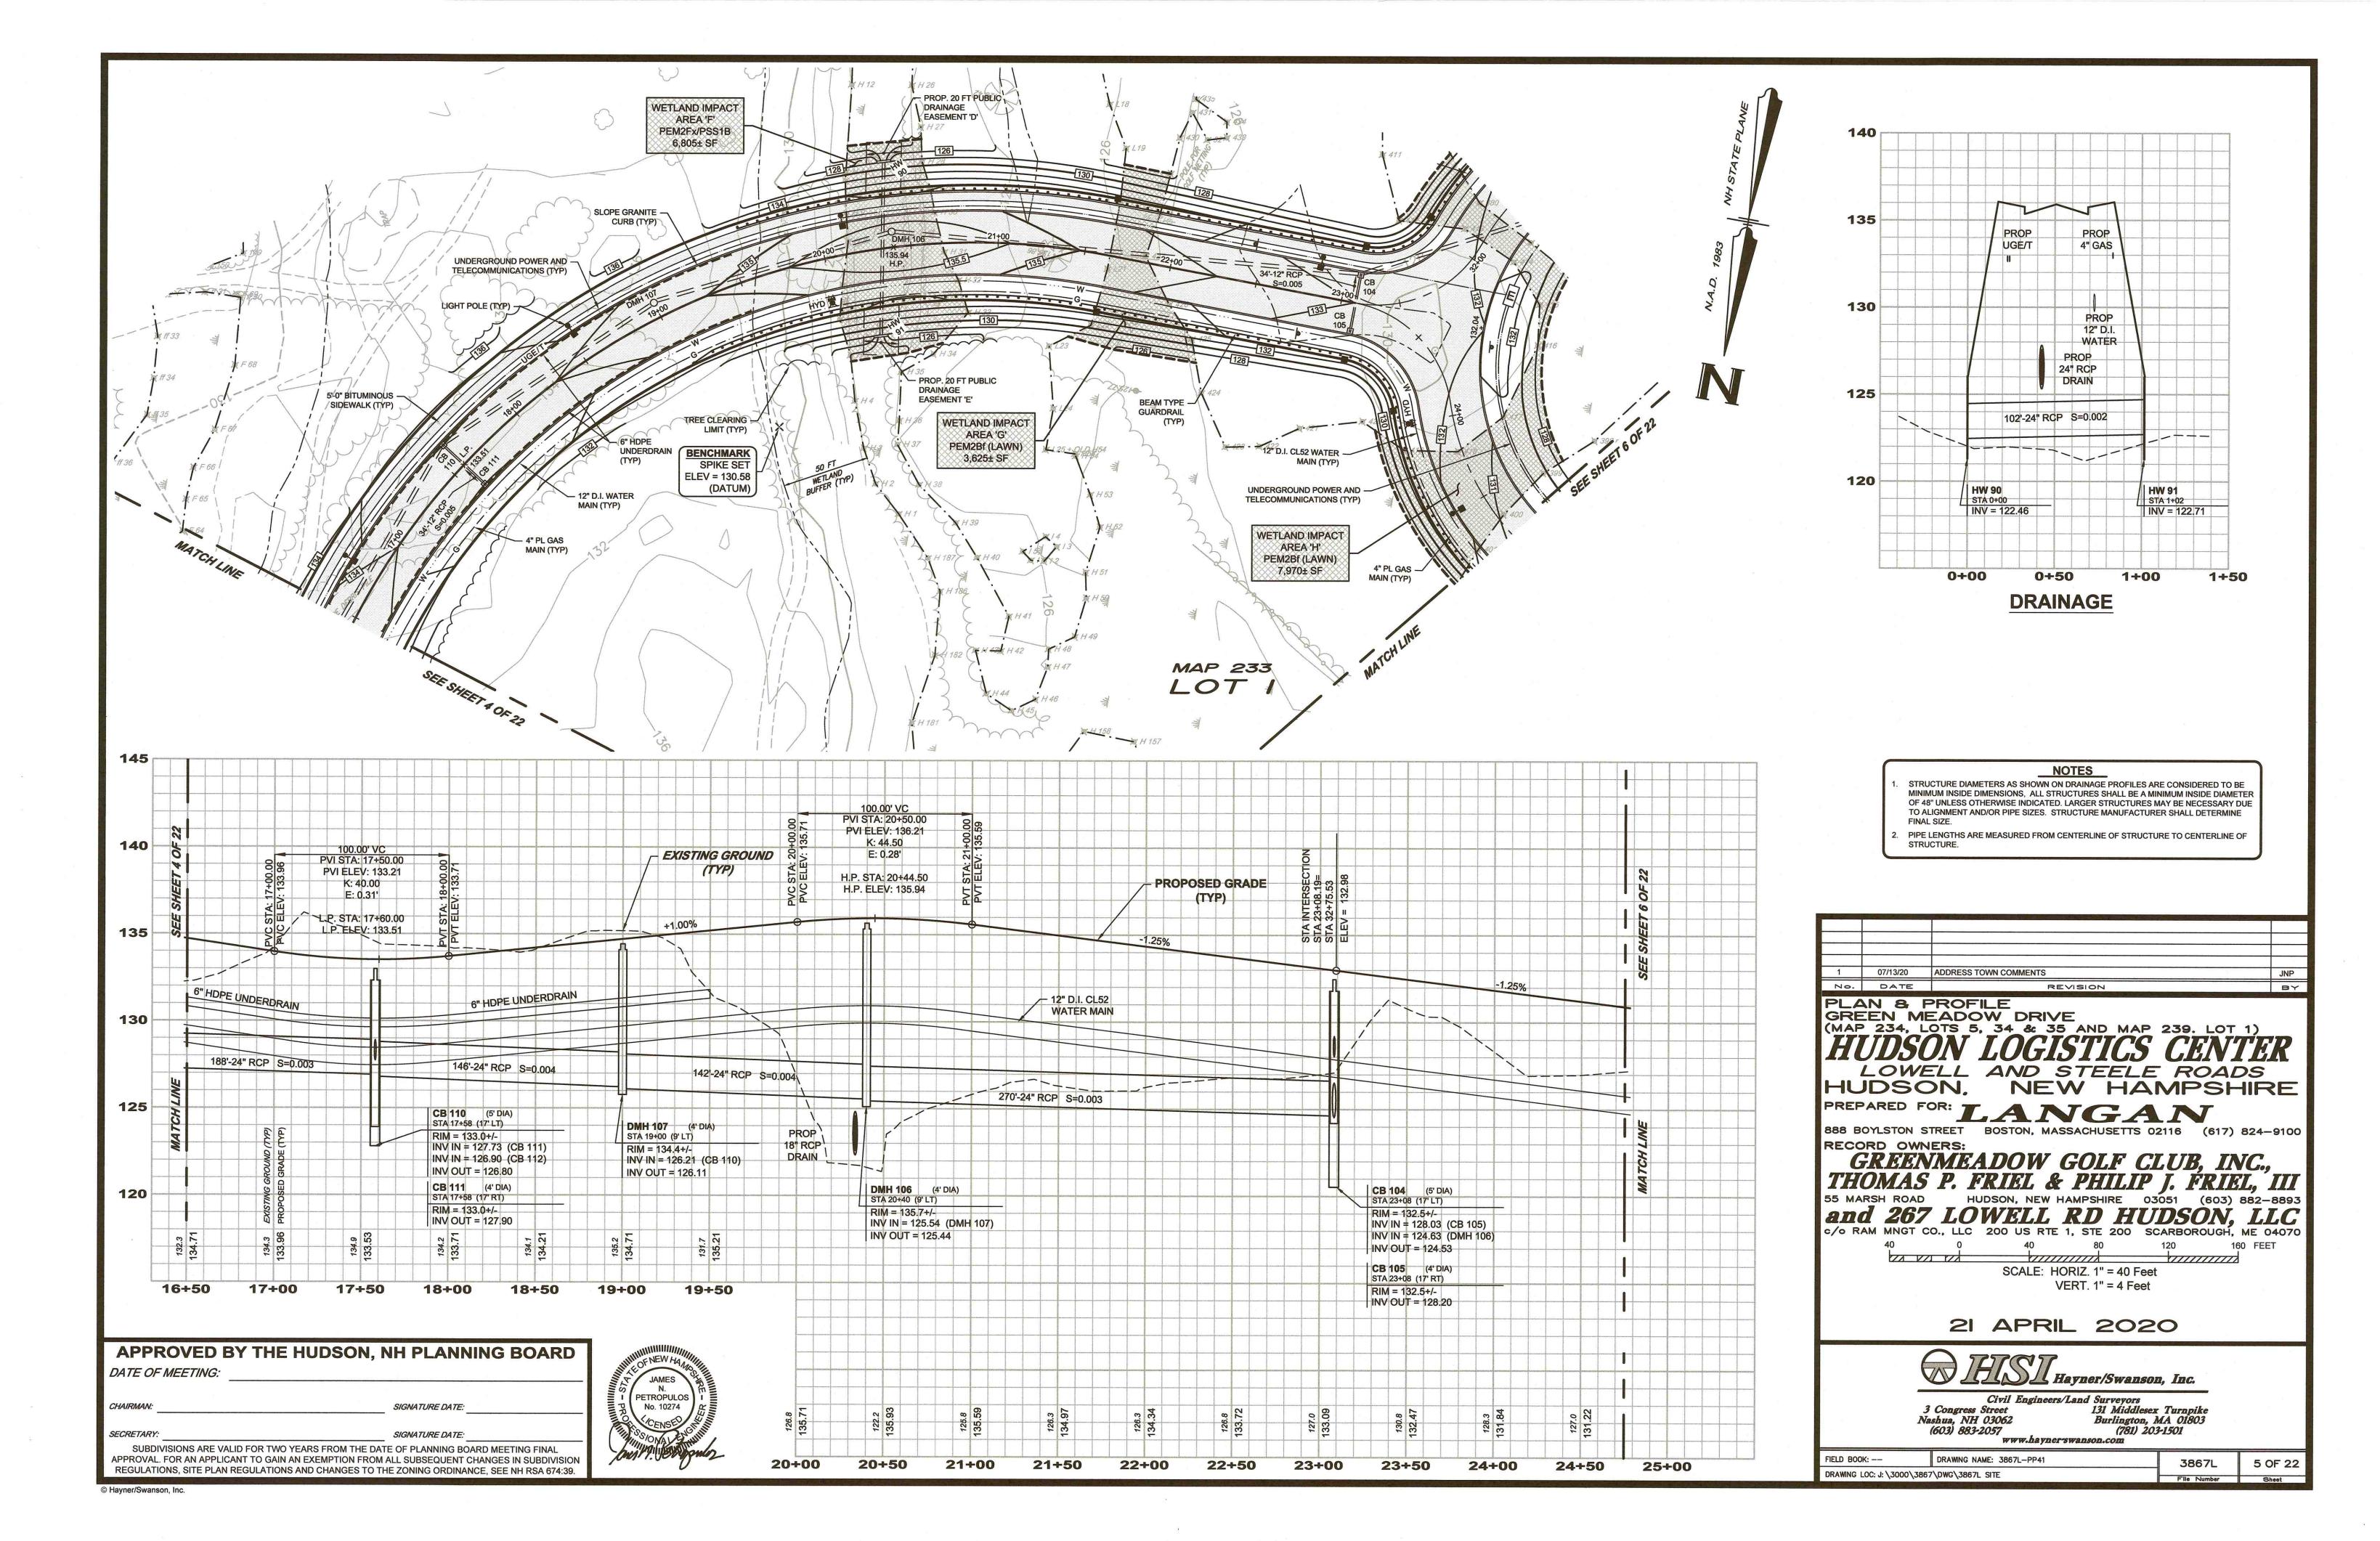
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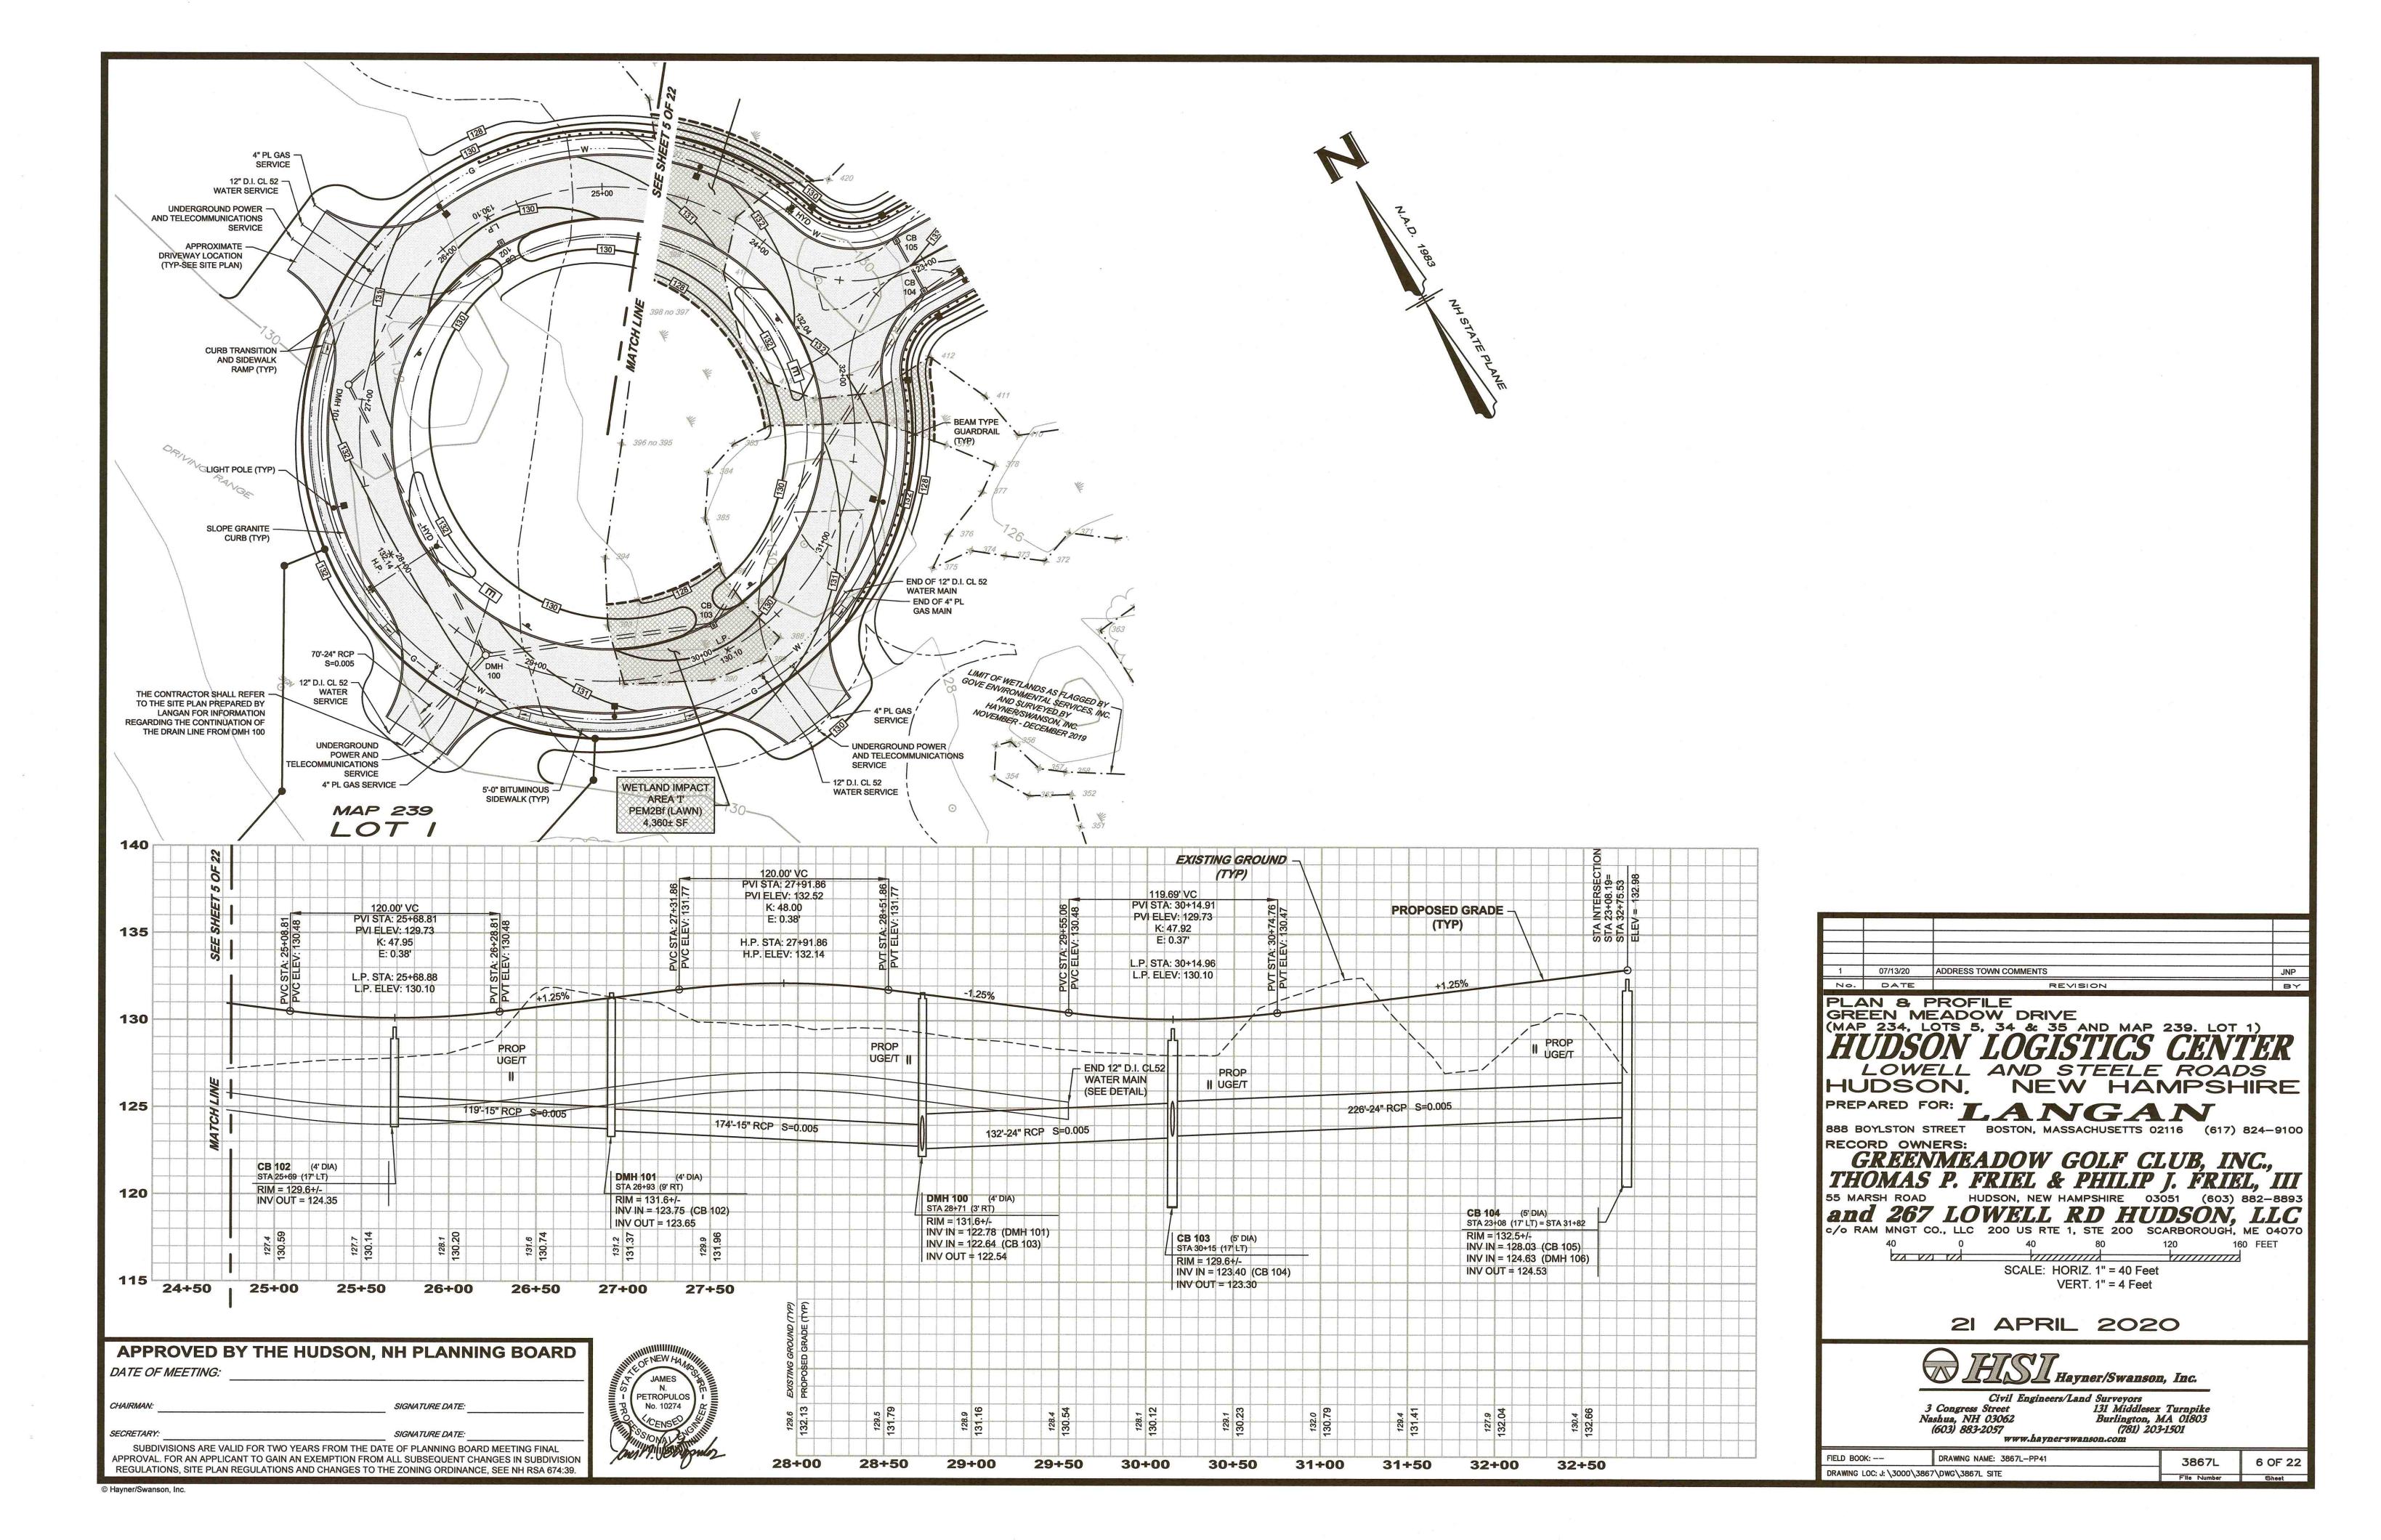
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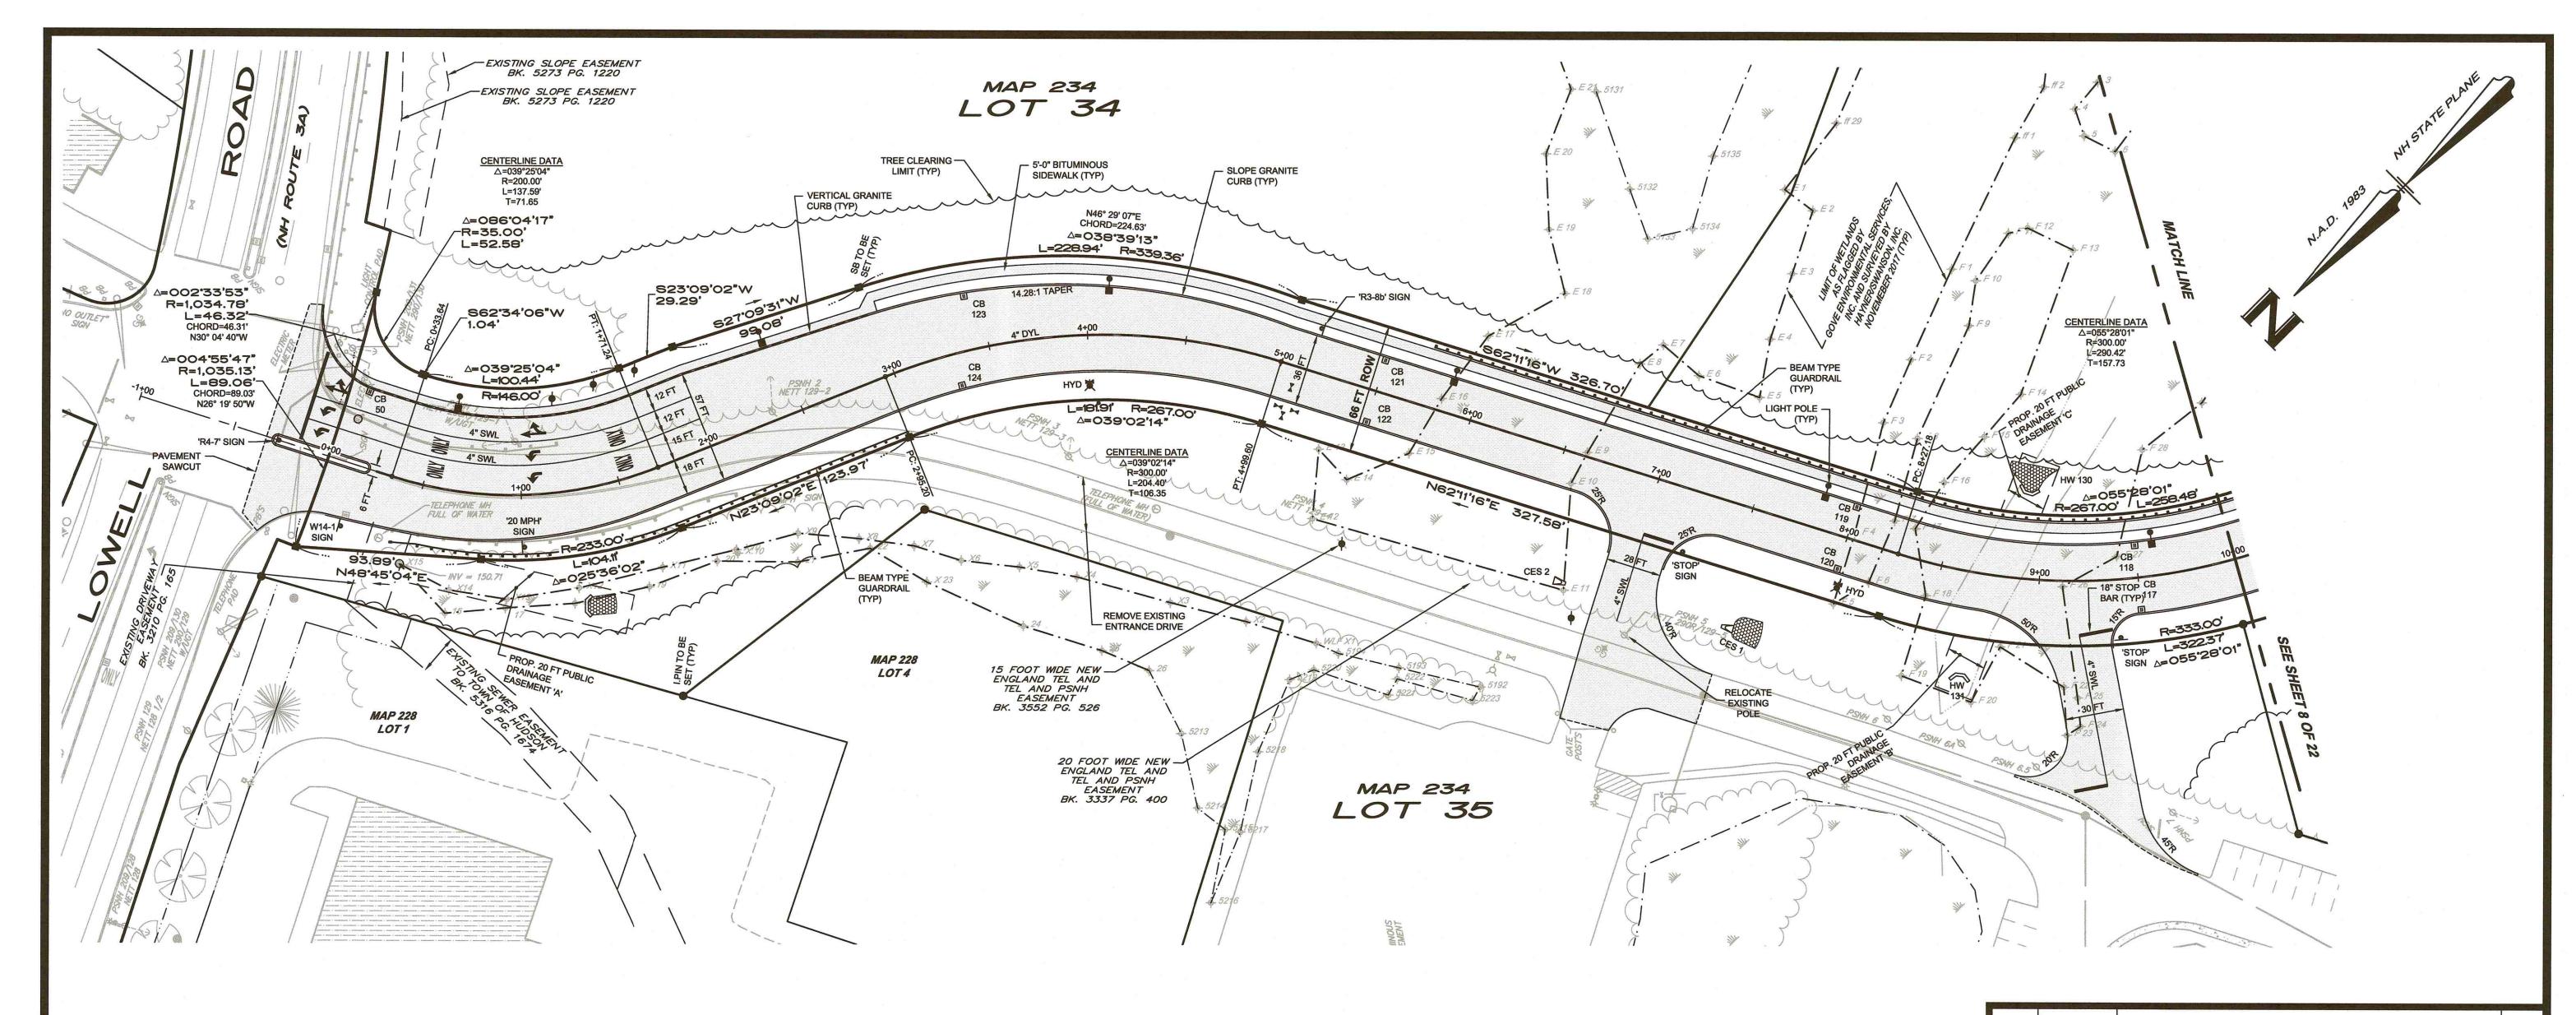
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LEGEND

" DYL FOUR-INCH DOUBLE YELLOW LINE

4" SWL FOUR-INCH SINGLE WHITE LINE

sig

VERTICAL GRANITE CURBING

SLOPE GRANITE CURBING

ROAD LAYOUT NOTES:

- PRIOR TO COMMENCEMENT OF MAJOR CONSTRUCTION ACTIVITIES, THE ENGINEER SHALL PROVIDE THE CONTRACTOR WITH LAYOUT PLANS AND COORDINATE VALUES FOR STRATEGIC ELEMENTS OF THE SITE, INCLUDING THE FOLLOWING:
 - [A] BASE LINE CONTROLS FOR THE BUILDING AREA
 [B] PARKING LOT CORNERS AND MAJOR RADIUS POINTS
 - [C] CATCH BASINS AND MANHOLE CENTERLINE POINTS
- THE CONTRACTOR SHALL REFER TO THE ARCHITECTURAL PLANS FOR THE EXACT BUILDING DIMENSIONS AND DETAILS.
- ALL DIMENSIONS ARE FROM FACE OF CURB OR OUTSIDE FACE OF BUILDING UNLESS NOTED OTHERWISE.
- STAIR AND DOORWAY LOCATIONS AS SHOWN ARE FOR REFERENCE ONLY. REFER TO THE ARCHITECTURAL PLANS FOR EXACT LOCATIONS.
- 5. ALL PAVEMENT MARKINGS SHALL BE 4-INCH WHITE PAINT UNLESS NOTED OTHERWISE. 4-INCH YELLOW PAINT SHALL BE USED FOR ROADWAY CENTERLINES.
- 6. ALL SIGNAGE SHALL BE IN ACCORDANCE WITH THE MANUAL OF UNIFORM TRAFFIC CONTROL DEVICES (MUTCD), LATEST EDITION.

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1	07/13/20	ADDRESS TOWN COMMENTS	JNP
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	RSH ROAD	HUDSON, NEW HAMPSHIRE 03051 (603) 882-	-8893
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	_	Mayner/Swanson, Inc.	
	.	Civil Engineers/Land Surveyors	
		Congress Street 131 Middlesex Turnpike	
	IVa	shua, NH 03062 Burlington, MA 01803 (603) 883-2057 (781) 203-1501	
		www.haynerswanson.com	

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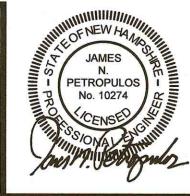
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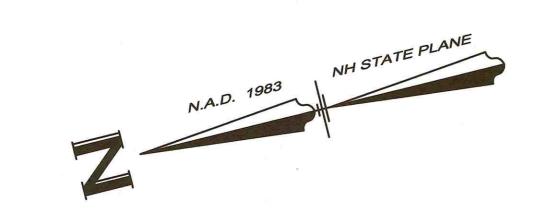
APPROVED BY THE HUDSON, NH PLANNING BOARD

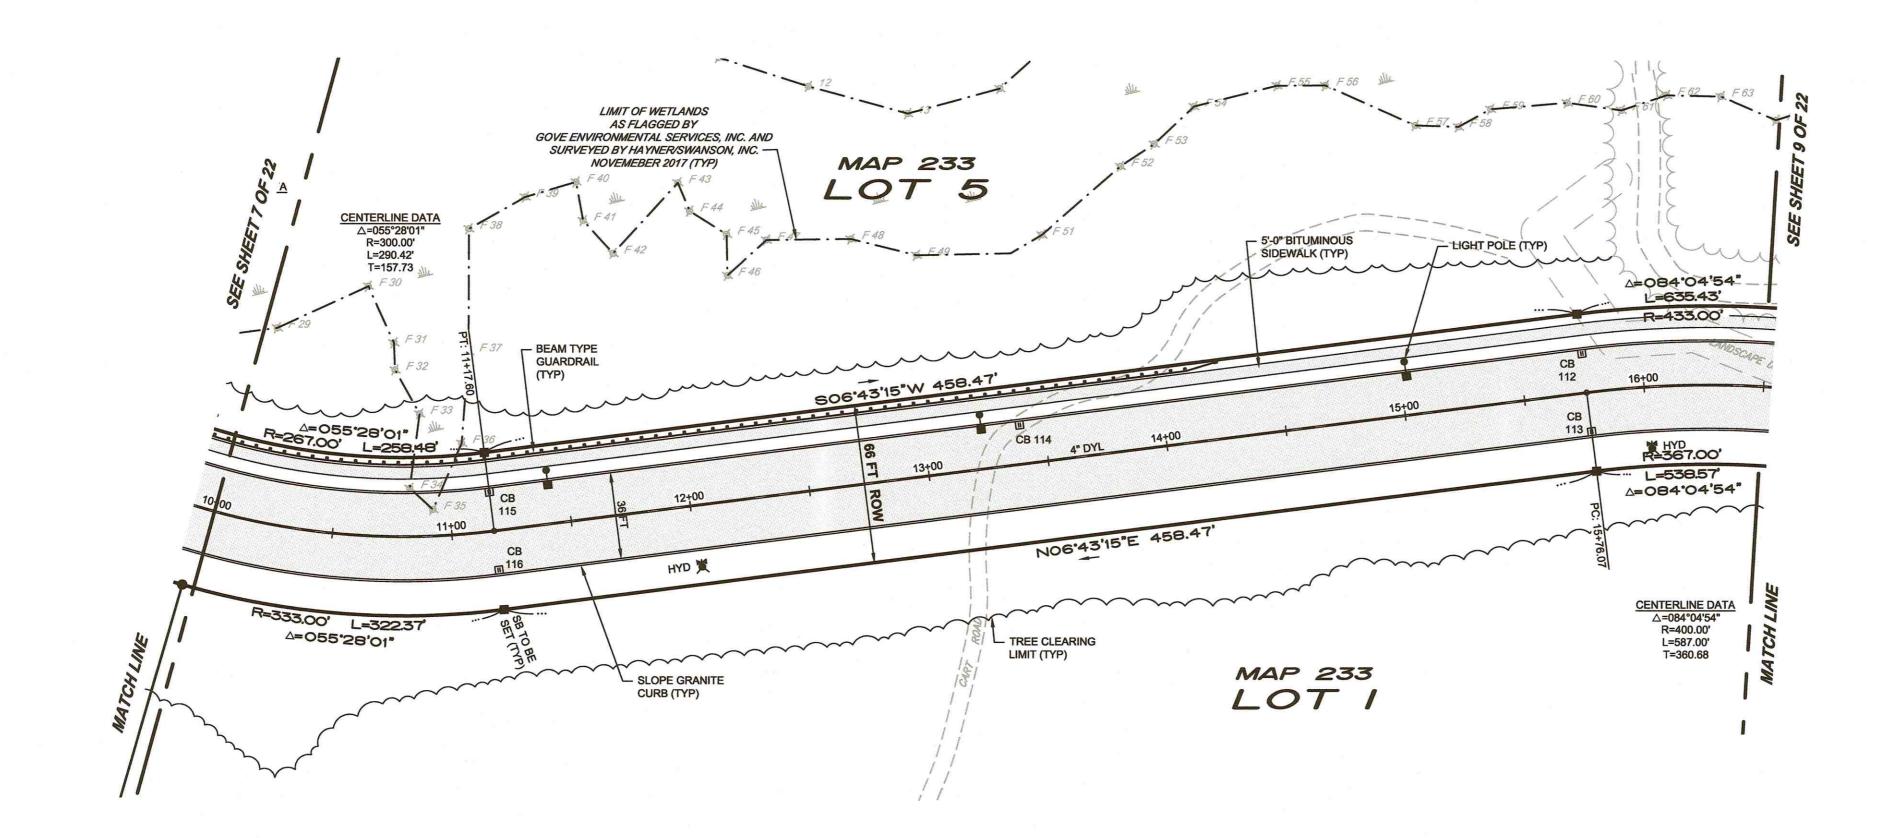
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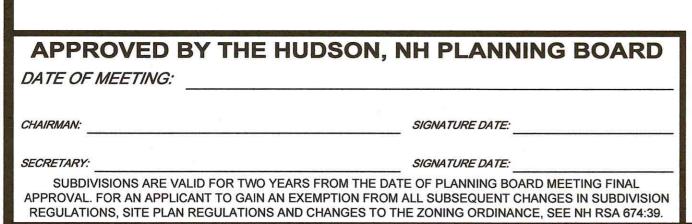
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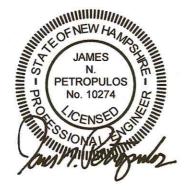
SUBDIVISIONS ARE VALID FOR TWO YEARS FROM THE DATE OF PLANNING BOARD MEETING FINAL APPROVAL. FOR AN APPLICANT TO GAIN AN EXEMPTION FROM ALL SUBSEQUENT CHANGES IN SUBDIVISION REGULATIONS, SITE PLAN REGULATIONS AND CHANGES TO THE ZONING ORDINANCE, SEE NH RSA 674:39.











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1	07/13/20	ADDRESS TOWN COMMENTS	JNP
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55 MA	RSH ROAD	HUDSON, NEW HAMPSHIRE 03051 (603) 882	
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www.hayner-swanson.com

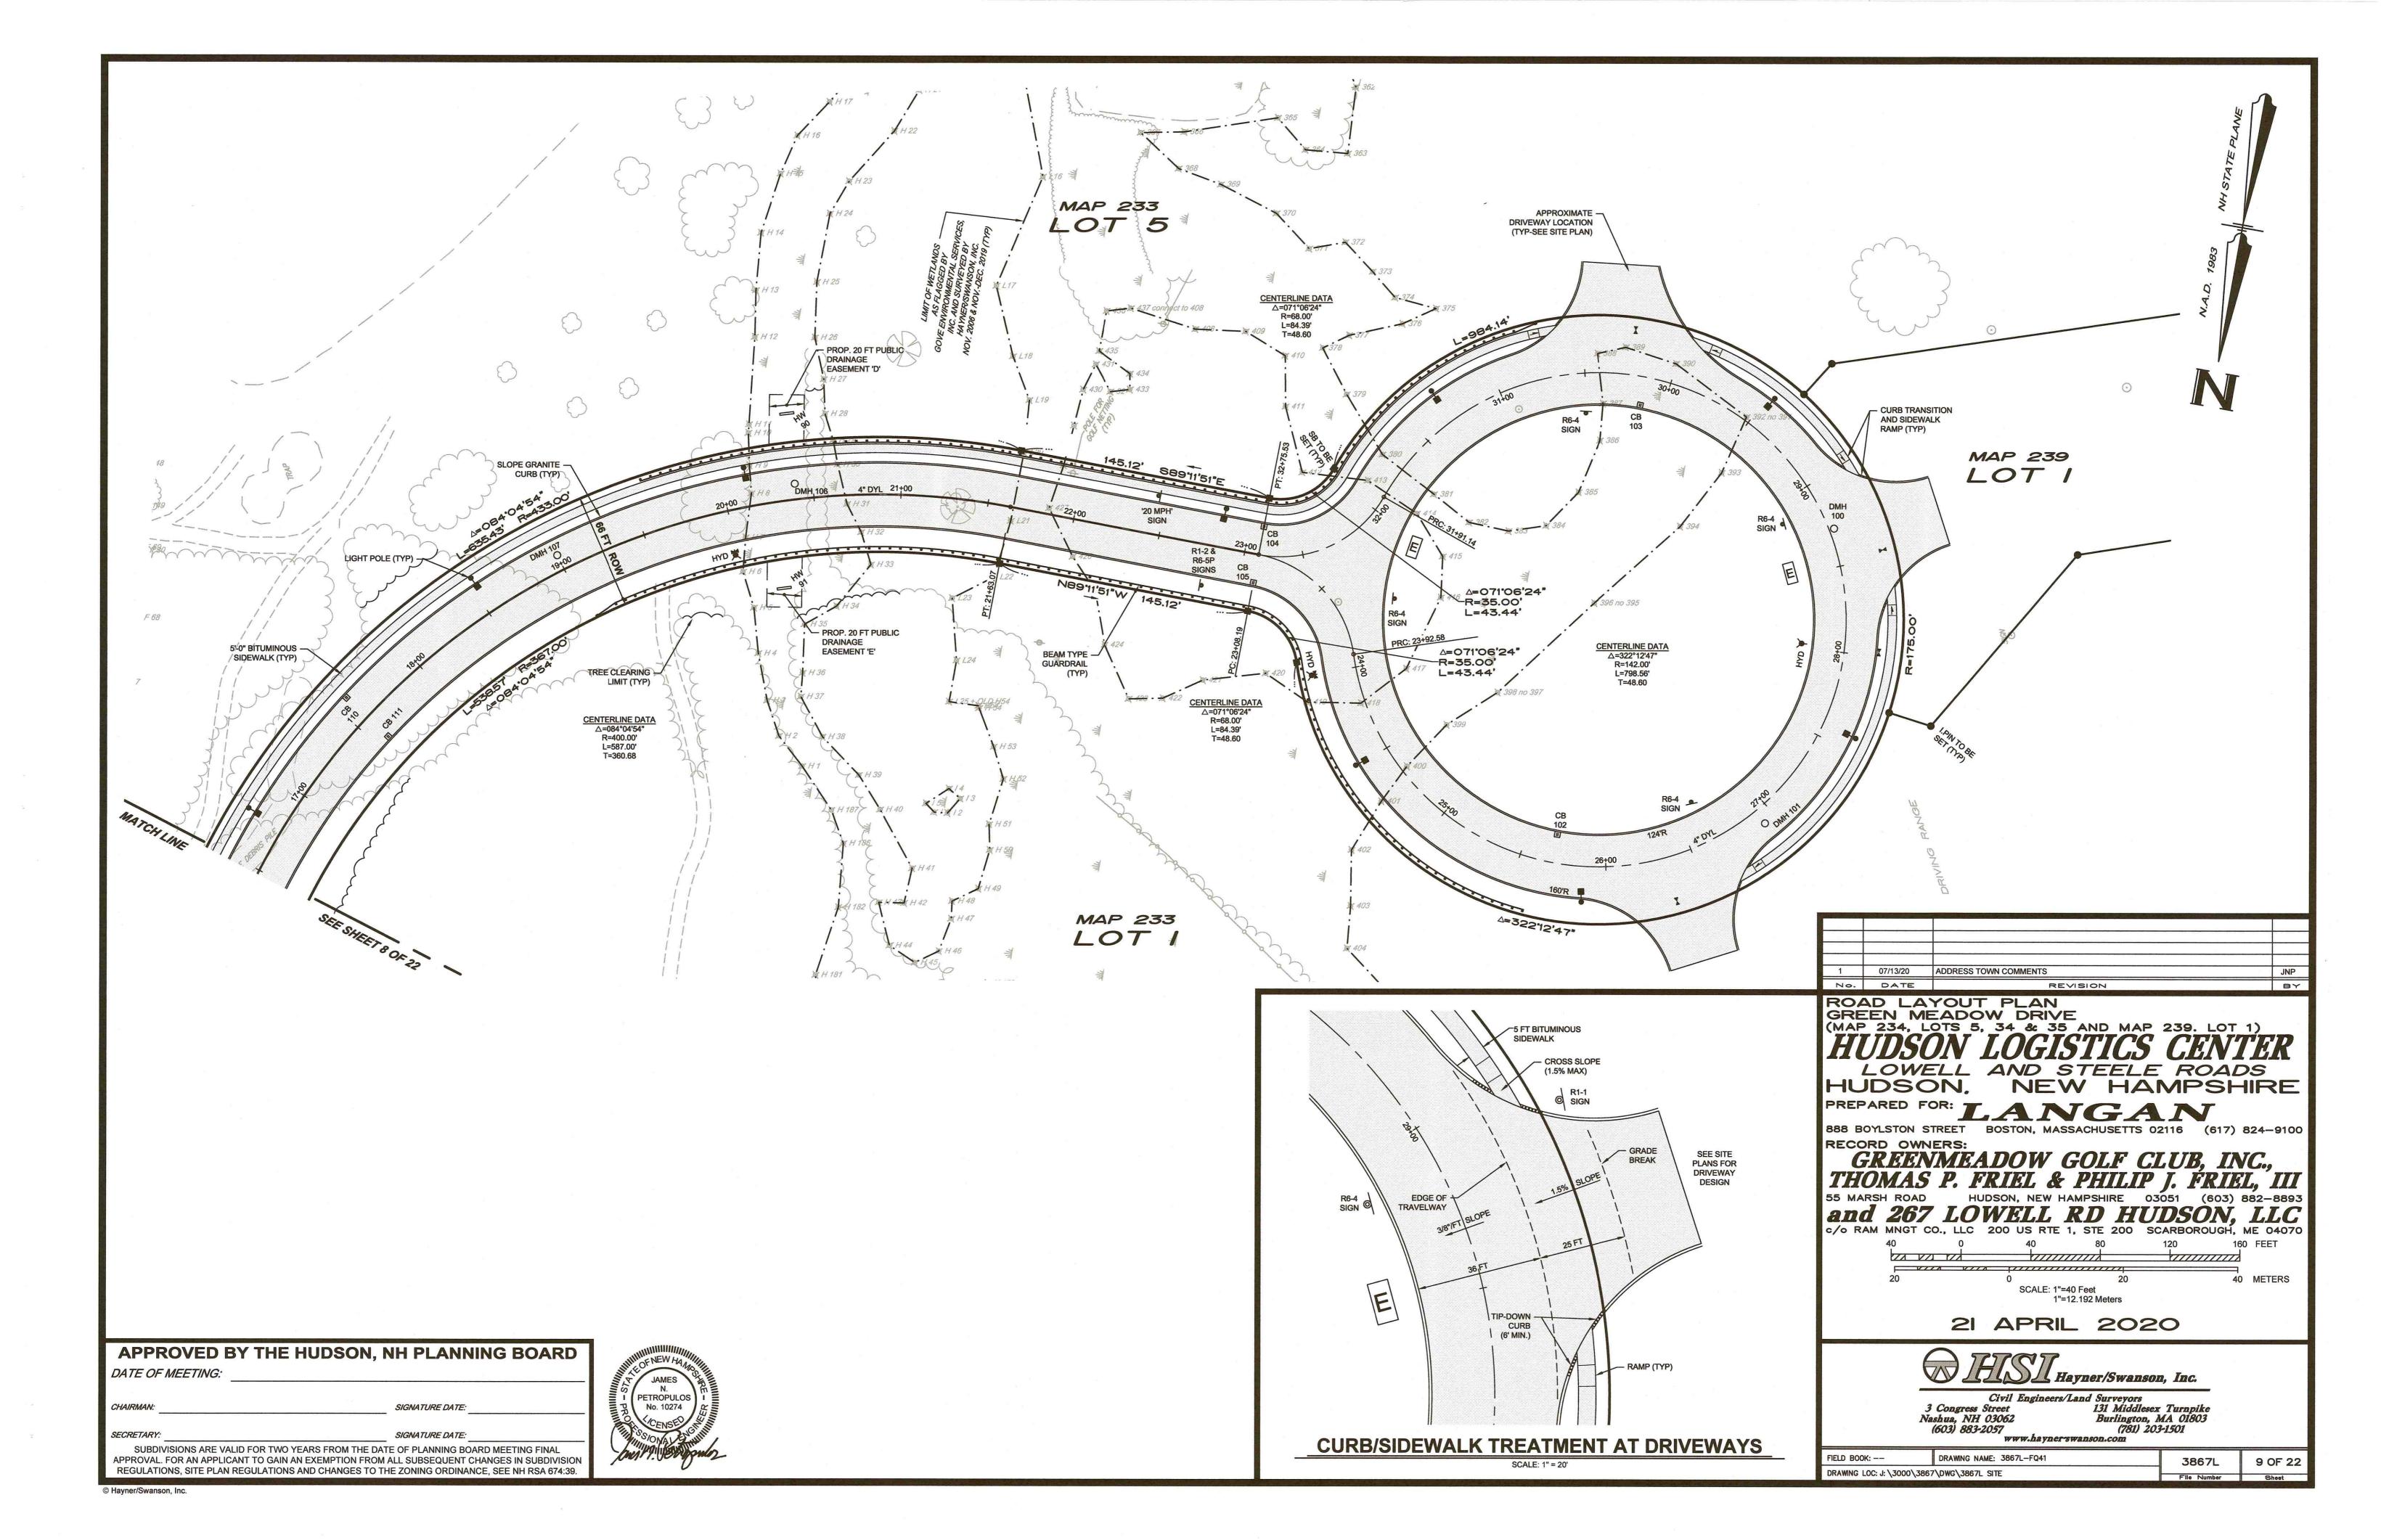
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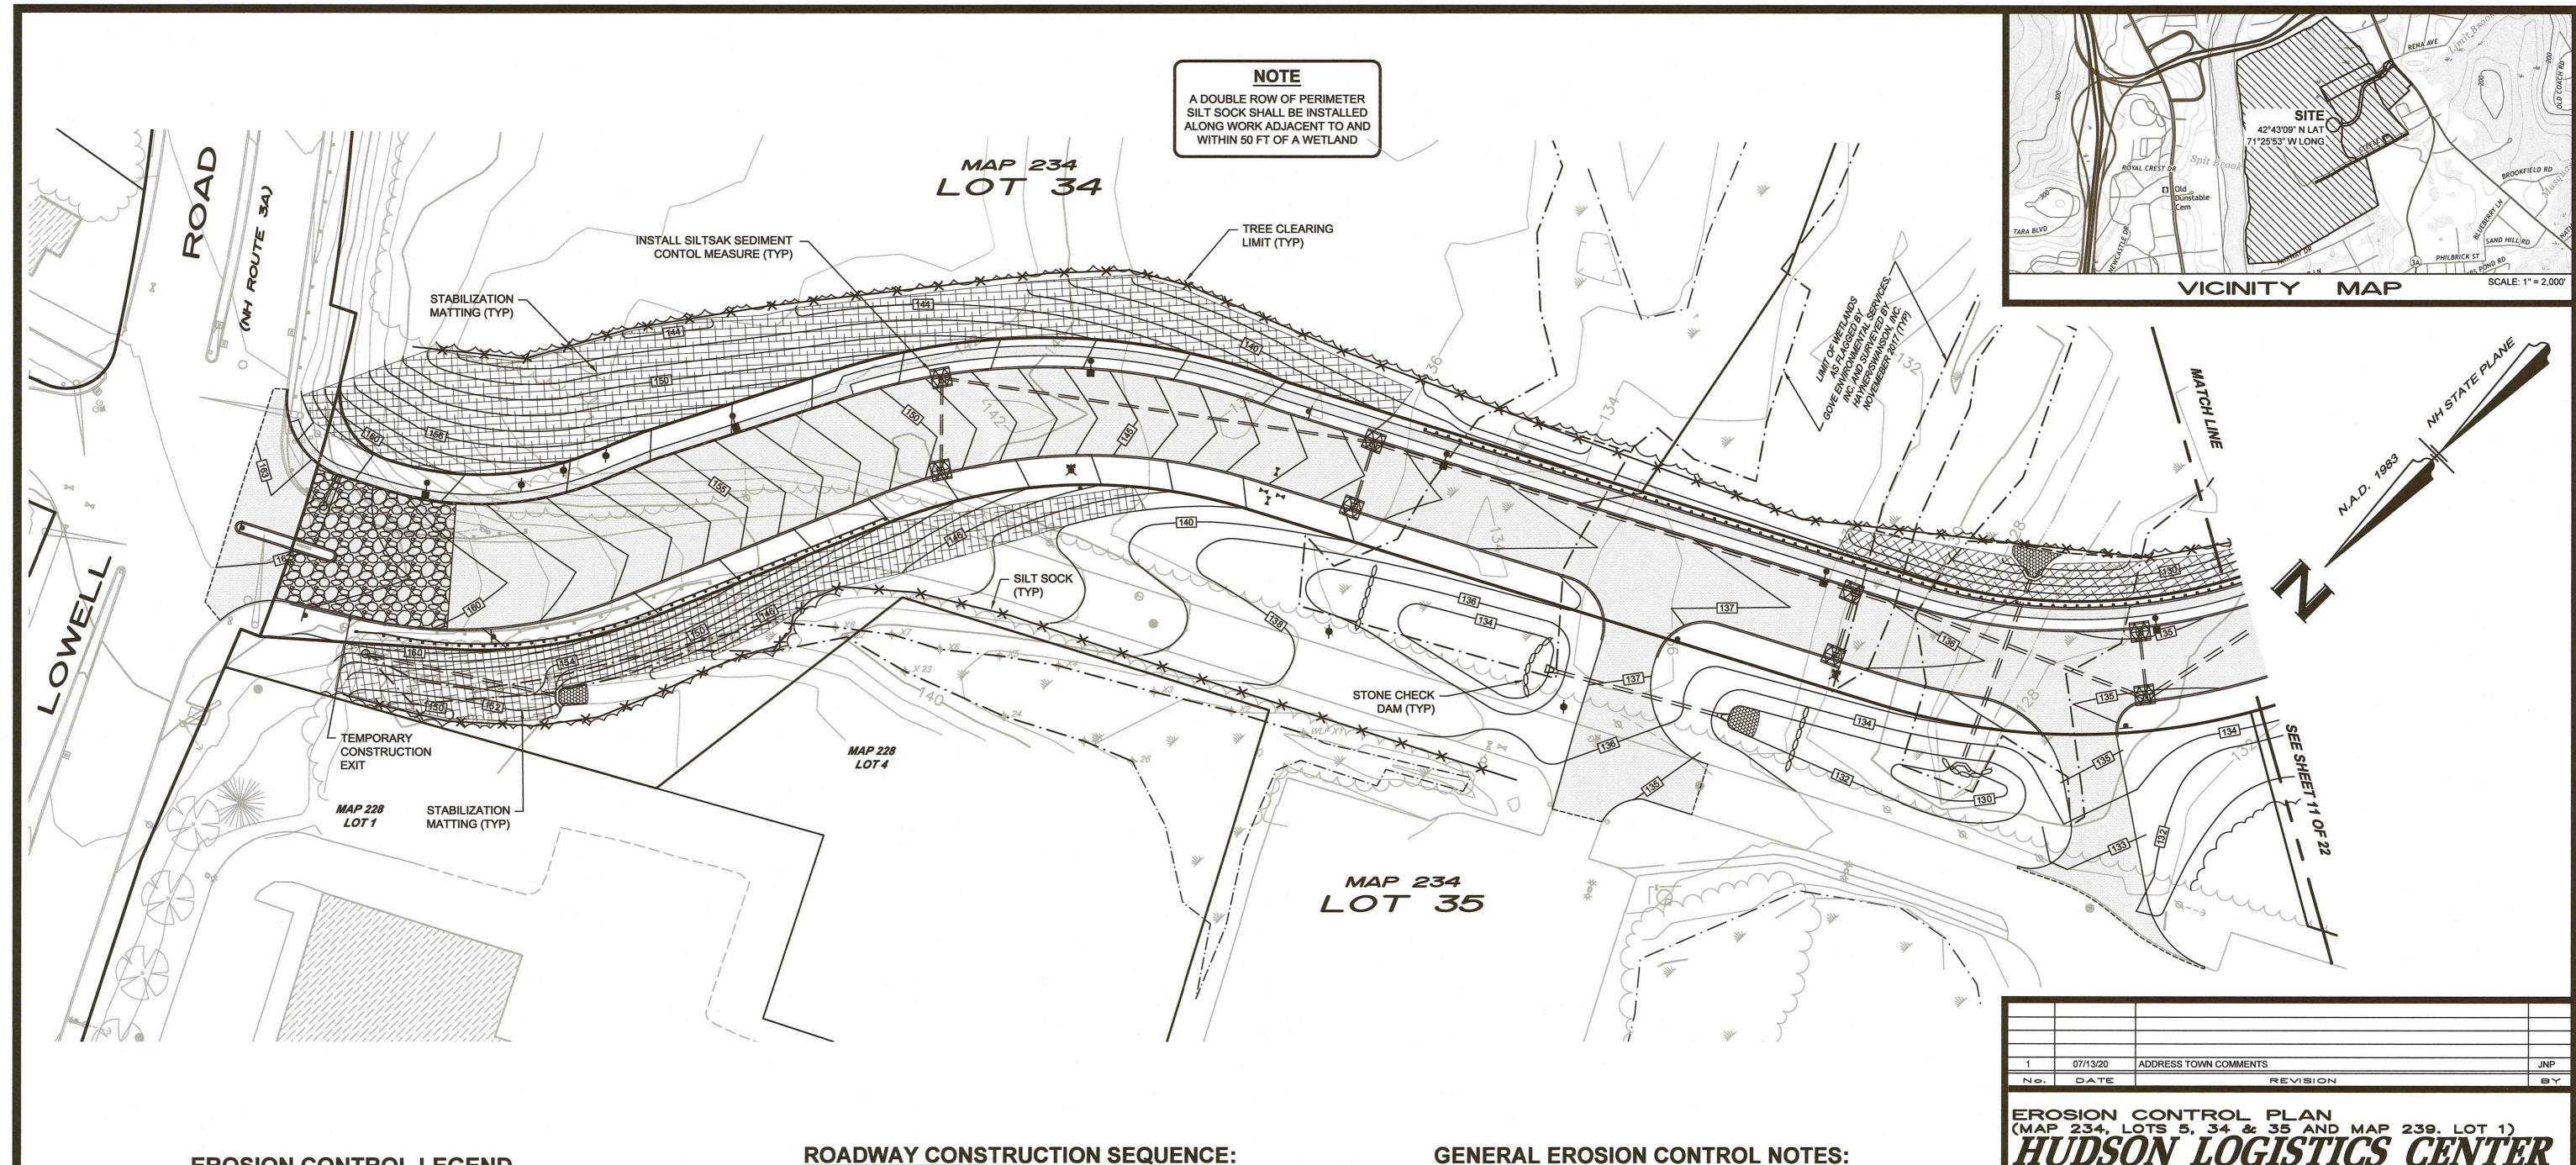
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3 Congress Street Nashua, NH 03062 (603) 883-2057

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DRAWING NAME: 3867L-FQ41





EROSION CONTROL LEGEND

SILT-SACK INLET PROTECTION DEVICES GRAVEL CONSTRUCTION EXIT

-X X SILT SOCK

STABILIZATION MATTING

STONE CHECK DAM

DIVERSION DIRECTION

RUNOFF DIRECTION

PREPARE ROADWAY FOR PAVING.

SUFFICIENTLY STABILIZED.

AS THE ROADWAY IS COMPLETED, ALL DISTURBED AREA SHALL BE PERMANENTLY STABILIZED, NO PORTION OF THE PROJECT SHALL BE LEFT DISTURBED AND UNSTABILIZED FOR A PERIOD OF TWO (2) MONTHS OR GREATER.

CLEAR & GRUB SITE ACCORDING TO PLAN. CUT AND DISPOSE OF ANY DEBRIS PRODUCED

DURING THE CLEARING AND GRUBBING ACTIVITY. ALL STUMPS SHALL BE DISPOSED OFF-SITE

INSTALL EROSION CONTROL SILT SOCK PROTECTION AND TEMPORARY GRAVEL

CONSTRUCTION EXITS. PERIMETER CONTROLS MUST BE INSTALLED PRIOR TO EARTH

MOVING OPERATIONS. SEDIMENT PONDS AND DIVERSION SWALES MUST BE INSTALLED

BEFORE ROUGH GRADING THE SITE. RUNOFF MUST BE DIRECTED TO TEMPORARY PRACTICES

PERFORM GRADING OF ROADWAY. ALL SLOPE AREAS SHALL BE LOAMED AND SEEDED AND

INSTALL INLET PROTECTION AROUND ALL STORM DRAIN STRUCTURES. INSTALLATION OF

UNDERGROUND UTILITIES AND CATCH BASINS SHALL BE PROTECTED FROM SEDIMENT IN

ACCORDANCE WITH THE 'SILTSACK DETAIL'. THE CONTROL SHALL REMAIN UNTIL THE SITE IS

LOAM AND SEED ALL REMAINING DISTURBED AREAS. COMPLETED AREAS SHALL BE STABILIZED 72 HOURS AFTER COMPLETION.

FINAL PAVING OF ROADWAY AND SIDEWALKS.

INSPECTION OF ALL SEDIMENT AND EROSION CONTROL MEASURES.

UNTIL PERMANENT STORMWATER BMPs ARE STABILIZED.

MULCHED IMMEDIATELY AFTER BEING CONSTRUCTED.

INSTALL UTILITIES IN ACCORDANCE WITH THE PLANS.

PERMANENT SEEDING OF DISTURBED AREAS. 12.

REMOVE ANY TEMPORARY EROSION CONTROL MEASURES NOT NEEDED.

GENERAL EROSION CONTROL NOTES:

- ALL CONTRACTORS AND SUBCONTRACTORS INVOLVED WITH STORMWATER POLLUTION PREVENTION SHALL OBTAIN A COPY OF THE STORMWATER POLLUTION PREVENTION PLAN (SWPPP) AND NATIONAL POLLUTION DISCHARGE ELIMINATION SYSTEM (NPDES) CONSTRUCTION GENERAL PERMIT (CGP) AND BECOME FAMILIAR WITH THEIR CONTENTS.
- THE CONTRACTOR SHALL IMPLEMENT BEST MANAGEMENT PRACTICES AS REQUIRED BY THE SWPPP. ADDITIONAL BEST MANAGEMENT PRACTICES SHALL BE IMPLEMENTED AS DICTATED BY SITE CONDITIONS AT NO ADDITIONAL COST OF OWNER THROUGHOUT ALL PHASES OF
- BEST MANAGEMENT PRACTICES (BMP'S) AND CONTROLS SHALL CONFORM TO FEDERAL, STATE, OR LOCAL REQUIREMENTS OR MANUAL OF PRACTICE, AS APPLICABLE. CONTRACTOR SHALL IMPLEMENT ADDITIONAL CONTROLS AS DIRECTED BY PERMITTING AGENCY OR OWNER.
- EARTH MATERIAL STOCKPILE AREAS SHALL BE SURROUNDED BY SILT SOCK AND RE-SEEDED IF THEY ARE LEFT UNTOUCHED FOR MORE THAN FOURTEEN (14) DAYS.
- DREDGING/GRUBBING OF THE IMPACTED AREAS. THE CONTRACTOR SHALL STOCKPILE THIS HUMUS MATERIAL SEPARATELY FOR RE-USE ON FILL SLOPES ADJACENT TO WETLAND AREAS. ALL MEASURES STATED ON THIS EROSION CONTROL PLAN, AND IN THE STORMWATER POLLUTION

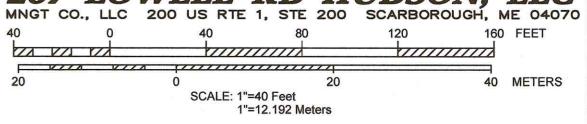
THE PROJECT IS EXPECTED TO GENERATE A SIZEABLE VOLUME OF WETLAND HUMUS DURING THE

- PREVENTION PLAN, SHALL BE MAINTAINED IN FULLY FUNCTIONAL CONDITION UNTIL NO LONGER REQUIRED FOR A COMPLETE PHASE OF WORK OR FINAL STABILIZATION OF THE SITE. ALL EROSION CONTROL MEASURES SHALL BE CHECKED BY A QUALIFIED PERSON IN ACCORDANCE WITH THE CONTRACT DOCUMENTS OR THE APPLICABLE PERMIT, WHICHEVER IS MORE STRINGENT.
- INLET PROTECTION DEVICES AND BARRIERS SHALL BE REPAIRED OR REPLACED IF THEY SHOW SIGNS OF UNDERMINING OR DETERIORATION.
- ALL SEEDED AREAS SHALL BE CHECK REGULARLY TO SEE THAT A GOOD STAND IS MAINTAINED. AREAS SHOULD BE FERTILIZED, WATERED AND RESEEDED AS NEEDED.
- THE TEMPORARY GRAVEL CONSTRUCTION EXITS SHALL BE MAINTAINED IN A CONDITION WHICH WILL PREVENT TRACKING OR FLOW OF MUD ONTO PUBLIC RIGHT-OF WAY. THIS MAY REQUIRE PERIODIC TOP DRESSING OF THE CONSTRUCTION EXITS AS CONDITIONS DEMAND.
- THE CONTRACTOR SHALL TAKE MEASURES TO INSURE THAT LOWELL ROAD AND THE PAVED SURFACES OF MAP 234, LOT 35 ARE KEPT FREE OF DIRT AND DEBRIS FOR THE DURATION OF THE

LOWELL AND STEELE ROADS HUDSON, NEW HAMPSHIRE

PREPARED FOR: LANGAN 888 BOYLSTON STREET BOSTON, MASSACHUSETTS 02116 (617) 824-9100 RECORD OWNERS:

GREENMEADOW GOLF CLUB, INC., THOMAS P. FRIEL & PHILIP J. FRIEL, III




21 APRIL 2020





131 Middlesex Turnpike 3 Congress Street Nashua, NH 03062 Burlington, MA 01803 (603) 883-2057 (781) 203-1501 www.hayner-swanson.com


DRAWING NAME: 3867L-ER41 FIELD BOOK: ---3867L 10 OF 22 DRAWING LOC: J: \3000\3867\DWG\3867L SITE

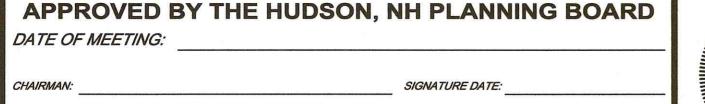

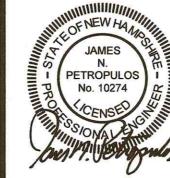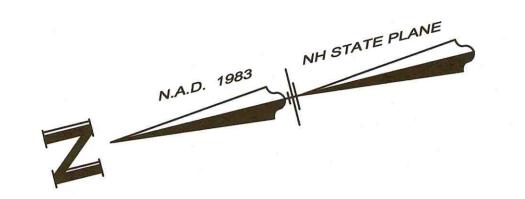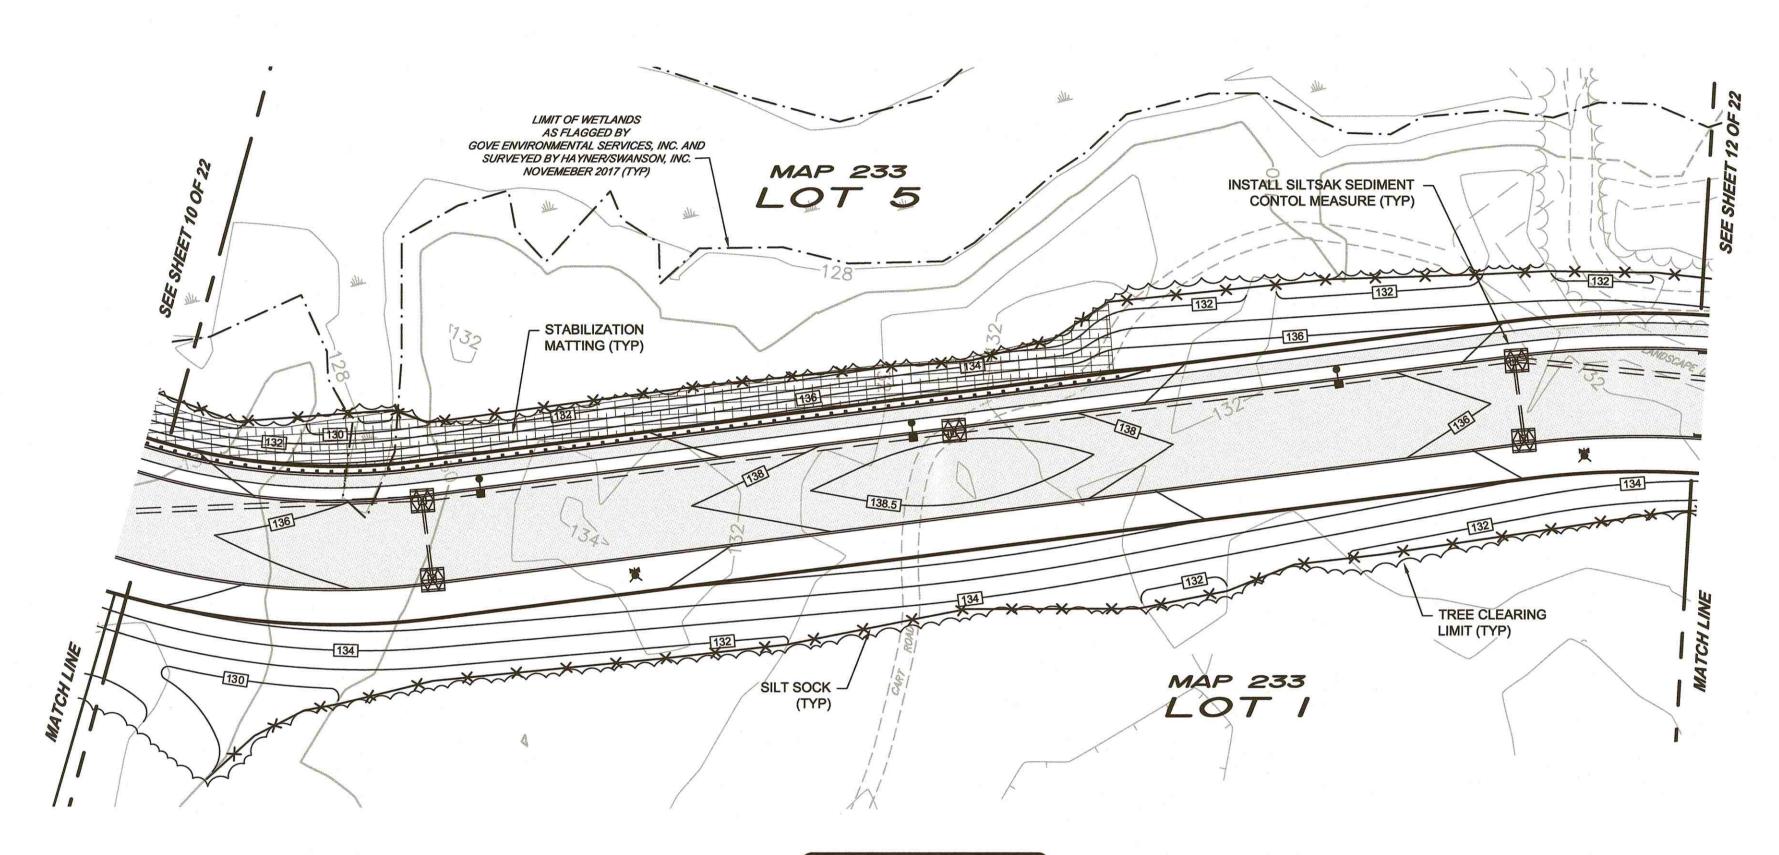SECRETARY: SIGNATURE DATE: SUBDIVISIONS ARE VALID FOR TWO YEARS FROM THE DATE OF PLANNING BOARD MEETING FINAL APPROVAL. FOR AN APPLICANT TO GAIN AN EXEMPTION FROM ALL SUBSEQUENT CHANGES IN SUBDIVISION REGULATIONS, SITE PLAN REGULATIONS AND CHANGES TO THE ZONING ORDINANCE, SEE NH RSA 674:39.









NOTE

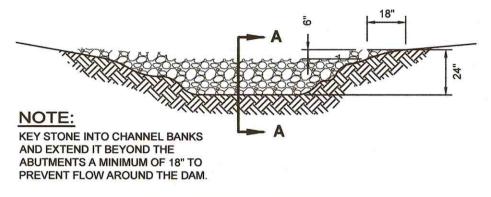A DOUBLE ROW OF PERIMETER
SILT SOCK SHALL BE INSTALLED
ALONG WORK ADJACENT TO AND
WITHIN 50 FT OF A WETLAND



VIEW LOOKING UPSTREAM

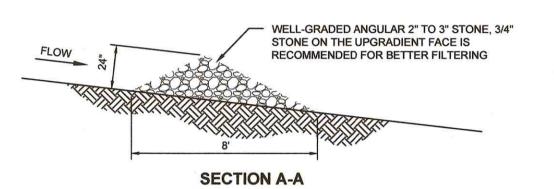

TEMPORARY STONE CHECK DAM TYPICAL SECTION NOT TO SCALE



EROSION CONTROL PLAN
(MAP 234, LOTS 5, 34 & 35 AND MAP 239, LOT 1)

HUDSON LOGISTICS CENTER

LOWELL AND STEELE ROADS
HUDSON, NEW HAMPSHIRE

PREPARED FOR: LANGAI

888 BOYLSTON STREET BOSTON, MASSACHUSETTS 02116 (617) 824-9100

RECORD OWNERS:

GREENMEADOW GOLF CLUB, INC.,
THOMAS P. FRIEL & PHILIP J. FRIEL, III

55 MARSH ROAD HUDSON, NEW HAMPSHIRE 03051 (603) 882-8893

and 267 LOWELL RD HUDSON, LLC

c/o RAM MNGT CO., LLC 200 US RTE 1, STE 200 SCARBOROUGH, ME 04070

40 0 40 80 120 160 FEET

20 0 20 40 METERS

SCALE: 1"=40 Feet

1"=12.192 Meters

21 APRIL 2020



Civil Engineers/Land Surveyors

3 Congress Street 131 Middlesex Turnpike
Nashua, NH 03062 Burlington, MA 01803
(603) 883-2057 (781) 203-1501
www.hayner-swanson.com

 FIELD BOOK: - DRAWING NAME: 3867L-ER41
 3867L
 11 OF 22

 DRAWING LOC: J: \3000\3867\DWG\3867L SITE
 File Number
 Sheet

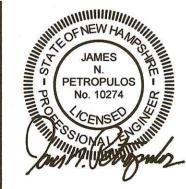
APPROVED BY THE HUDSON, NH PLANNING BOARD

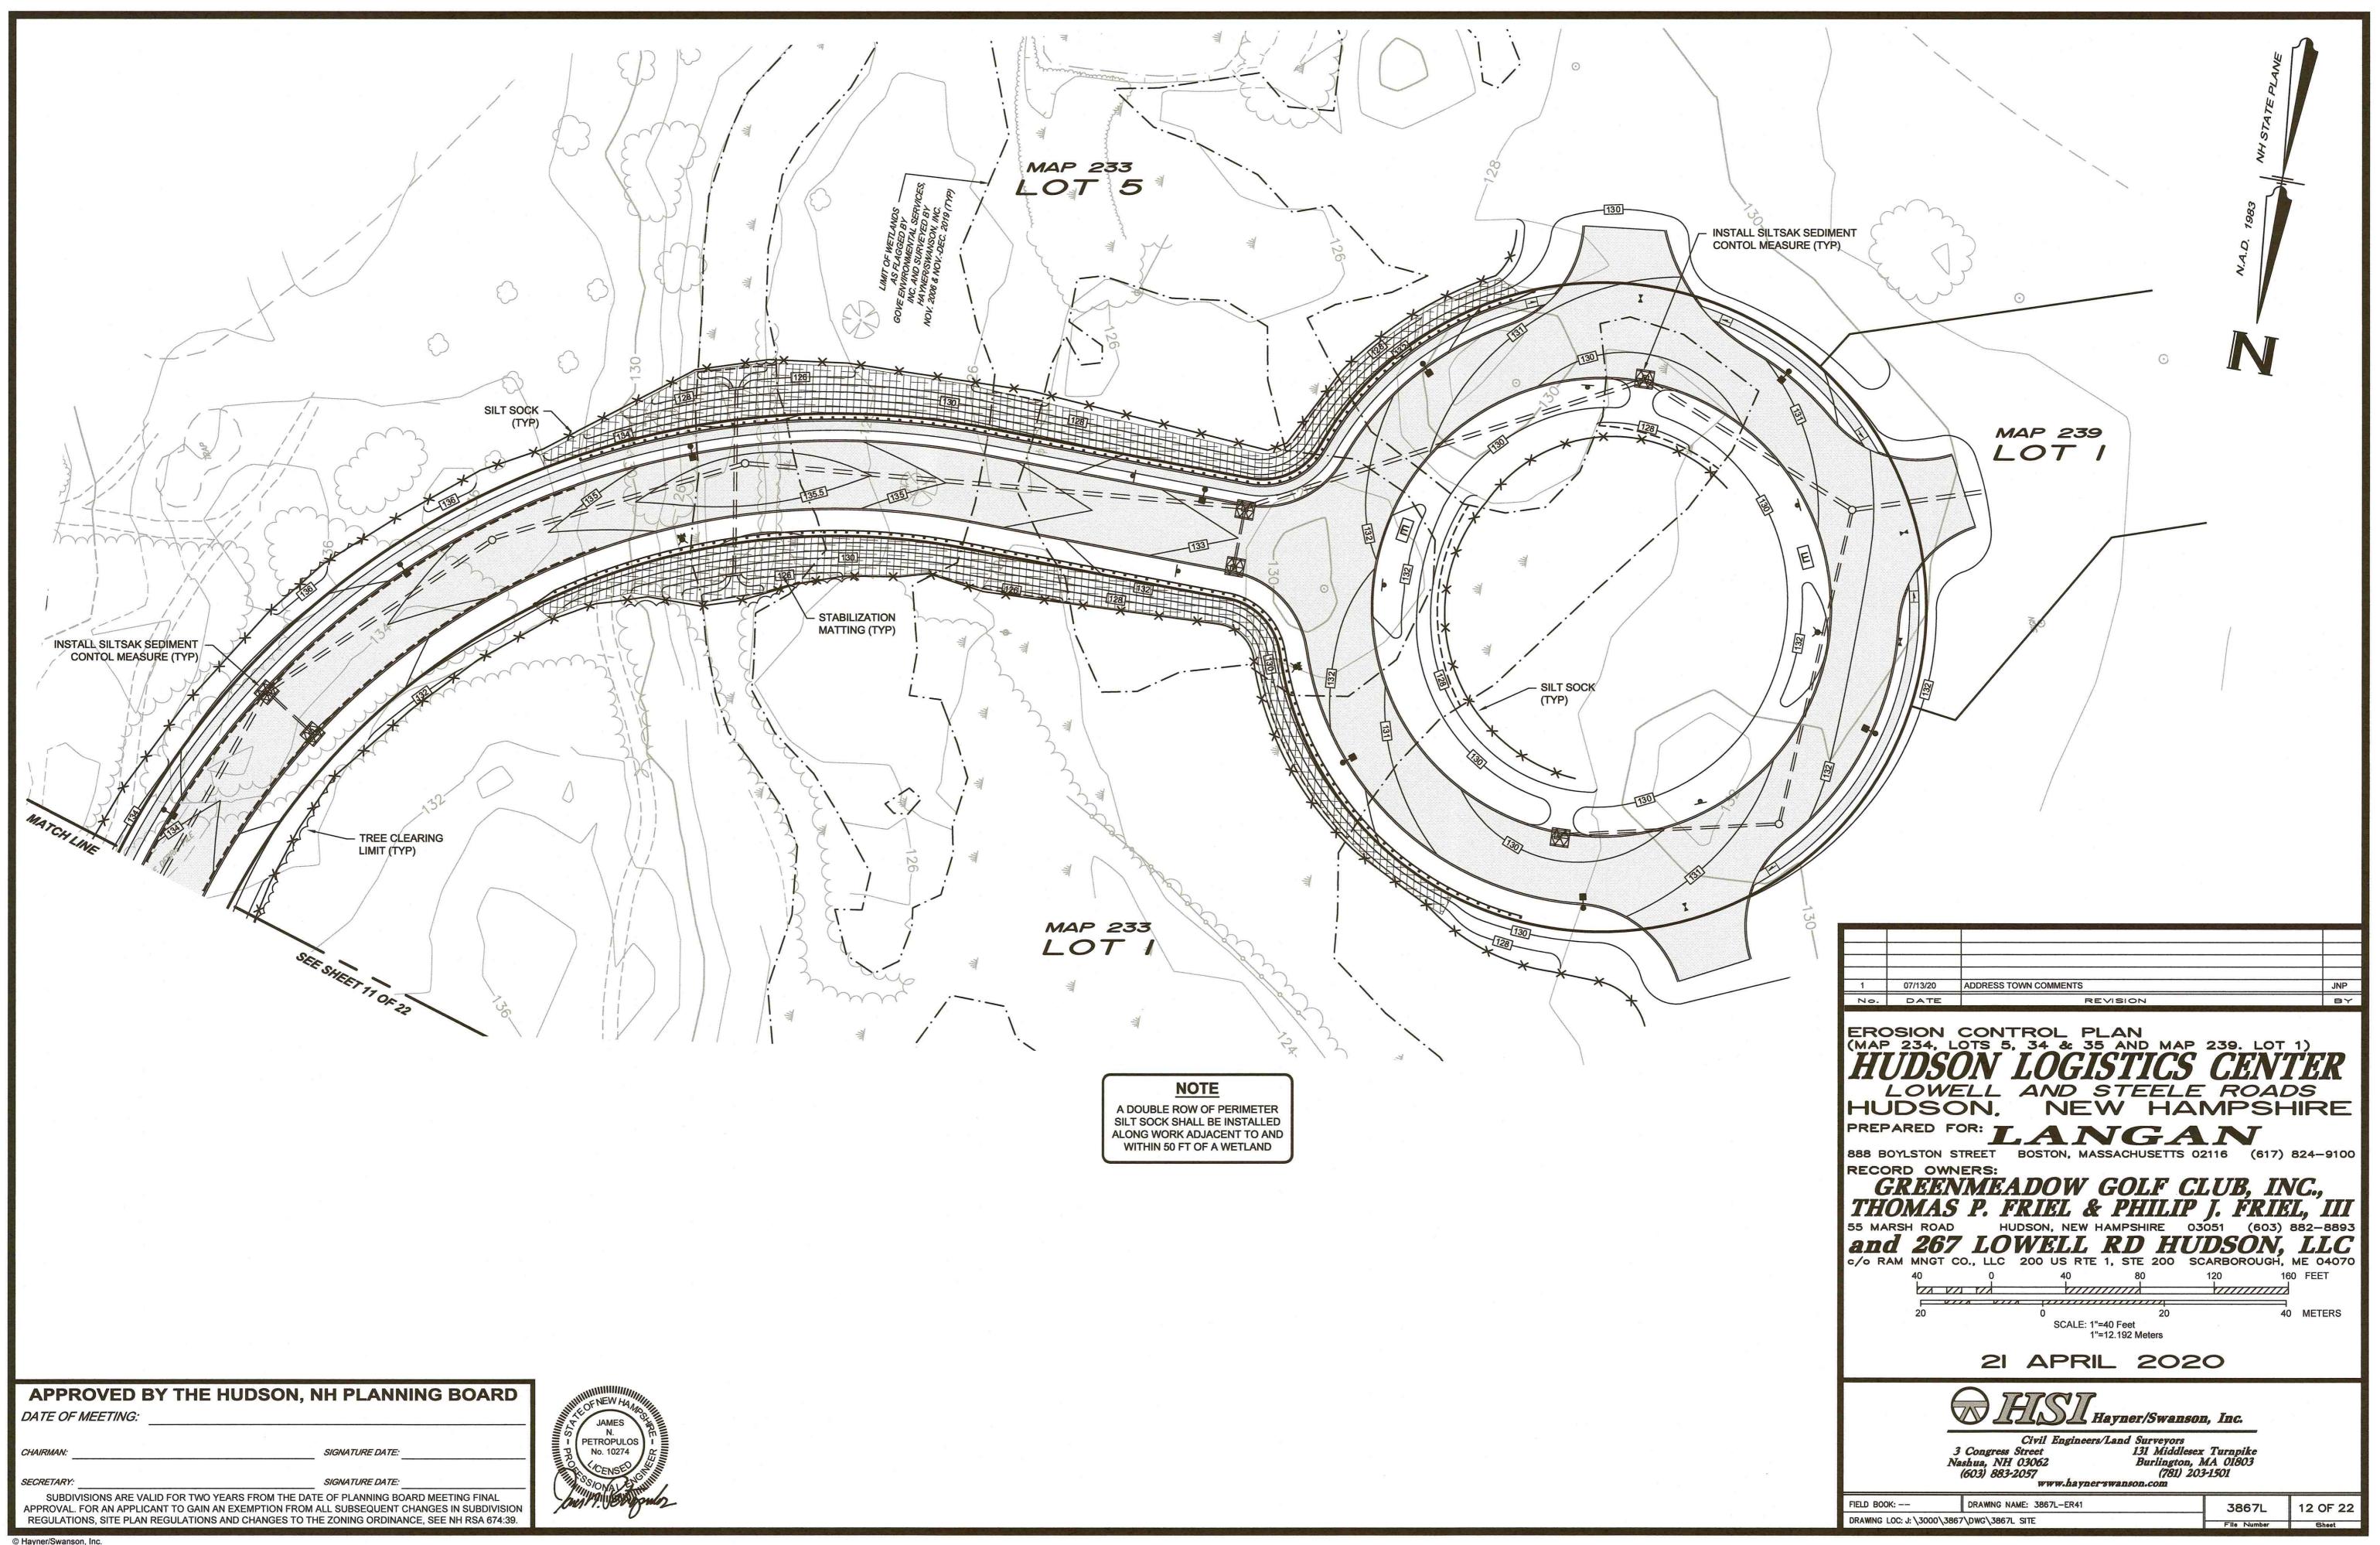
DATE OF MEETING:

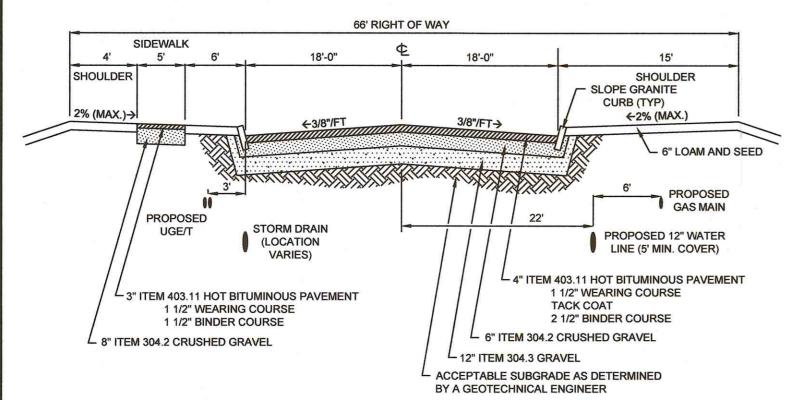
HAIRMAN: ______ SIGNATURE DATE: _____

SIGNATURE DATE:

SUBDIVISIONS ARE VALID FOR TWO YEARS FROM THE DATE OF PLANNING BOARD MEETING FINAL
APPROVAL. FOR AN APPLICANT TO GAIN AN EXEMPTION FROM ALL SUBSEQUENT CHANGES IN SUBDIVISION
REGULATIONS, SITE PLAN REGULATIONS AND CHANGES TO THE ZONING ORDINANCE, SEE NH RSA 674:39.









TYPICAL SECTION - GREEN MEADOW DRIVE

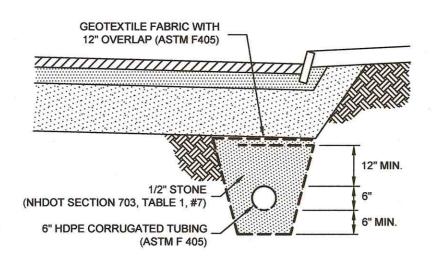NOT TO SCALE




ROADWAY UNDERDRAIN DETAIL

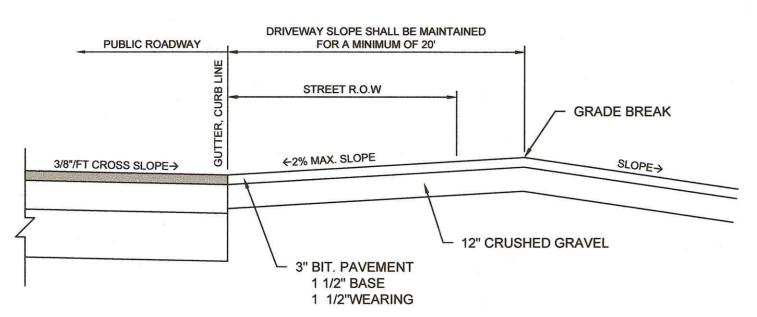NOT TO SCALE





TYPICAL SECTION - DRIVEWAY APRON

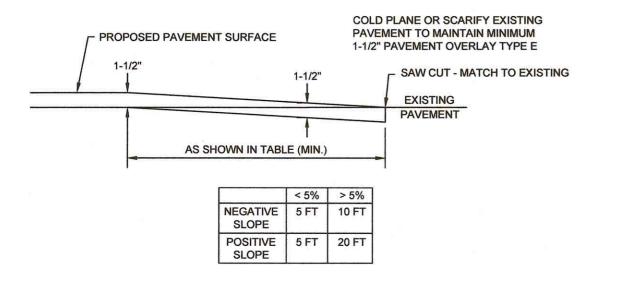
NOT TO SCALE




PAVEMENT END MATCH DETAIL

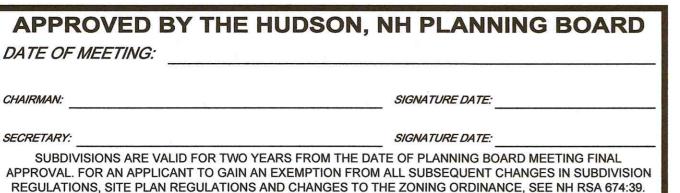

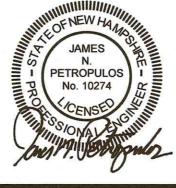

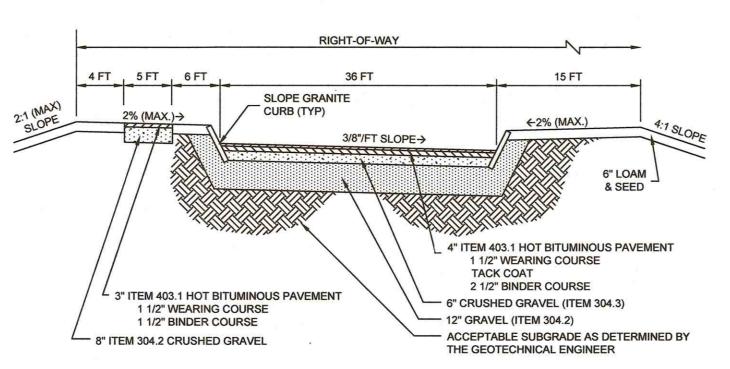


TYPICAL SECTION - CUL-DE-SAC

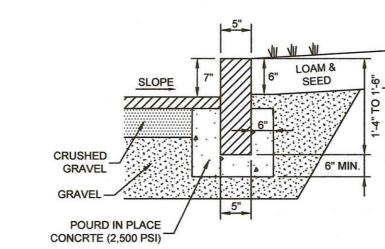


STRAIGHT OR CURVED **VERTICAL GRANITE CURB DETAIL**

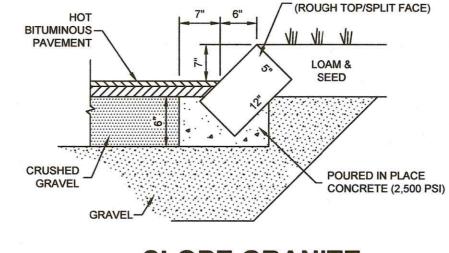
(ITEM 609.1 OR 609.2-MODIFIED)



SLOPE GRANITE CURB DETAIL

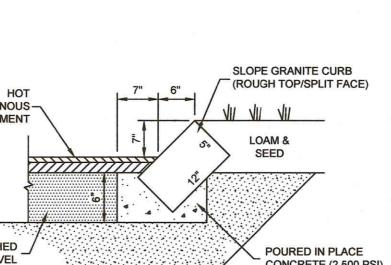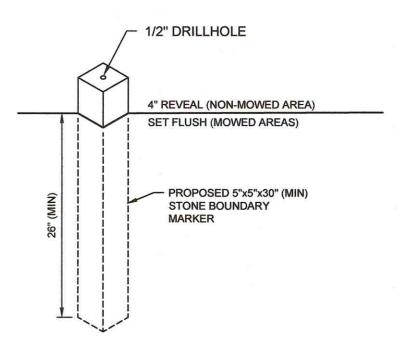NOT TO SCALE






STONE BOUND DETAIL


THE CONTRACTOR SHALL SUBMIT SHOP DRAWINGS FOR ROADWAY CONSTRUCTION ITEMS TO THE PROJECT ENGINEER AND TOWN ENGINEER FOR REVIEW AND APPROVAL PRIOR TO CONSTRUCTION

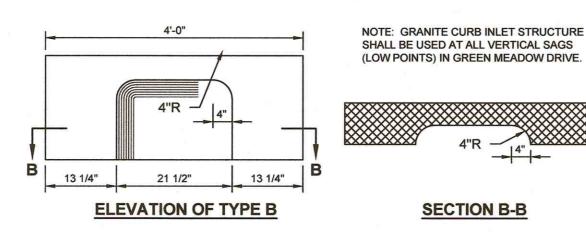FILL MATERIAL FOR THE ROADWAY CONSTRUCTION SHALL BE FROM AN ON-SITE SOURCE. ANY OFF-SITE FILL MATERIAL, IF NEEDED FOR THE ROADWAY CONSTRUCTION, SHALL BE FURNISHED AND INSTALLED IN ACCORDANCE WITH THE TOWN OF HUDSON ENGINEERING DEPARTMENT ENGINEERING TECHNICAL GUIDELINES AND TYPICAL DETAILS, LATEST EDITION




TO BE USED WITH CATCH BASIN TYPE B AND DROP INLET TYPE B
IF CALLED FOR ON THE PLANS

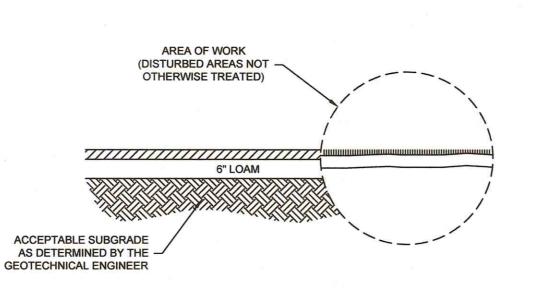GRANITE CURB INLET DETAIL




LOAM AND SEED DETAIL 'A'

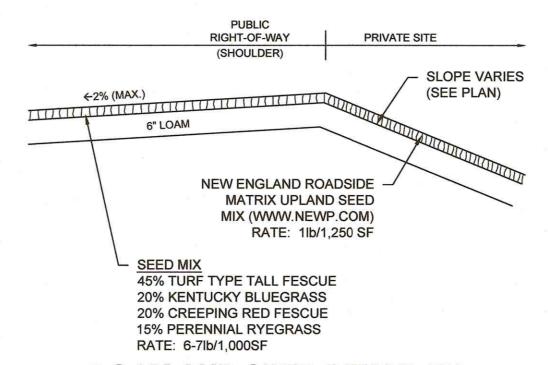

LOAM AND SEED DETAIL 'B'

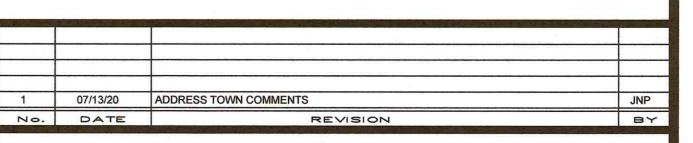NOT TO SCALE



DETAIL SHEET - GENERAL SITE (MAP 234, LOTS 5, 34 & 35 AND MAP 239. LOT 1) LOWELL AND STEELE ROADS HUDSON, NEW HAMPSHIRE

PREPARED FOR: LANGAN 888 BOYLSTON STREET BOSTON, MASSACHUSETTS 02116 (617) 824-9100

RECORD OWNERS:

GREENMEADOW GOLF CLUB, INC.,
THOMAS P. FRIEL & PHILIP J. FRIEL, III

55 MARSH ROAD HUDSON, NEW HAMPSHIRE 03051 (603) 882-8893 and 267 LOWELL RD HUDSON, LLC c/o RAM MNGT CO., LLC 200 US RTE 1, STE 200 SCARBOROUGH, ME 04070

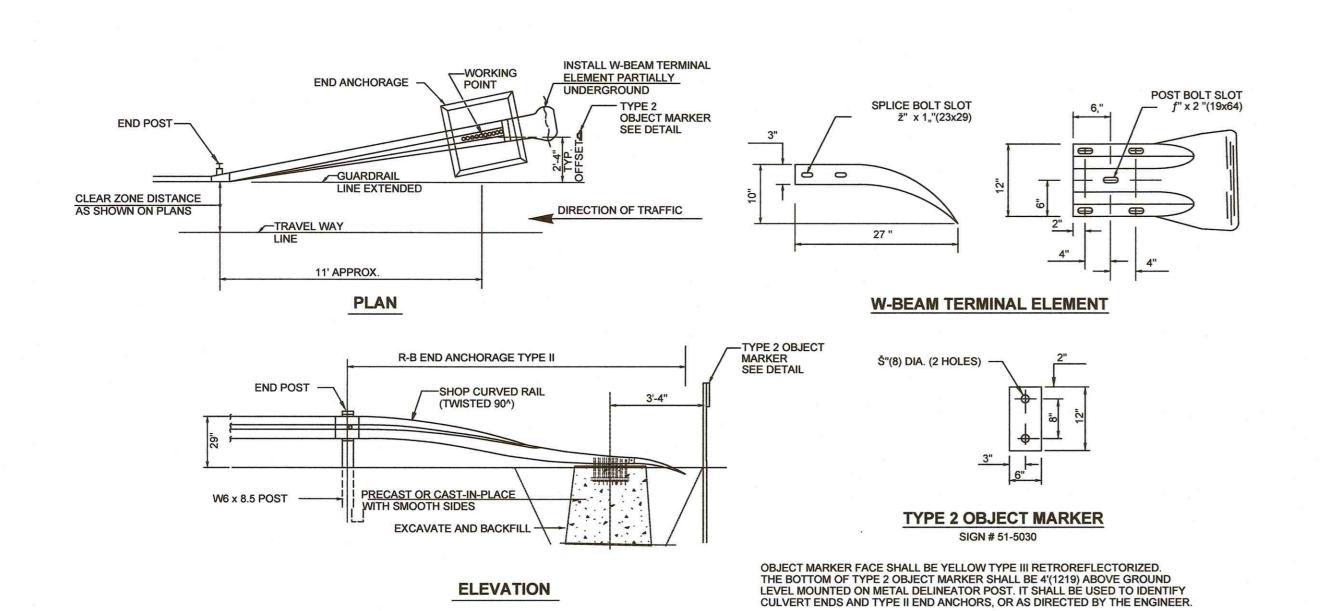
SCALE AS SHOWN

21 APRIL 2020





131 Middlesex Turnpike Burlington, MA 01803 (781) 203-1501 3 Congress Street Nashua, NH 03062 (603) 883-2057 www.haynerswanson.com

FIELD BOOK: --DRAWING NAME: 3867L-DET1 13 OF 22 3867L DRAWING LOC: J: \3000\3867\DWG\3867L SITE File Number



GUARDRAIL DETAILS

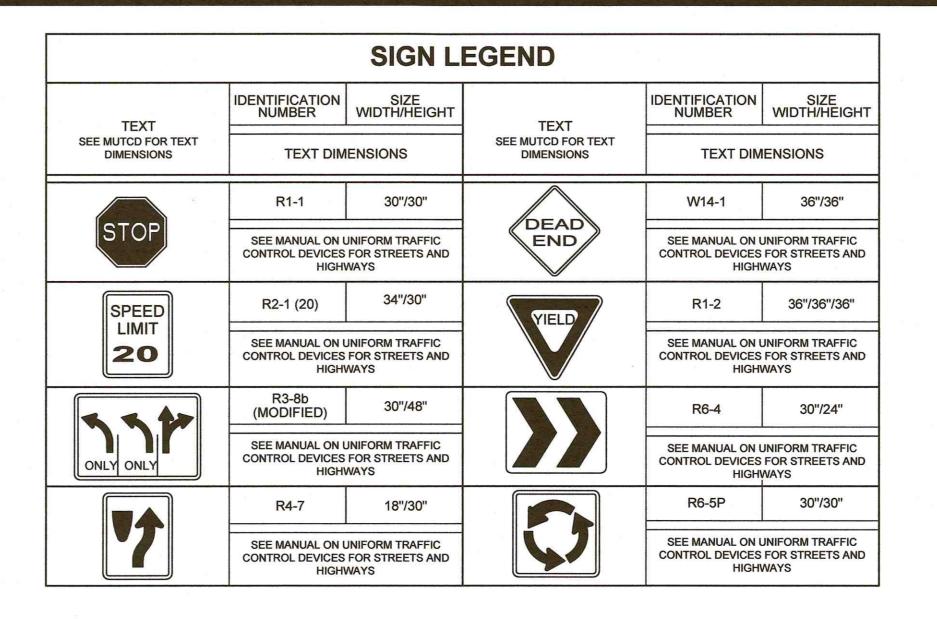

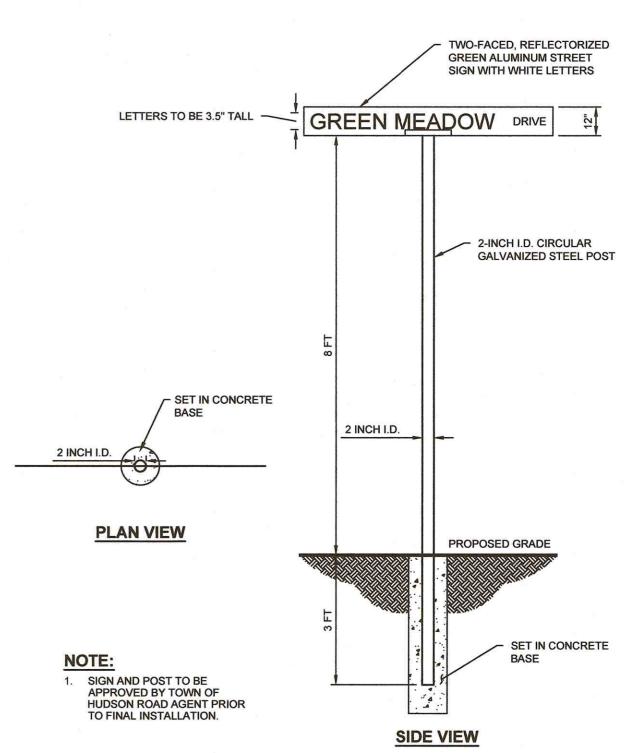

STREET SIGN AND POST

07/13/20 ADDRESS TOWN COMMENTS

REVISION

LOWELL AND STEELE ROADS JDSON, NEW HAMPSHIRE

PREPARED FOR: LANGAN

888 BOYLSTON STREET BOSTON, MASSACHUSETTS 02116 (617) 824-9100

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and 267 LOWELL RD HUDSON, LLC

c/o ram mngt co., llc 200 us rte 1, ste 200 scarborough, me 04070

SCALE AS SHOWN

21 APRIL 2020

3867L

File Number Sheet

14 OF 22

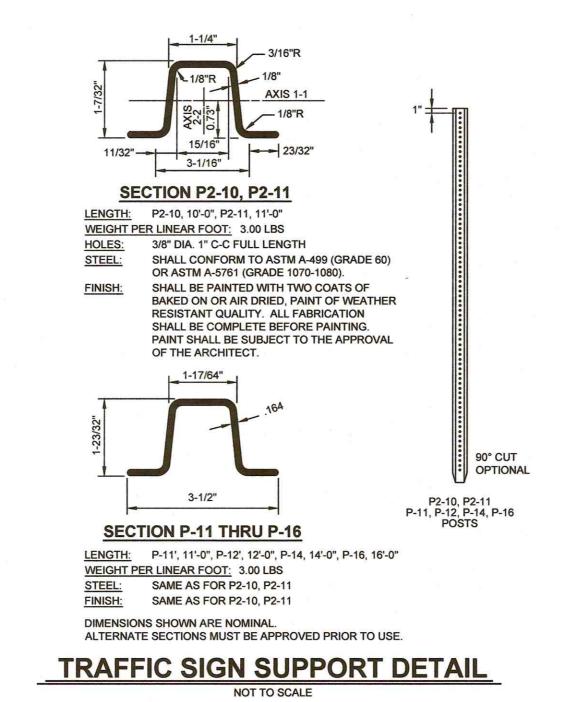
DETAIL SHEET - GENERAL SITE (MAP 234, LOTS 5, 34 & 35 AND MAP 239. LOT 1)

No. DATE

HUDSON,

4" x 6" I-BEAM POST 8.5 LB./FT. OR 9.0 LB./FT. 5'-9" LONG - 4" x 6" I-BEAM OFFSET BLOCK C STEEL BEAM GRADE **GUARDRAIL MATERIAL AND INSTALLATION SHALL** MEET THE REQUIREMENTS OF SECTION 606 OF THE NHDOT STANDARD SPECIFICATIONS FOR ROAD SIDE VIEW


STEEL POST GUARDRAIL DETAIL




© OF DRIVEWAY OR STREET

THERMOPLASTIC STOP BAR

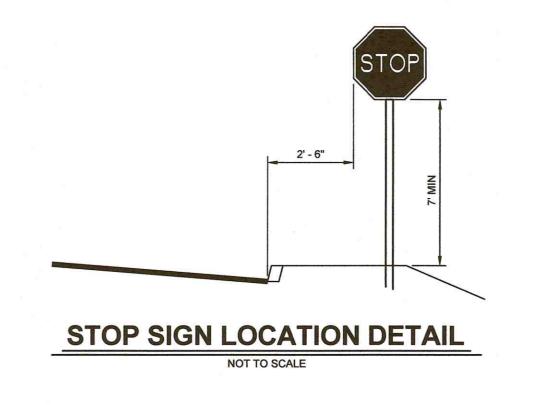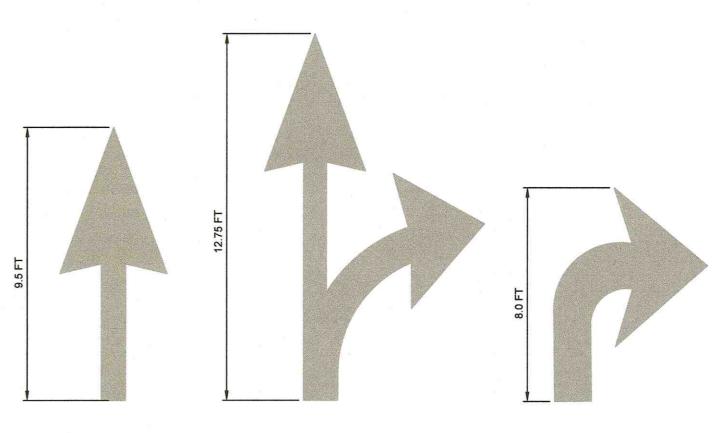TO BE TRAFFIC WHITE






1. ALL FLOW ARROWS TO BE SOLID WHITE REFLECTIVE TRAFFIC PAINT AS PER DIMENSIONS SHOWN. 2. REVERSE ARROWS FOR OPPOSITE DIRECTIONS OF FLOW.


PAINTED TRAFFIC ARROWS DETAIL


APPROVED BY THE HUDSON, NH PLANNING BOARD DATE OF MEETING:

SIGNATURE DATE:

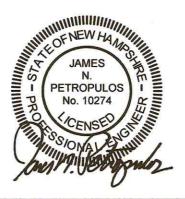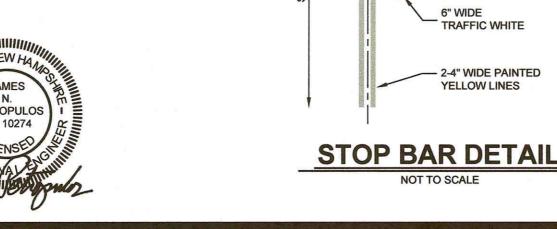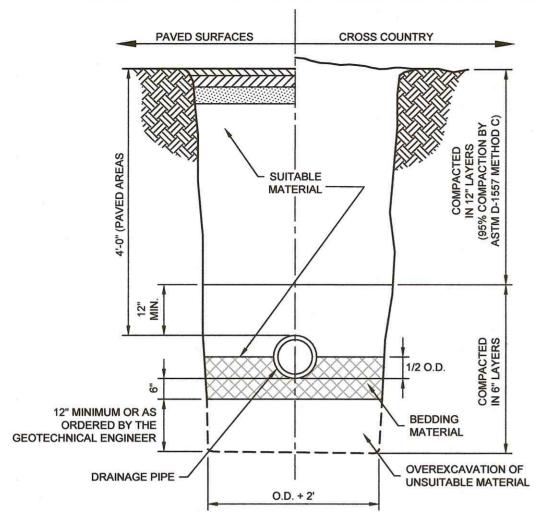SECRETARY: SIGNATURE DATE: SUBDIVISIONS ARE VALID FOR TWO YEARS FROM THE DATE OF PLANNING BOARD MEETING FINAL APPROVAL. FOR AN APPLICANT TO GAIN AN EXEMPTION FROM ALL SUBSEQUENT CHANGES IN SUBDIVISION REGULATIONS, SITE PLAN REGULATIONS AND CHANGES TO THE ZONING ORDINANCE, SEE NH RSA 674:39.








BEDDING MATERIAL:

STONE 1/2 TO 3/4 INCH SHALL BE USED.

BEDDING SCREENBED GRAVEL AND/OR CRUSHED STONE FREE FROM CLAY, LOAM, ORGANIC MATTER AND MEETING ASTM C33, STONE SIZE #67 100% PASSING 1 INCH SCREEN 90-100% PASSING 3/4 INCH SCREEN 20-50% PASSING 3/8 INCH SCREEN 0-10% PASSING #4 SIEVE 0-5% PASSING #8 SIEVE WHERE ORDERED BY THE ENGINEER TO STABILIZE THE TRENCH BASE. GRADED SCREENED GRAVEL OR CRUSHED

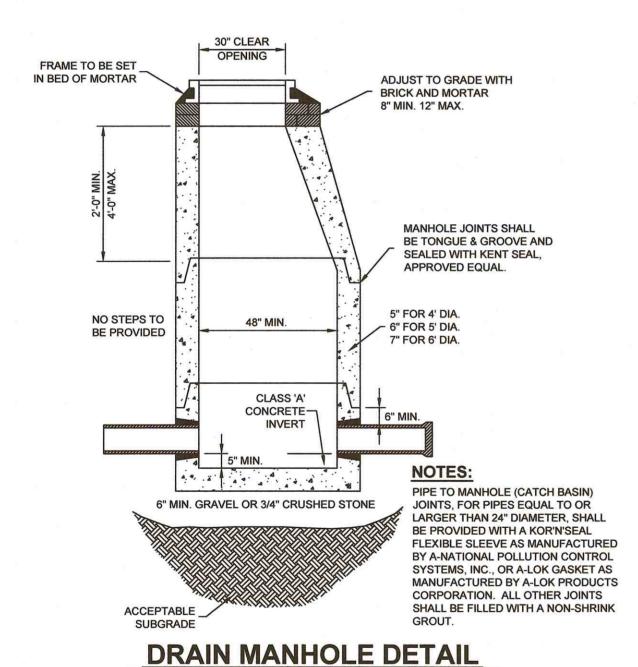TYPICAL DRAINAGE TRENCH SECTION




APPROVED BY THE HUDSON, NH PLANNING BOARD

SUBDIVISIONS ARE VALID FOR TWO YEARS FROM THE DATE OF PLANNING BOARD MEETING FINAL

APPROVAL. FOR AN APPLICANT TO GAIN AN EXEMPTION FROM ALL SUBSEQUENT CHANGES IN SUBDIVISION REGULATIONS, SITE PLAN REGULATIONS AND CHANGES TO THE ZONING ORDINANCE, SEE NH RSA 674:39.

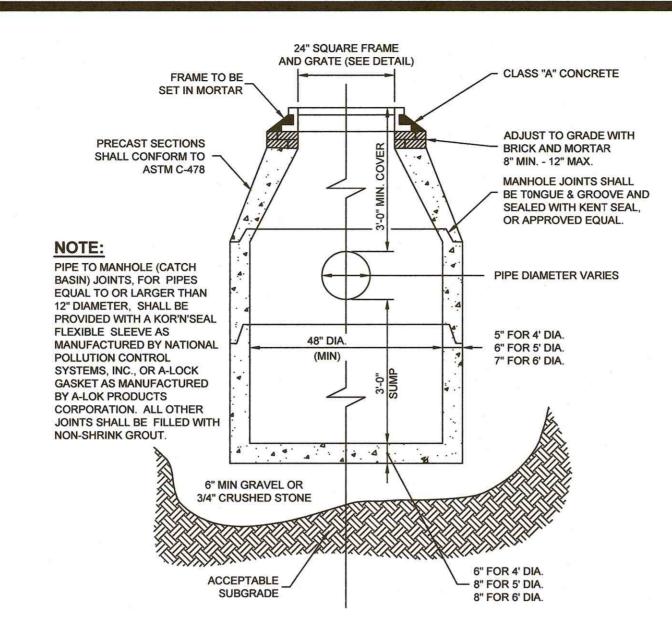SIGNATURE DATE:




CATCH BASIN DETAIL

NOT TO SCALE '4 WATERWAY **SECTION A-A** OPENING 2.55 SQ. FT. **GRATE TO BE** CAST IRON CAST IRON FRAME AND GRATE TO BE NHDOT TYPE 'B'


CATCH BASIN - TYPE B FRAME AND COVER DETAIL (NHDOT STANDARD) NOT TO SCALE

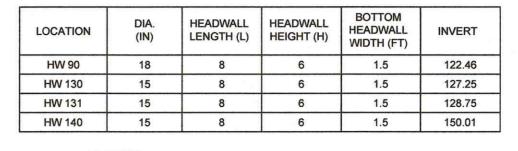SECTION B-B



NOTES:

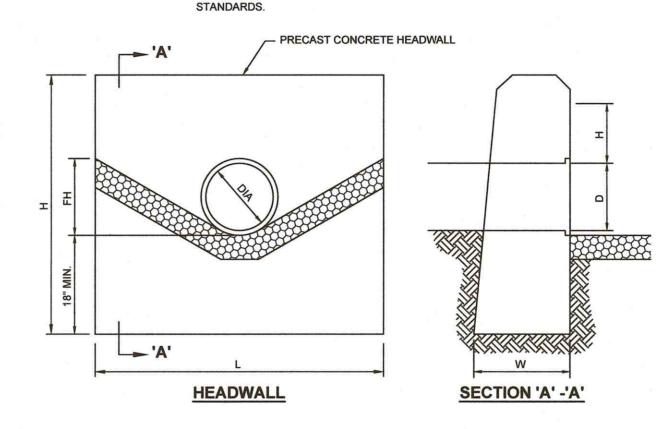
- 1. ALL DIMENSIONS GIVEN IN FEET EXCEPT PIPE DIAMETER.
- 2. PROVIDED BELL END AT INLET HEADWALL, AND SPIGOT END AT OUTLET END WALL.
- 3. OUTLET PROTECTION SHALL BE DESIGNED AS PER NHDOT




HEADWALL DETAIL NOT TO SCALE

RIPRAP OUTLET PROTECTION SPECIFICATION TABLE

LOCATION	WIDTH (FT)	LENGTH (FT)	DEPTH (IN)	d 50 (IN)	MATERIAL
CES 1	16	20	12	6	ITEM 585.3 STONE FILL CLASS C
HW 130	10	15	12	6	ITEM 585.3 STONE FILL CLASS C
HW 140	9	14	12	6	ITEM 585.3 STONE FILL CLASS C
			WIDTH		

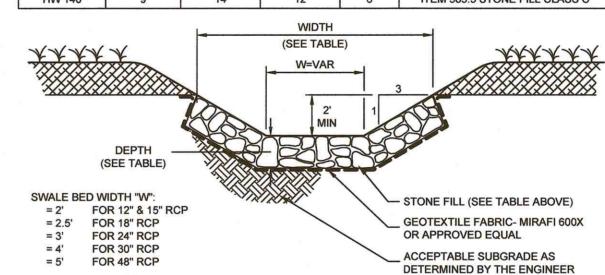

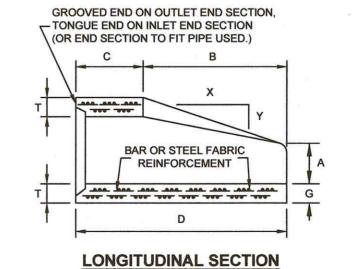RIPRAP DETAIL AT **HEADWALL/OUTLET DETAIL**



SLOPE DETAIL

DESIGN OF END SECTION SHALL CONFORM TO

CULVERT

PLANNED CULVERT LENGTH

DIA.	WEIGHT PER SECTION	APPROX. SLOPE X to Y	А	В	С	D	E	G	R	Т
12"	530	3 TO 1	4"	24"	48 7/8"	72 7/8"	24"	2"	1 1/2"	2"
15"	740	3 TO 1	6"	27"	46"	73	30"	2 1/4"	1 1/2"	2 1/4"
18"	990	3 TO 1	9"	27"	46"	73	36"	2 1/2"	1 1/2"	2 1/2"
24"	1520	3 TO 1	9 1/2"	43 1/2"	30"	73 1/2"	48"	3"	1 1/2"	3"

CONCRETE END SECTION FOR R.C.P.

PETROPULOS No. 10274

PLAN

END VIEW

DRAINAGE PIPE, STRUCTURES AND APPURTENANCES SHALL COMPLY WITH THE LATEST EDITION

OF THE TOWN OF HUDSON ENGINEERING DEPARTMENT - ENGINEERING TECHNICAL GUIDELINES

AND TYPICAL DETAILS. THE CONTRACTOR SHALL SUBMIT SHOP DRAWINGS TO THE PROJECT

ALL DRAINAGE PIPES SHALL BE CLASS IV 3000D (RCP) UNLESS OTHERWISE NOTED. CATCH BASINS

ALL DRAINAGE PIPE SHALL BE FURNISHED AND INSTALLED WITH FLEXIBLE GASKETS. JOINTS SHALL BE MADE WITH OIL RESISTANT COMPRESSION RINGS OF AN ELASTOMERIC MATERIAL CONFORMING

PRIOR TO CONSTRUCTION THE CONTRACTOR SHALL SUBMIT SHOP DRAWINGS OF ALL DRAINAGE

ENGINEER AND TOWN ENGINEER FOR REVIEW AND APPROVAL PRIOR TO CONSTRUCTION.

TO ASTM C-443. MANUFACTURER'S INSTALLATION INSTRUCTIONS SHALL BE FOLLOWED.

SHALL BE TYPE 'B' AND HAVE A 3 FT SUMPS UNLESS OTHERWISE NOTED.

STRUCTURES AND PIPE TO THE ENGINEER FOR REVIEW AND APPROVAL.

DRAINAGE NOTES:

07/13/20 ADDRESS TOWN COMMENTS No. DATE REVISION

DETAIL SHEET - GENERAL SITE (MAP 234, LOTS 5, 34 & 35 AND MAP 239. LOT 1) LOWELL AND STEELE ROADS JDSON, NEW HAMPSHIRE HUDSON, PREPARED FOR: LANGAN

888 BOYLSTON STREET BOSTON, MASSACHUSETTS 02116 (617) 824-9100

RECORD OWNERS:

GREENMEADOW GOLF CLUB, INC.,
THOMAS P. FRIEL & PHILIP J. FRIEL, III

55 MARSH ROAD HUDSON, NEW HAMPSHIRE 03051 (603) 882-8893 and 267 LOWELL RD HUDSON, LLC

c/o ram mngt co., llc 200 us rte 1, ste 200 scarborough, me 04070

SCALE AS SHOWN

21 APRIL 2020

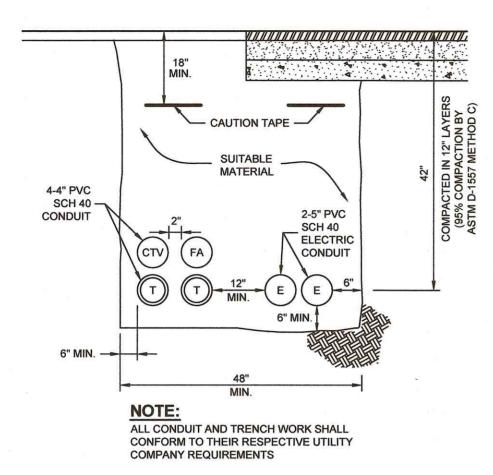


Civil Engineers/Land Surveyors
Street 131 Middlesex Turnpike
! 03062 Burlington, MA 01803
-2057 (781) 203-1501 3 Congress Street Nashua, NH 03062 (603) 883-2057 www.hayner-swanson.com

FIELD BOOK: --DRAWING NAME: 3867L-DET1 3867L 15 OF 22 DRAWING LOC: J: \3000\3867\DWG\3867L SITE

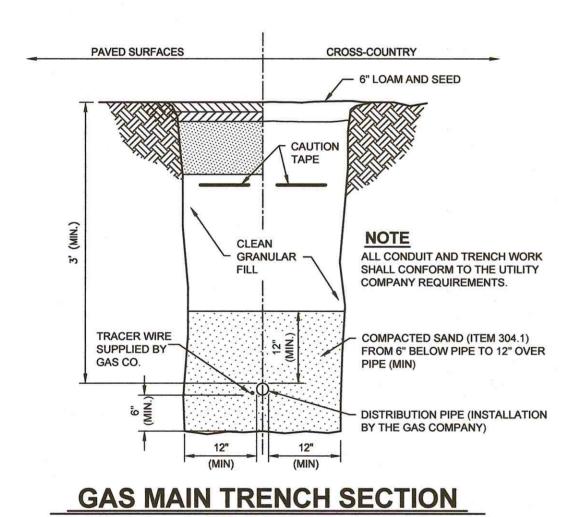
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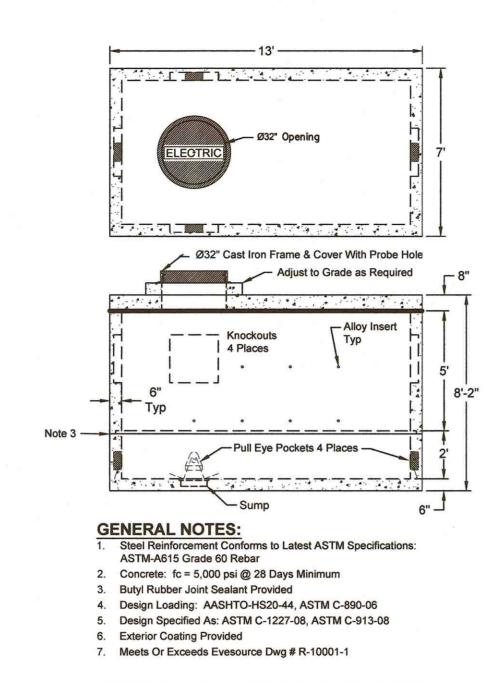
DATE OF MEETING:



TYPICAL UTILITY TRENCH SECTION

NOT TO SCALE







POWER MANHOLE DETAIL

NOT TO SCALE

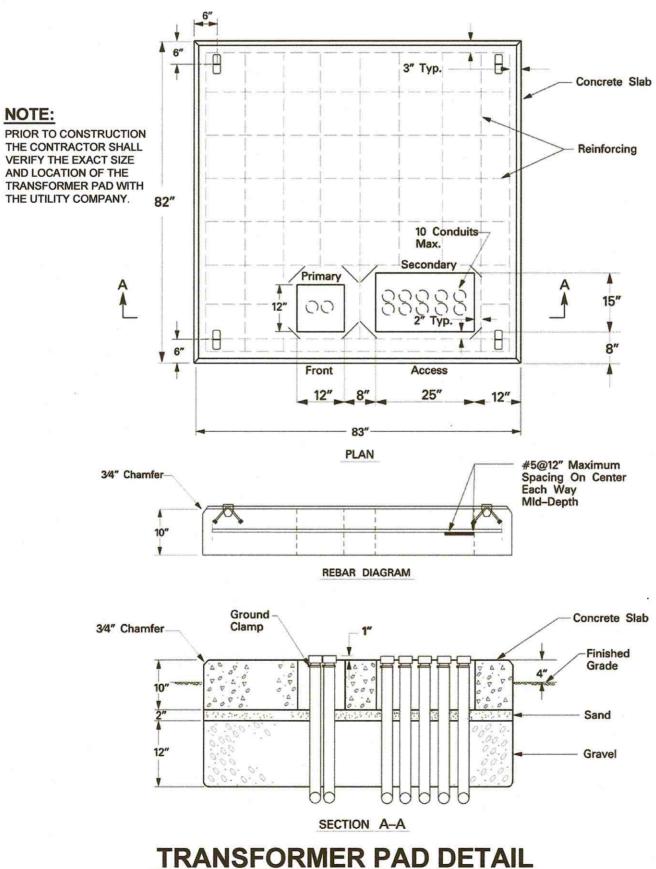Figure 27.0-2 15kV Transformer Pad 750- 2500kVA 44-114 (ref-44-114/UF8B)



NOT TO SCALE

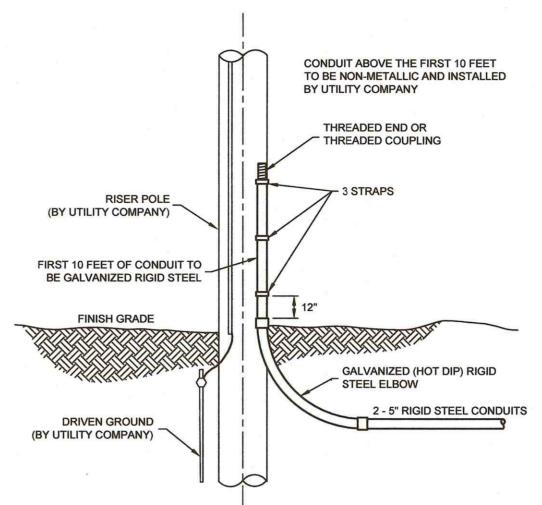

NOTES:

- LOCATE RISE ON POLE AWAY FROM TRAFFIC.
- 2. TELEPHONE RISER PIPE DETAIL IS SAME EXCEPT: CONDUIT MATERIAL IS 4" PVC BELOW GROUND, AND 4" RIGID STEEL ABOVE GROUND.

ELECTRIC RISER PIPE INSTALLATION DETAIL

POWER NOTES:

- ALL POWER RELATED WORK SHALL COMPLY WITH EVERSOURCE STANDARDS AND SPECIFICATIONS.
- THE UTILITY POLE AND OVERHEAD WIRE LOCATIONS ARE APPROXIMATE. THE CONTRACTOR SHALL COORDINATE FINAL LOCATIONS WITH EVERSOURCE PRIOR TO ANY POWER/TELEPHONE WORK.

GAS NOTE:

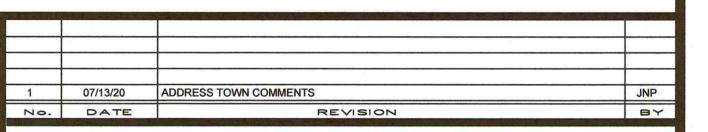
THE DEVELOPER SHALL COORDINATE THE EXACT SIZE AND LOCATION OF THE NATURAL GAS MAIN AND SERVICES WITH LIBERTY UTILITIES.

TELECOMMUNICATIONS NOTE:

ALL TELECOMMUNICATIONS RELATED WORK SHALL COMPLY WITH CONSOLIDATED COMMUNICATIONS STANDARDS AND SPECIFICATIONS. ALL TELECOMMUNICATIONS LINE LOCATIONS ARE APPROXIMATE AND SHOWN FOR COORDINATION PURPOSES ONLY.

ROADWAY LIGHTING NOTE:

UPON ACCEPTANCE OF GREEN MEADOW DRIVE BY THE HUDSON BOARD OF SELECTMAN (WITH DPW ENGINEERING DEPARTMENT RECOMMENDATIONS) THE ROADWAY LIGHTING SYSTEM SHALL BECOME THE RESPONSIBILITY OF THE TOWN OF HUDSON.



DETAIL SHEET - GENERAL SITE (MAP 234, LOTS 5, 34 & 35 AND MAP 239. LOT 1) LOWELL AND STEELE ROADS HUDSON, NEW HAMPSHIRE

PREPARED FOR: LANGAN

888 BOYLSTON STREET BOSTON, MASSACHUSETTS 02116 (617) 824-9100

RECORD OWNERS:

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55 MARSH ROAD HUDSON, NEW HAMPSHIRE 03051 (603) 882-8893 and 267 LOWELL RD HUDSON, LLC

c/o RAM MNGT CO., LLC 200 US RTE 1, STE 200 SCARBOROUGH, ME 04070

SCALE AS SHOWN


21 APRIL 2020



3 Congress Street Nashua, NH 03062 (603) 883-2057


DRAWING NAME: 3867L-DET1 FIELD BOOK: --16 OF 22 3867L DRAWING LOC: J: \3000\3867\DWG\3867L SITE File Number Sheet

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REGULATIONS, SITE PLAN REGULATIONS AND CHANGES TO THE ZONING ORDINANCE, SEE NH RSA 674:39.

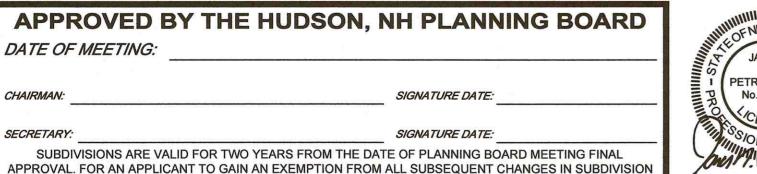



DUCTILE IRON PIPE -

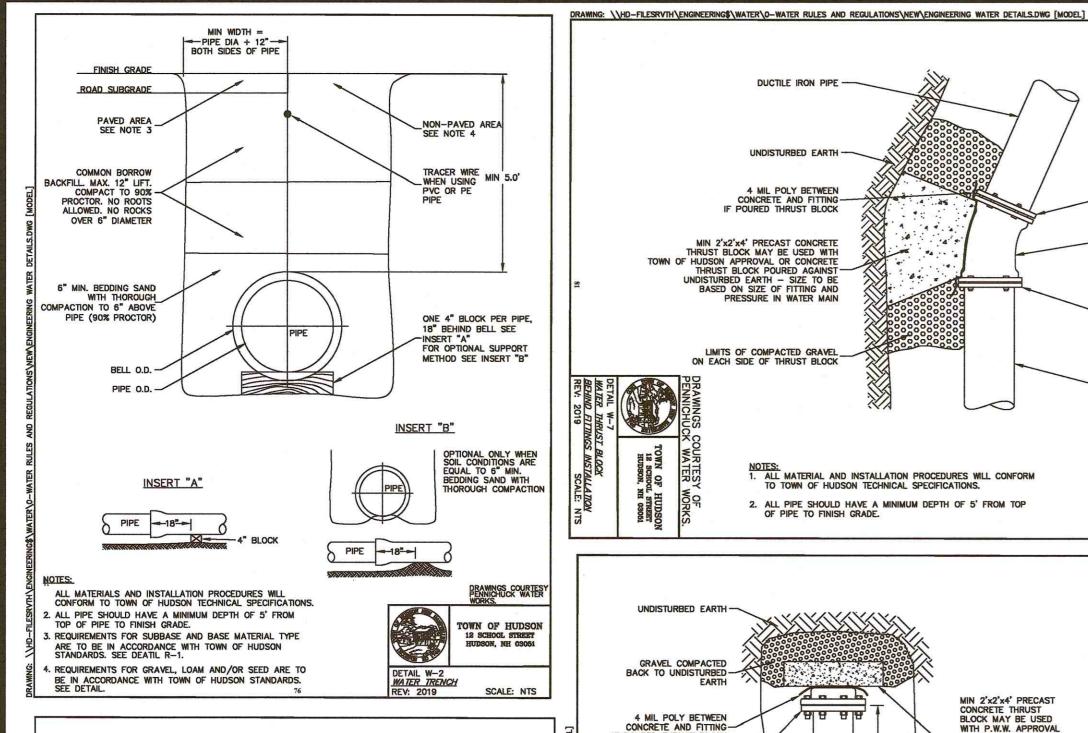MEGALUG GLAND -

SEE NOTE 4

WATER TEE INSTALLATION REV: 2019 SCALE: NTS

2 - 3/4" DIA STAINLESS STEEL THREADED RODS SEE NOTE 3

TOWN OF HUDSON

MECHANICAL JOINT RESILIENT SEAT —GATE VALVE WITH BOX TO SURFACE —

(OPEN LEFT). SEE DETAIL W-9

NOTES:

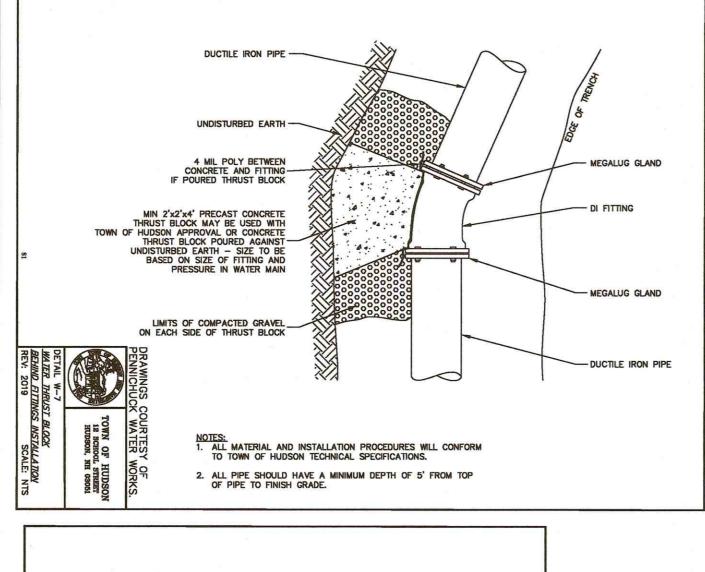
1. ALL MATERIAL AND INSTALLATION PROCEDURES WILL CONFORM TO TOWN OF HUDSON TECHNICAL SPECIFICATIONS.

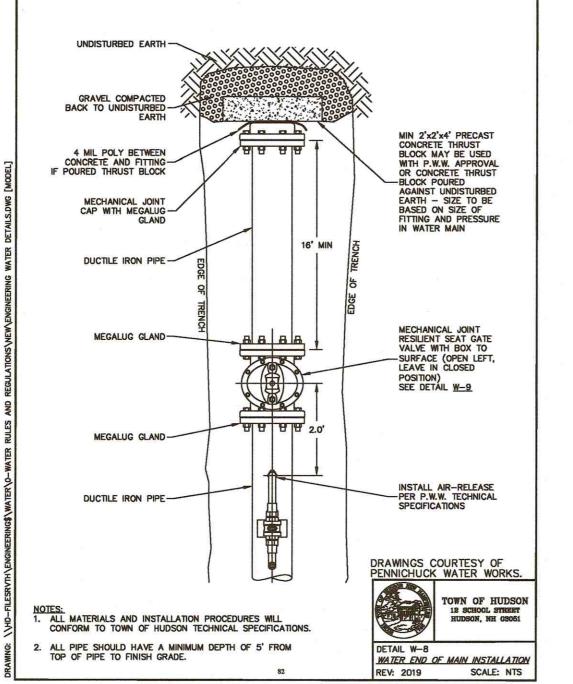
3. ALL THREADED RODS AND NUTS MUST BE STAINLESS STEEL.

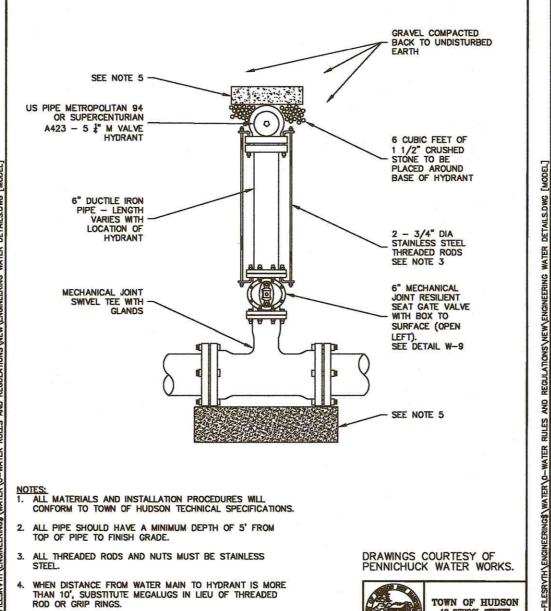
. ALL PIPE SHOULD HAVE A MINIMUM DEPTHS OF 5' FROM TOP OF

. MIN 2'x2'x4' PRECAST CONCRETE THRUST BLOCK MAY BE USED WITH P.W.W. APPROVAL OR CONCRETE THRUST BLOCK POURED AGAINST UNDISTURBED EARTH — SIZE TO BE BASED ON SIZE OF FITTING AND PRESSURE IN WATER MAIN. SEE DETAIL W—7.


DUCTILE IRON PIPE








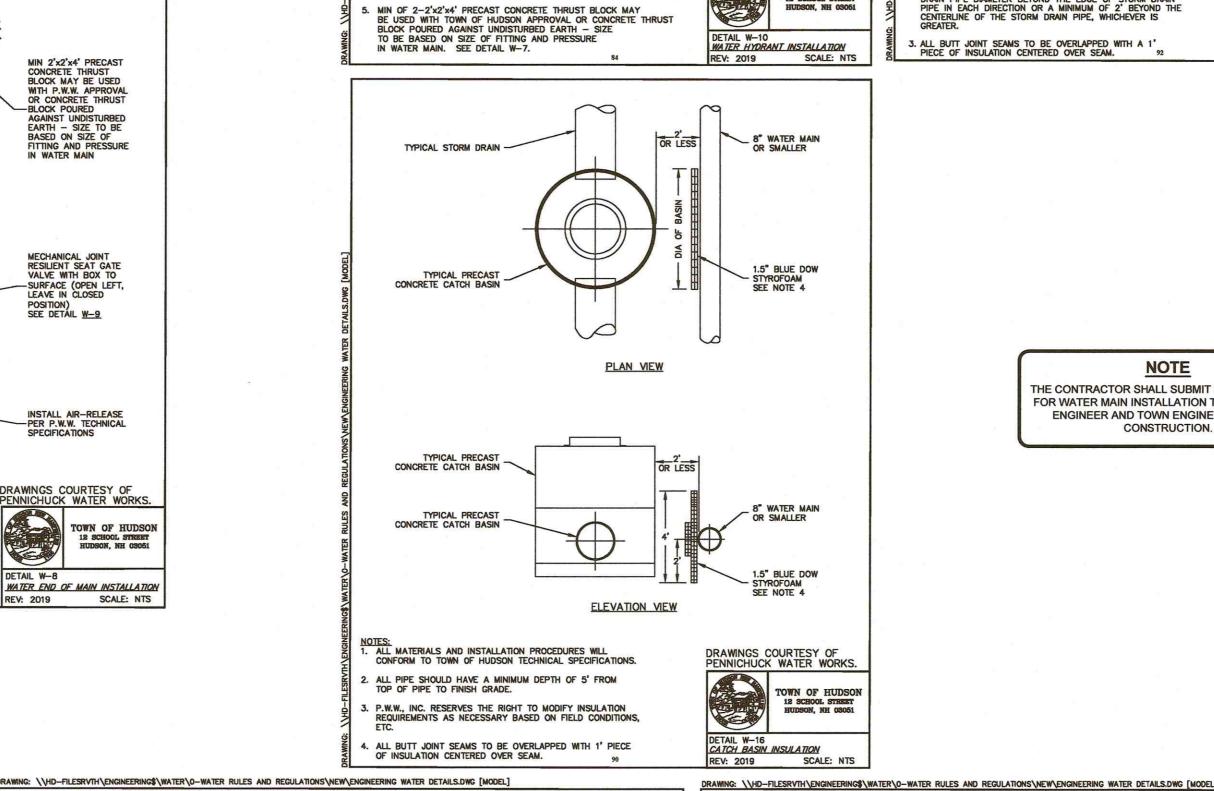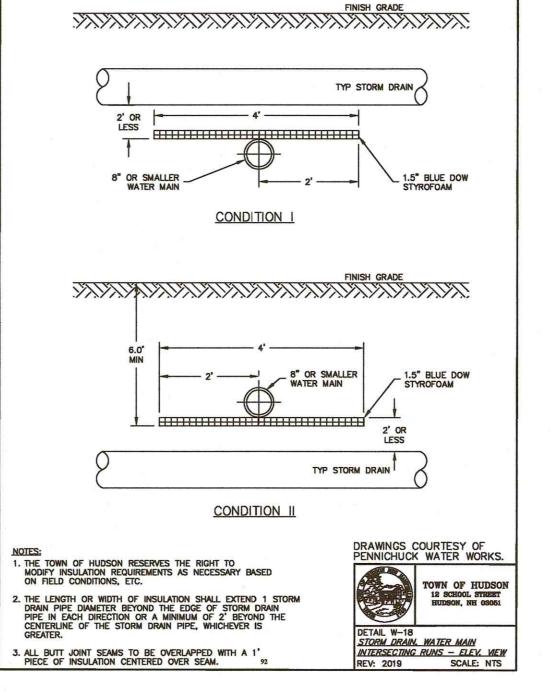TOWN OF HUDSON 12 SCHOOL STREET HUDSON, NH 03061





NOTE

THE CONTRACTOR SHALL SUBMIT SHOP DRAWINGS

FOR WATER MAIN INSTALLATION TO THE PROJECT

ENGINEER AND TOWN ENGINEER PRIOR TO

CONSTRUCTION.

BETWEEN WATER SERVICE AND UTILITIES OTHER THAN SANITARY SEWER. INSPECTIONS ON WATER SERVICE INSTALLATION DURING CONSTRUCTION IS THE RESPONSIBILITY OF THE SITE INSPECTION FEES SHALL BE PAID BY THE CONTRACTOR.

HYDRANTS, SEE DETAIL

4. MINIMUM COVER ON ALL WATER LINES IS 5'-0".

CONTRACTOR AND SHALL BE COORDINATED WITH TOWN OF HUDSON ENGINEERING DEPARTMENT, AND ALL 7. CONTRACTOR SHALL HAVE BACTERIOLOGICAL AND PRESSURE TESTING PERFORMED. CONTRACTOR SHALL GIVE THE

WATER NOTES:

TYPICAL DETAILS, LATEST EDITION, FOR WATER MAIN INSTALLATION REQUIREMENTS.

HUDSON WATER UTILITY A COPY OF RESULTS. TOWN OF HUDSON ENGINEERING DEPARTMENT SHALL BE ON-SITE TO

THE CONTRACTOR SHALL REFER TO THE TOWN OF HUDSON ENGINEERING DEPARTMENT TECHNICAL GUIDELINES AND

2. THRUST BLOCKS AND MEGALUG RESTRAINTS SHALL BE PROVIDED AT ALL HORIZONTAL BENDS, TEES, AND FIRE

5. CONTRACTOR SHALL MAINTAIN A 5'-0" HORIZONTAL (UNLESS OTHERWISE NOTED) AND 12" VERTICAL SEPARATION

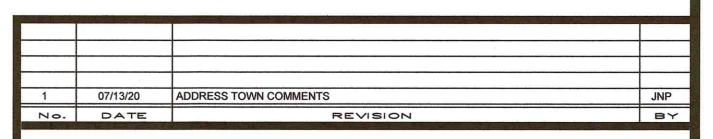
8. ALL PIPE, VALVES, MISCELLANEOUS MATERIALS AND INSTALLATION SHALL CONFORM WITH TOWN OF HUDSON ENGINEERING DEPARTMENT SPECIFICATIONS.

9. ALL FIRE HYDRANTS, VALVES, FITTINGS, PIPES, ETC. SHALL BE IN ACCORDANCE WITH TOWN OF HUDSON ENGINEERING DEPARTMENT REQUIREMENTS.

10. METALLIC TAPE OR DETECTOR WIRE SHALL BE INSTALLED IN THE SAME TRENCH WITH ALL NONMETALLIC PIPE SUCH THAT THE PIPE MAY BE LOCATED WITH ELECTRONIC LOCATING EQUIPMENT. DETECTOR WIRE OR METALLIC TAPE SHALL BE INSTALLED APPROXIMATELY 12" TO 18" BELOW GRADE DIRECTLY ABOVE THE TOP OF THE PIPE. DETECTOR WIRE SHALL BE 14 - GAUGE SOLID COPPER, SIMPLEX BW3001, OR EQUAL. METALLIC TAPE SHALL BE 2" MINIMUM METALIZED TAPE, GRIFFOLYN COMPANY, INC. TERRATAPE OR EQUAL.

11. CONTRACTOR SHALL ENSURE ALL WATER VALVES ARE IN A FULLY-OPEN POSITION UPON COMPLETION OF PROJECT.

12. CONTRACTOR SHALL COORDINATE ALL WATER INTERRUPTIONS WITH THE HUDSON WATER UTILITY AND AFFECTED PROPERTY OWNERS. THE CONTRACTOR SHALL BE RESPONSIBLE FOR MINIMIZING DISRUPTIONS TO ABUTTING PROPERTIES AND FOR MAINTAINING SERVICE TO LOT 35, MAP 234 (FIRE AND DOMESTIC). TEMPORARY WATER CONNECTIONS MAY BE NEEDED.



DETAIL SHEET - WATER (MAP 234, LOTS 5, 34 & 35 AND MAP 239. LOT 1) LOWELL AND STEELE ROADS HUDSON, NEW HAMPSHIRE PREPARED FOR: LANGAN

888 BOYLSTON STREET BOSTON, MASSACHUSETTS 02116 (617) 824-9100

RECORD OWNERS:

GREENMEADOW GOLF CLUB, INC.,
THOMAS P. FRIEL & PHILIP J. FRIEL, III

55 MARSH ROAD HUDSON, NEW HAMPSHIRE 03051 (603) 882-8893 and 267 LOWELL RD HUDSON, LLC
c/o RAM MNGT CO., LLC 200 US RTE 1, STE 200 SCARBOROUGH, ME 04070


SCALE AS SHOWN

21 APRIL 2020




131 Middlesex Turnpike 3 Congress Street Nashua, NH 03062 Burlington, MA 01803 (603) 883-2057 (781) 203-1501 www.hayner-swanson.com


DRAWING NAME: 3867L-DET1 FIELD BOOK: --3867L 17 OF 22 DRAWING LOC: J: \3000\3867\DWG\3867L SITE

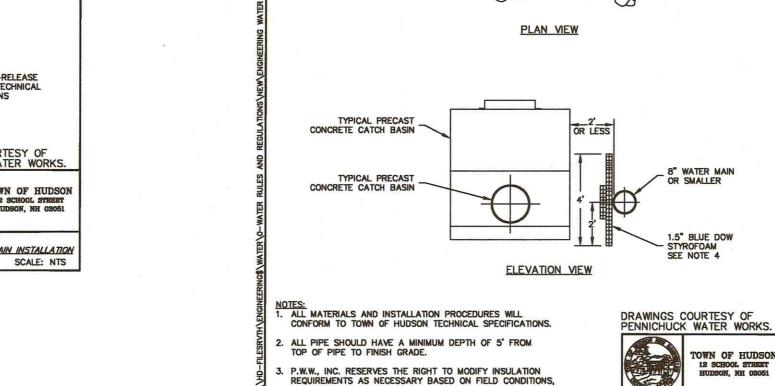


APPROVED BY THE HUDSON, NH PLANNING BOARD DATE OF MEETING: SIGNATURE DATE:

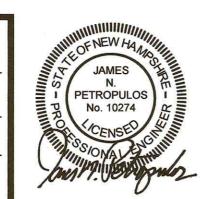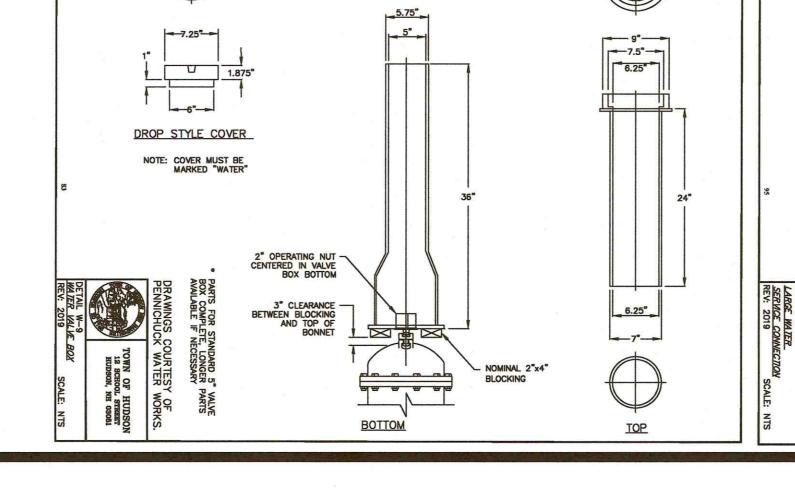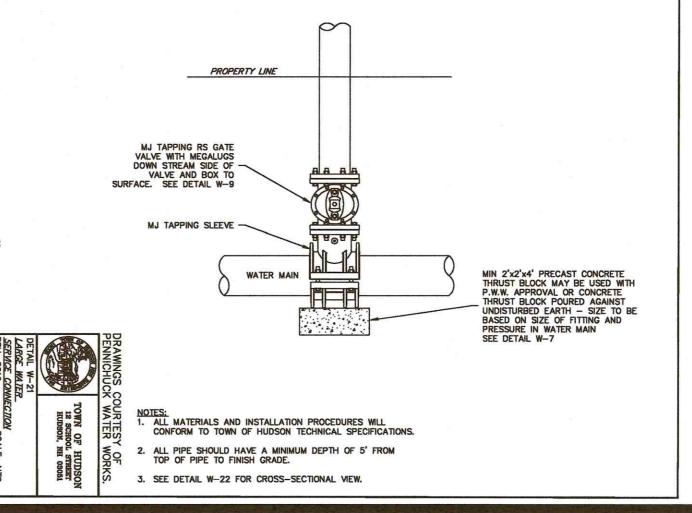SIGNATURE DATE:








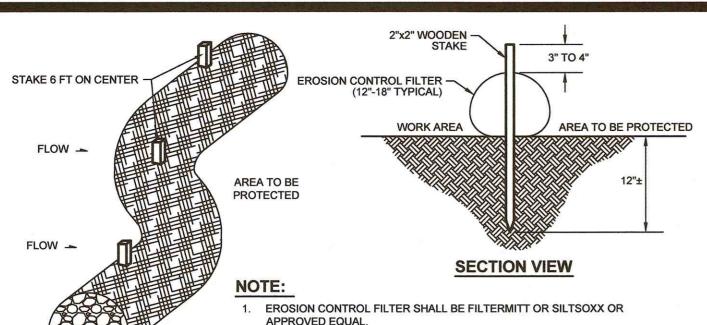SECRETARY: SUBDIVISIONS ARE VALID FOR TWO YEARS FROM THE DATE OF PLANNING BOARD MEETING FINAL APPROVAL. FOR AN APPLICANT TO GAIN AN EXEMPTION FROM ALL SUBSEQUENT CHANGES IN SUBDIVISION REGULATIONS, SITE PLAN REGULATIONS AND CHANGES TO THE ZONING ORDINANCE, SEE NH RSA 674:39.

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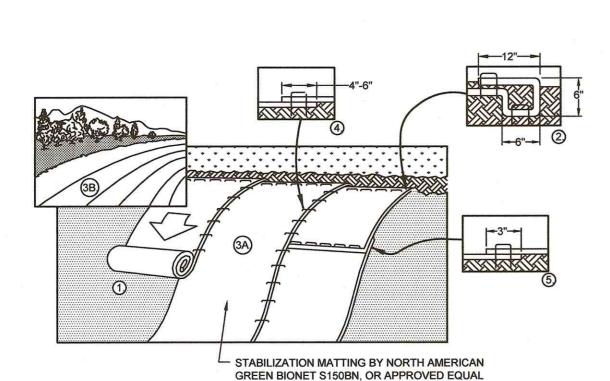
- 2. EROSION CONTROL FILTER SHALL BE INSTALLED IN ACCORDANCE WITH MANUFACTURER'S RECOMMENDATIONS.
- 3. COMPOST TO BE REMOVED OR DISPOSED ON-SITE AS DETERMINED BY THE ENGINEER.

MAINTENENCE

- . SILT SOCK BARRIER SHALL BE INSPECTED IMMEDIATELY AFTER EACH RAINFALL AND AT LEAST DAILY DURING PROLONGED RAINFALL, ANY REPAIRS THAT ARE REQUIRED SHALL BE MADE IMMEDIATELY.
- 2. IF THE SILT SOCK SHOULD DECOMPOSE OR BECOME INEFFECTIVE DURING THE EXPECTED LIFE OF THE FENCE, THE BARRIER SHALL BE REPLACED PROMPTLY.
- 3. SEDIMENT DEPOSITS SHOULD BE INSPECTED AFTER EVERY STORM EVENT. THE DEPOSITS SHOULD BE REMOVED WHEN THEY REACH APPROXIMATELY ONE-THIRD THE HEIGHT OF THE BARRIER
- I. SEDIMENT DEPOSITS THAT ARE REMOVED OR LEFT IN PLACE AFTER THE BARRIER HAS BEEN REMOVED SHALL BE GRADED TO CONFORM WITH THE EXISTING TOPOGRAPHY AND VEGETATED.

CONSTRUCTION SPECIFICATIONS

- 1. THE GEOTEXTILE FABRIC SHALL MEET THE DESIGN CRITERIA FOR SILT FENCES.
- 2. THE FABRIC SHALL BE <u>EMBEDDED A MINIMUM OF 8 INCHES INTO THE GROUND</u> AND THE SOIL COMPACTED OVER THE EMBEDDED FABRIC
- 3. WOVEN WIRE FENCE SHALL BE FASTENED SECURELY TO THE FENCE POSTS WITH WIRE TIES OR STAPLES.
- 4. FILTER CLOTH SHALL BE FASTENED SECURELY TO THE WOVEN WIRE FENCE WITH TIES SPACED EVERY 24 INCHES AT THE TOP, MID-SECTION, AND BOTTOM. 5. WHEN TWO SECTIONS OF FILTER CLOTH ADJOIN EACH OTHER, THEY SHALL BE OVERLAPPED BY 6 INCHES, FOLDED, AND
- 6. FENCE POSTS SHALL BE A MINIMUM OF 36 INCHES LONG AND DRIVEN A MINIMUM OF 16 INCHES INTO THE GROUND. WOOD POSTS SHALL BE OF SOUND QUALITY HARDWOOD AND SHALL HAVE A MINIMUM CROSS SECTIONAL AREA OF 3.0
- 7. MAINTENANCE SHALL BE PERFORMED AS NEEDED TO PREVENT BULGES IN THE SILT FENCE DUE TO DEPOSITION OF



- 1. PREPARE SOIL BEFORE INSTALLING BLANKETS, INCLUDING ANY NECESSARY APPLICATION OF LIME,
- 2. BEGIN AT THE TOP OF THE SLOPE BY ANCHORING THE BLANKET IN A 6" DEEP X 6" WIDE TRENCH WITH APPROXIMATELY 12" OF BLANKET EXTENDED BEYOND THE UP-SLOPE PORTION OF THE TRENCH. ANCHOR THE BLANKET WITH A ROW OF STAPLES/STAKES APPROXIMATELY 12" APART IN THE BOTTOM OF THE TRENCH, BACKFILL AND COMPACT THE TRENCH AFTER STAPLING. APPLY SEED TO COMPACTED SOIL AND FOLD REMAINING 12" PORTION OF BLANKET BACK OVER SEED AND COMPACTED SOIL. SECURE BLANKET OVER COMPACTED SOIL WITH A ROW OF STAPLES/STAKES SPACED
- APPROXIMATELY 12" APART ACROSS THE WIDTH OF THE BLANKET. 3. ROLL THE BLANKETS (A.) DOWN OR (B.) HORIZONTALLY ACROSS THE SLOPE. BLANKETS WILL UNROLL WITH APPROPRIATE SIDE AGAINST THE SOIL SURFACE. ALL BLANKETS MUST BE SECURELY FASTENED TO SOIL SURFACE BY PLACING STAPLES/STAKES IN APPROPRIATE LOCATIONS AS PER MANUFACTURES
- 4. 4. THE EDGES OF PARALLEL BLANKETS MUST BE STAPLED WITH MINIMUM 6" OVERLAP. TO ENSURE PROPER SEAM ALIGNMENT, PLACE THE EDGE OF THE OVERLAPPING BLANKET (BLANKET BEING INSTALLED ON TOP) EVEN WITH THE SEAM STITCH ON THE PREVIOUSLY INSTALLED BLANKET.
- 5. CONSECUTIVE BLANKETS SPLICED DOWN THE SLOPE MUST BE PLACED END OVER END (SHINGLE STYLE) WITH AN APPROXIMATE 3" OVERLAP. STAPLE THROUGH OVERLAPPED AREA, APPROXIMATELY 12" APART ACROSS ENTIRE BLANKET WIDTH.
- 6. PLACE STAPLES/STAKES PER MANUFACTURE RECOMMENDATION FOR THE APPROPRIATE SLOPE BEING

NOTE: IN LOOSE SOIL CONDITIONS, THE USE OF STAPLE OR STAKE LENGTHS GREATER THAN 6" MAY BE NECESSARY TO PROPERLY SECURE THE BLANKETS

STABILIZATION MATTING DETAIL

NOT TO SCALE

SIGNATURE DATE:

SIGNATURE DATE:

APPROVED BY THE HUDSON, NH PLANNING BOARD **PETROPULOS** No. 10274 SUBDIVISIONS ARE VALID FOR TWO YEARS FROM THE DATE OF PLANNING BOARD MEETING FINAL APPROVAL. FOR AN APPLICANT TO GAIN AN EXEMPTION FROM ALL SUBSEQUENT CHANGES IN SUBDIVISION REGULATIONS, SITE PLAN REGULATIONS AND CHANGES TO THE ZONING ORDINANCE, SEE NH RSA 674:39.



GRATE (SEE SEPARATE DETAIL)

#5 RE-BAR

- TOP OF EARTHEN BERM

TRANSITION EXISTING

CHANNEL INTO

MAX

1'-6" MIN FLOW -

SEDIMENT TRAP

6" MINIMUM FREEBOARD

— 6" (CENTER OF RIPRAP 6" LOWER THAN ENDS

SECTION B

WELL-GRADED

ANGULAR 2"-3"

CRUSHED STONE

FLOW -

SEDIMENT TRAP INSTALLATION NOTES:

- SEE PLAN VIEW FOR:
- 2. SEDIMENT TRAPS SHALL BE SIZED TO PROVIDE A VOLUME OF
- SEDIMENT TRAPS SHALL BE INSTALLED PRIOR TO ANY
- 4. SEDIMENT TRAP BERM SHALL BE CONSTRUCTED FROM MATERIAL FROM EXCAVATION, THE BERM SHALL BE
- ACCORDANCE WITH ASTM D698. SEDIMENT TRAP OUTLET TO BE CONSTRUCTED OF
- 6. THE TOP OF THE EARTHEN BERM SHALL BE A MINIMUM OF 6" HIGHER THAN THE TOP OF THE OUTLET STRUCTURE.
- OF 6" HIGHER THAN THE CENTER OF THE OUTLET

- 1. INSPECT BMPs EACH WORKDAY, AND MAINTAIN THEM IN FFFECTIVE OPERATING CONDITION MAINTENANCE OF BMPs SHOULD BE PROACTIVE, NOT REACTIVE. INSPECT BMPs AS SOON AS POSSIBLE (AND ALWAYS WITHIN 24 HOURS) FOLLOWING A STORM THAT CAUSES SURFACE EROSION, AND PERFORM NECESSARY MAINTENANCE.
- 2. FREQUENT OBSERVATIONS AND MAINTENANCE ARE NECESSARY TO MAINTAIN BMPs IN EFFECTIVE OPERATING CONDITION. INSPECTIONS AND CORRECTIVE MEASURES
- SHOULD BE DOCUMENTED THOROUGHLY.
- MAINTAIN THE FUNCTIONALITY OF THE BMP. TYPICALLY
- CONTRIBUTING DISTURBED AREA IS STABILIZED. WHEN SEDIMENT TRAPS ARE REMOVED. THE DISTURBED
- MULCHED OR OTHERWISE STABILIZED.

SEDIMENT TRAP DETAIL NOT TO SCALE

SILTSAK® NOTES:

POLYPROPYLENE AND SEWN BY A DOUBLE NEEDLE MACHINE, USING

ASTM D-4884

ASTM D-4884

TEST METHOD TEST METHOD

165.0 LBS/IN

114.6 LBS/IN

TEST RESULT

300 LBS

120 LBS

800 PSI

120 LBS

40 US SIEVE

0.55 SEC

265 LBS

20%

135 LBS

420 PSI

45 LBS

1.5 SEC

20 US SIEVE

200 GAL/MIN/FT2

90%

40 GAL/MIN/FT2

TEST RESULT

80%

20%

2.0 THE SILTSAK® SEAMS SHALL HAVE A CERTIFIED AVERAGE WIDE

WIDTH STRENGTH PER ASTM D-4884 STANDARDS AS FOLLOWS:

3.0 THE SILTSAK® WILL BE MANUFACTURED TO FIT THE OPENING OF

THE CATCH BASIN OR DROP INLET. THE SILTSAK® WILL HAVE THE

FOLLOWING FEATURES: TWO DUMP STRAPS ATTACHED AT THE

BOTTOM TO FACILITATE THE EMPTYING OF THE SILTSAK®: THE

SILTSAK® SHALL HAVE LIFTING LOOPS AS AN INTEGRAL PART OF

THE SYSTEM TO BE USED TO LIFT THE SILTSAK® FROM THE BASIN;

THE SILTSAK® SHALL HAVE A RESTRAINT CORD APPROXIMATELY

HALFWAY UP THE SACK TO KEEP THE SIDES AWAY FROM THE

CATCH BASIN WALLS, THIS YELLOW CORD IS ALSO A VISIBLE

MEANS OF INDICATING WHEN THE SACK SHOULD BE EMPTIED,

TEST METHOD

ASTM D-4632

ASTM D-4631

ASTM D-4833

ASTM D-3786

ASTM D-4533

ASTM D-4355

ASTM D-4751

ASTM D-4491

ASTM D-4491

TEST METHOD

ASTM D-4632

ASTM D-4632

ASTM D-4833

ASTM D-3786

ASTM D-4533

ASTM D-4355

ASTM D-4751

ASTM D-4491

ASTM D-4491

4.0 THE GEOTEXTILE FABRIC SHALL BE WOVEN POLYPROPYLENE

CLEANED, AND PLACED BACK INTO THE BASIN.

FABRIC WITH THE FOLLOWING PROPERTIES:

SILTSAK® REGULAR FLOW

PROPERTY

PUNCTURE

FLOW RATE

PROPERTY

PUNCTURE

GRAB TENSILE

MULLEN BURST

TRAPEZOID TEAR

UV RESISTANCE

FLOW RATE

PERMITTIVITY

APPARENT OPENING

GRAB ELONGATION

PERMITTIVITY

GRAB TENSILE

MULLEN BURST

TRAPEZOID TEAR

UV RESISTANCE

APPARENT OPENING

OR SILTSAK® HI-FLOW

GRAB ELONGATION

1.0 THE SILTSAK® SHALL BE MANUFACTURED FROM WOVEN

A HIGH STRENGTH NYLON THREAD.

SILTSAK® STYLE

REGULAR FLOW

HI-FLOW

- -LOCATION, LENGTH AND WIDTH OF SEDIMENT TRAP.
- 3.600 PER ACRE OF CONTRIBUTING DRAINAGE AREA
- UPGRADIENT LAND-DISTURBING ACTIVITIES.
- COMPACTED TO 95% OF THE MAXIMUM DENSITY IN
- WELL-GRADED ANGULAR 2"-3" CRUSHED STONE.
- 7. THE ENDS OF THE OUTLET STRUCTURE SHALL BE A MINIMUN

SEDIMENT TRAP MAINTENANCE NOTES:

- 3. WHERE BMPs HAVE FAILED. REPAIR OR REPLACEMENT SHOULD BE INITIATED UPON DISCOVERY OF THE FAILURE. 4 REMOVE SEDIMENT ACCUMULATED IN TRAP AS NEEDED TO
- WHEN THE SEDIMENT DEPTH REACHES 1/2 THE HEIGHT OF THE OUTLET. 5. SEDIMENT TRAPS SHALL REMAIN IN PLACE UNTIL THE
- AREA SHALL BE COVERED WITH TOPSOIL, SEEDED AND

SUPPLY WATER

GENERAL NOTES

- ALL SOIL EROSION AND SEDIMENT CONTROL MEASURES SHALL BE IN ACCORDANCE WITH STANDARDS AND SPECIFICATIONS THEREOF IN NEW HAMPSHIRE DEPARTMENT OF ENVIRONMENTAL SERVICES STORMWATER MANUALS, VOLUME 1-3, LATEST EDITION.
- THE WORK AREA SHALL BE GRADED, SHAPED, AND OTHERWISE DRAINED IN SUCH A MANNER AS TO MINIMIZE SOIL EROSION, SILTATION OF DRAINAGE CHANNELS, DAMAGE TO EXISTING VEGETATION, AND DAMAGE TO PROPERTY OUTSIDE THE LIMITS OF THE WORK AREA. SILT FENCES, STRAW BALES AND/OR DETENTION
- STRIPPED TOPSOIL SHALL BE STOCKPILED, WITHOUT COMPACTION, AND STABILIZED AGAINST EROSION IN ACCORDANCE WITH "TEMPORARY STABILIZATION OF DISTURBED AREAS", AS OUTLINED IN NOTE No. 4.
- TEMPORARY STABILIZATION OF DISTURBED AREAS: SEED BED PREPARATION: 10-10-10 FERTILIZATION TO BE SPREAD AT THE RATE OF 7 LBS PER 1.000 SF AND AGRICULTURAL LIMESTONE AT A RATE OF 90 LBS PER 1,000 SF AND INCORPORATED INTO THE SOIL. THE SOIL, FERTILIZER AND LIMESTONE SHALL BE TILLED TO PREPARE FOR SEEDING.

A. SEED MIXTURE: USE ANY OF THE FOLLOWING:

BASINS WILL BE NECESSARY TO ACCOMPLISH THIS END

SPECIES	RATE PER 1,000 SF	DEPTH	SEEDING DATES	
WINTER RYE	2.5 LBS	1"	08/15 TO 09/15	
OATS	2.5 LBS	1"	04/15 TO 10/15	
ANNUAL RYE GRASS	1.0 LBS	0.25"	08/15 TO 09/15	

B. MULCHING: MULCH SHOULD BE USED ON HIGHLY ERODABLE AREAS, AND WHERE CONSERVATION OF

TYPE	RATE PER 1,000 SF	USE & COMMENTS
STRAW	70 TO 90 LBS	MAY BE USED WITH PLANTINGS, MUST BE ANCHORED TO BE USED ALONE
WOOD CHIPS OR BARK MULCH	460 TO 920 LBS	USED WITH TREE AND SHRUB PLANTINGS
FIBROUS MATTING	AS RECOMMENDED BY MANUFACTURER	MUST BE BIODEGRADABLE. USE IN SLOPE AREAS AND AREAS DIFFICULT TO VEGETATE.
CRUSHED STONE 1/4" TO 1 1/2" DIA	SPREAD TO GREATER THAN ½" THICKNESS	USE IN SPECIFIC AREAS AS SHOWN ON PLAN OR AS NEEDED.

- PERMANENT STABILIZATION OF DISTURBED AREAS: ALL ROADWAYS SHALL BE STABILIZED WITHIN 72 HOURS OF ACHIEVING FINISHED GRADE.
 - ALL CUT AND FILL SLOPES SHALL BE SEEDED/LOAMED WITHIN 72 HOURS OF ACHIEVING FINISHED
- THE SMALLEST PRACTICAL AREA SHALL BE DISTURBED DURING CONSTRUCTION, BUT IN NO CASE SHALL EXCEED 5 ACRES AT ANY ONE TIME BEFORE DISTURBED AREAS ARE STABILIZED.
- AN AREA SHALL BE CONSIDERED STABILIZED IF ONE OF THE FOLLOWING HAS OCCURRED:
- BASE COURSE GRAVELS HAVE BEEN INSTALLED IN AREAS TO BE PAVED. A MINIMUM OF 85% VEGETATED GROWTH HAS BEEN ESTABLISHED.
- A MINIMUM OF 3 INCHES OF NON-EROSIVE MATERIAL SUCH AS STONE OR RIPRAP HAS BEEN INSTALLED
- OR, EROSION CONTROL BLANKETS HAVE BEEN PROPERLY INSTALLED
- ALL AREAS SHALL BE STABILIZED WITHIN 45 DAYS OF INITIAL DISTURBANCE.
- SITE LOCATION 42° 43' 09" N LATITUDE, 71° 25' 53" W LONGITUDE (PER GOOGLE EARTH)
- 10. TOTAL AREA OF DISTURBED SOILS: 427,275± SF (FOR GREEN MEADOW DRIVE).
- REFERENCE IS MADE TO THE LATEST EDITION OF THE FEDERAL REGISTER (63 FR 7857), ENVIRONMENTAL PROTECTION AGENCY NPDES GENERAL PERMITS FOR STORMWATER DISCHARGES FROM CONSTRUCTION ACTIVITIES, FOR ADDITIONAL INFORMATION CONTACT (202) 564-9545 OR www.epa.gov/npdes/stormwater.
- 12. THE ENTIRE CONTENTS OF THE STORMWATER POLLUTION PREVENTION PLAN (SWPPP) SHALL BE RETAINED ON-SITE FOR THE DURATION OF THE CONTRACT AND BE MADE AVAILABLE TO LOCAL, STATE AND FEDERAL
- THIS PROJECT SHALL BE MANAGED TO MEET THE REQUIREMENTS AND INTENT OF RSA 430:63 AND AGR 3800 RELATIVE TO INVASIVE SPECIES; AND FUGITIVE DUST IS CONTROLLED IN ACCORDANCE WITH ENV-A

WINTER CONDITION NOTES

- ALL PROPOSED POST-DEVELOPMENT VEGETATED AREAS WHICH DO NOT EXHIBIT A MINIMUM OF 85% VEGETATIVE GROWTH BY OCTOBER 15TH, OR WHICH ARE DISTURBED AFTER OCTOBER 15TH SHALL BE STABILIZED BY SEEDING AND INSTALLING EROSION CONTROL BLANKETS ON SLOPES GREATER THAN 3:1, AND SEEDING AND PLACING 3 TO 4 TONS OF MULCH PER ACRE, SECURED WITH ANCHORED NETTING FLISEWHERE THE PLACEMENT OF EROSION CONTROL BLANKETS OR MULCH AND NETTING SHALL NOR OCCUR OVER ACCUMULATED SNOW OR ON FROZEN GROUND AND SHALL BE COMPLETED IN ADVANCE OF THAW OR SPRING MELT EVENTS
- ALL DITCHES OR SWALES WHICH DO NOT EXHIBIT A MINIMUM OF 85% VEGETATIVE GROWTH BY OCTOBER 15TH, OR WHICH ARE DISTURBED AFTER OCTOBER 15TH, SHALL BE STABILIZED WITH STONE OR EROSION CONTROL BLANKETS APPROPRIATE FOR THE DESIGN FLOW CONDITIONS
- AFTER NOVEMBER 15TH, INCOMPLETE ROAD OR PARKING SURFACES SHALL BE PROTECTED WITH A MINIMUM OF 3-INCHES OF CRUSHED GRAVEL PER NHDOT ITEM 304.3.

NHDES EROSION CONTROL INSPECTION NOTES

AS THIS PROJECT WILL BE DISTURBING MORE THAN 5 ACRES AT ANY ONE TIME THE PERMIT FOR THIS PROJECT WILL INCLUDE THE FOLLOWING REQUIREMENTS:

- A CERTIFIED PROFESSIONAL IN EROSION AND SEDIMENT CONTROL OR A PROFESSIONAL ENGINEER LICENSED IN THE STATE OF NEW HAMPSHIRE ("MONITOR") SHALL BE EMPLOYED TO INSPECT THE SITE FROM THE START OF ALTERATION OF TERRAIN ACTIVITIES UNTIL THE SITE IS IN FULL COMPLIANCE WITH THE ALTERATION OF TERRAIN PERMIT ("PERMIT")
- DURING THIS PERIOD, THE MONITOR SHALL INSPECT THE SUBJECT SITE AT LEAST ONCE A WEEK, AND IF POSSIBLE, DURING ANY 1/2 INCH OR GREATER RAIN EVENT (i.e. 1/2 INCH OF PRECIPITATION OR MORE WITHIN A 2 HOUR PERIOD). IF UNABLE TO BE PRESENT DURING SUCH A STORM, THE MONITOR SHALL INSPECT THE SITE WITHIN 24 HOURS OF THIS EVENT.
- THE MONITOR SHALL PROVIDE TECHNICAL ASSISTANCE AND RECOMMENDATIONS TO THE CONTRACTOR ON THE APPROPRIATE BEST MANAGEMENT PRACTICES FOR EROSION AND SEDIMENT CONTROLS REQUIRED TO MEET THE REQUIREMENTS OF RAS 485-1:17 AND ALL APPLICABLE DES
- WITHIN 24 HOURS OF EACH INSPECTION, THE MONITOR SHALL SUBMIT A REPORT TO DES VIA EMAIL (TO EMILY LUCAS AT: emily.lucas@des.state.nh.gov).
- PRIOR TO BEGINNING CONSTRUCTION, THE CONTRACTOR'S NAME, ADDRESS, AND PHONE NUMBER SHALL BE SUBMITTED TO DES VIA EMAIL (SEE ABOVE).

DIVERSION RIDGE REQUIRED WHERE __3"-6" OR GREATER OR GREATER **GRADE EXCEEDS 2%** SECTION 'A'-'A' VIEW

NOTES:

- THE EXIT SHALL BE MAINTAINED IN A CONDITION THAT WILL PREVENT TRACKING OR FLOWING OF SEDIMENT ONTO PUBLIC RIGHT-OF-WAYS. THIS MAY REQUIRE TOP DRESSING, REPAIR AND/OR CLEAN OUT OF ANY MEASURES USED TO TRAP SEDIMENT
- WHEN NECESSARY, WHEELS SHALL BE CLEANED PRIOR TO EXITING THE SITE ONTO A PUBLIC RIGHT-OF-WAY. 3. WHEN WASHING IS REQUIRED, IT SHALL BE DONE ON AN AREA
- STABILIZED WITH CRUSHED STONE THAT DRAINS INTO AN APPROVED SEDIMENT TRAP OR SEDIMENT BASIN. 4. CONSTRUCTION SPECIFICATIONS AND MAINTENANCE REQUIREMENTS SHOWN IN NHDES STORMWATER MANUAL VOLUME 3.

TEMPORARY GRAVEL CONSTRUCTION EXIT

NOT TO SCALE

SITE MAINTENANCE/INSPECTION PROGRAM

THE FOLLOWING PROVIDES AN ITEMIZATION OF SPECIFIC SITE MAINTENANCE PRACTICES THAT WILL BE EMPLOYED ON THE SITE TO MINIMIZE POLLUTANT GENERATION AND TRANSPORT FROM THE SITE. THE SITE MAINTENANCE PROGRAM INCLUDES ROUTINE INSPECTIONS, PREVENTATIVE MAINTENANCE AND "GOOD HOUSEKEEPING"

ROUTINE INSPECTIONS

THE CONTRACTOR SHALL INSPECT ALL CONTROL MEASURES AT LEAST ONCE A WEEK AND WITHIN TWELVE (12) HOURS OF THE END OF A STORM WITH RAINFALL AMOUNT GREATER THAN 0.5 INCHES. THE INSPECTIONS WILL VERIFY THAT THE STRUCTURAL BMPs DESCRIBED IN THE PLANS ARE IN GOOD CONDITION AND ARE MINIMIZING EROSION. A MAINTENANCE INSPECTION REPORT WILL BE MADE WITH EACH INSPECTION. COMPLETED INSPECTION FORMS SHALL BE KEPT ON-SITE FOR THE DURATION OF THE PROJECT. FOLLOWING CONSTRUCTION, THE COMPLETED FORMS SHALL BE RETAINED AT THE CONTRACTOR'S OFFICE FOR A MINIMUM OF ONE YEAR.

PREVENTATIVE MAINTENANCE

- THE CONTRACTOR SHALL BE RESPONSIBLE FOR MAINTENANCE OF ALL TEMPORARY AND PERMANENT CONTROLS THROUGHOUT THE DURATION OF THIS CONTRACT. MAINTENANCE PRACTICES SHALL INCLUDE, BUT ARE NOT LIMITED TO:
- CLEANING OF CATCH BASINS TWICE PER YEAR OR MORE FREQUENTLY AS DICTATED BY QUARTERLY INSPECTIONS.
- CLEANING OF SEDIMENT AND DEBRIS FROM STORMWATER MANAGEMENT AREA FOREBAY TWICE PER YEAR OR MORE FREQUENTLY AS DICTATED BY MONTHLY INSPECTIONS.
- IMPLEMENTATION OF OTHER MAINTENANCE OR REPAIR ACTIVITIES AS DEEMED NECESSARY BASED UPON WEEKLY INSPECTIONS
- REMOVAL OF BUILT UP SEDIMENT ALONG SILT FENCES AND/OR HAY BALE BARRIERS.
- REMOVAL OF BUILT UP SEDIMENT IN BOTH TEMPORARY AND PERMANENT CONTROLS SUCH AS GRASS SWALES, SEDIMENT FOREBAYS AND RECHARGE/DETENTION BASINS.
- RECONSTRUCTING THE TEMPORARY GRAVEL CONSTRUCTION EXIT IF NOT WORKING PROPERLY
- TREATMENT OF NON-STORM WATER DISCHARGES SUCH AS WATER FROM WATER LINE FLUSHINGS OR GROUNDWATER FROM DEWATERING EXCAVATIONS. SUCH FLOWS SHOULD BE DIRECTED TO A TEMPORARY SEDIMENTATION BASIN OR STORMWATER MANAGEMENT AREA
- SWEEP PARKING LOTS AND DRIVES REGULARLY TO MINIMIZE SEDIMENT ACCUMULATION. FREQUENCY WILL VARY SEASONALLY ACCORDING TO SEDIMENT ACCUMULATION ON PAVE SURFACES (E.G., MORE FREQUENT SWEEPING DURING THE WINTER AND SPRING).

GOOD HOUSEKEEPING PRACTICES

- THE CONTRACTOR SHALL EMPLOY MEASURES AND PRACTICES TO REDUCE THE RISK OF SPILLS OR OTHER ACCIDENTAL EXPOSURE OF MATERIALS TO STORM AND WATER RUNOFF. THE CONTRACTOR SHALL PAY SPECIAL ATTENTION TO THE HANDLING. USE AND DISPOSAL OF MATERIALS SUCH AS PETROLEUM PRODUCTS, FERTILIZERS AND PAINTS TO ENSURE THAT THE RISK ASSOCIATED WITH THE USE OF THESE PRODUCTS IS MINIMIZED. THE FOLLOWING "GOOD HOUSEKEEPING" PRACTICES SHALL BE FOLLOWED DURING
 - A. AN EFFORT SHALL BE MADE TO STORE ONLY ENOUGH PRODUCT REQUIRED TO DO THE JOB.
 - B. ALL MATERIALS STORED ON-SITE SHALL BE STORED IN A NEAT, ORDERLY MANNER IN THEIR
- APPROPRIATE CONTAINERS AND, IF POSSIBLE, UNDER A ROOF OR OTHER ENCLOSURE. C. PRODUCTS SHALL BE KEPT IN THEIR ORIGINAL CONTAINERS WITH THEIR MANUFACTURERS' LABELS.
- D. WHENEVER POSSIBLE, ALL OF A PRODUCT SHALL BE USED BEFORE DISPOSING OF THE CONTAINER. F MANUFACTURERS' RECOMMENDATIONS FOR PROPER USE AND DISPOSAL SHALL BE FOLLOWED.
- F. THE CONTRACTOR SHALL INSPECT DAILY TO ENSURE PROPER USE AND DISPOSAL OF MATERIALS.

SPILL PREVENTION AND CLEANUP PRACTICES

- MANUFACTURERS' RECOMMENDED METHODS FOR SPILL CLEANUP WILL BE CLEARLY POSTED AND SITE PERSONNEL WILL BE MADE AWARE OF THE PROCEDURES AND THE LOCATION OF THE INFORMATION AND
- CLEANUP SUPPLIES. MATERIALS AND EQUIPMENT NECESSARY FOR SPILL CLEANUP WILL BE KEPT IN THE MATERIAL STORAGE AREA ON-SITE, EQUIPMENT AND MATERIAL WILL INCLUDE BUT NOT BE LIMITED TO BROOMS, DUSTPANS, MOPS, RAGS, GLOVES, GOGGLES, KITTY LITTER, SAND, SAWDUST, AND PLASTIC AND METAL TRASH
- CONTAINERS SPECIFICALLY FOR THIS PURPOSE. ALL SPILLS WILL BE CLEANED UP IMMEDIATELY AFTER DISCOVERY.
- THE SPILL AREA WILL BE KEPT WELL VENTILATED AND PERSONNEL WILL WEAR APPROPRIATE PROTECTIVE CLOTHING TO PREVENT INJURY FROM CONTACT WITH A HAZARDOUS SUBSTANCE.
- SPILLS OF TOXIC OR HAZARDOUS MATERIAL WILL BE REPORTED TO THE APPROPRIATE STATE OR LOCAL GOVERNMENT AGENCY, REGARDLESS OF THE SIZE.
- THE SPILL PREVENTION PLAN WILL BE ADJUSTED TO INCLUDE MEASURES TO PREVENT THIS TYPE OF SPILL FROM REOCCURRING AND HOW TO CLEAN UP THE SPILL IF THERE IS ANOTHER ONE. A DESCRIPTION OF THE SPILL, WHAT CAUSED IT, AND THE CLEANUP MEASURES WILL ALSO BE INCLUDED.

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DETAIL SHEET - EROSION CONTROL (MAP 234, LOTS 5, 34 & 35 AND MAP 239. LOT 1) OWELL AND STEELE ROADS NEW HAMPSHIRE HUDSON,

LANGAN 888 BOYLSTON STREET BOSTON, MASSACHUSETTS 02116 (617) 824-9100

GREENMEADOW GOLF CLUB, INC., THOMAS P. FRIEL & PHILIP J. FRIEL, III and 267 LOWELL RD HUDSON, LLC

SCALE AS SHOWN

21 APRIL 2020



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DRAWING NAME: 3867L-DET1 FIELD BOOK: --3867L 18 OF 22 DRAWING LOC: J: \3000\3867\DWG\3867L SITE File Number

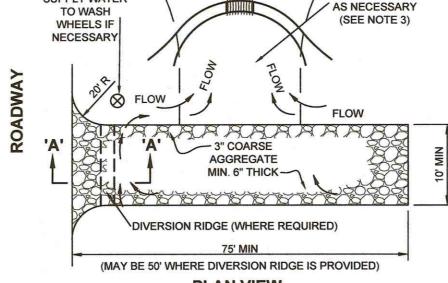
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SECRETARY.

DATE OF MEETING:

WELL-GRADED ANGULAR

2"-3" CRUSHED STONE




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APPROVED BY THE HUDSON, NH PLANNING BOARD


APPROVAL. FOR AN APPLICANT TO GAIN AN EXEMPTION FROM ALL SUBSEQUENT CHANGES IN SUBDIVISION REGULATIONS, SITE PLAN REGULATIONS AND CHANGES TO THE ZONING ORDINANCE, SEE NH RSA 674:39.

Environmental Services, Inc. 888 Boylston Street, Ste 510 Boston, MA 02199

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DRAWING NAME: 151010101-LL101-0102 19 OF 22 FIELD BOOK: DRAWING LOC: \\Langan.com\data\bos\data\\testo10101\project data_discipline\landscape architecture\right-of-way lighting\hiddson

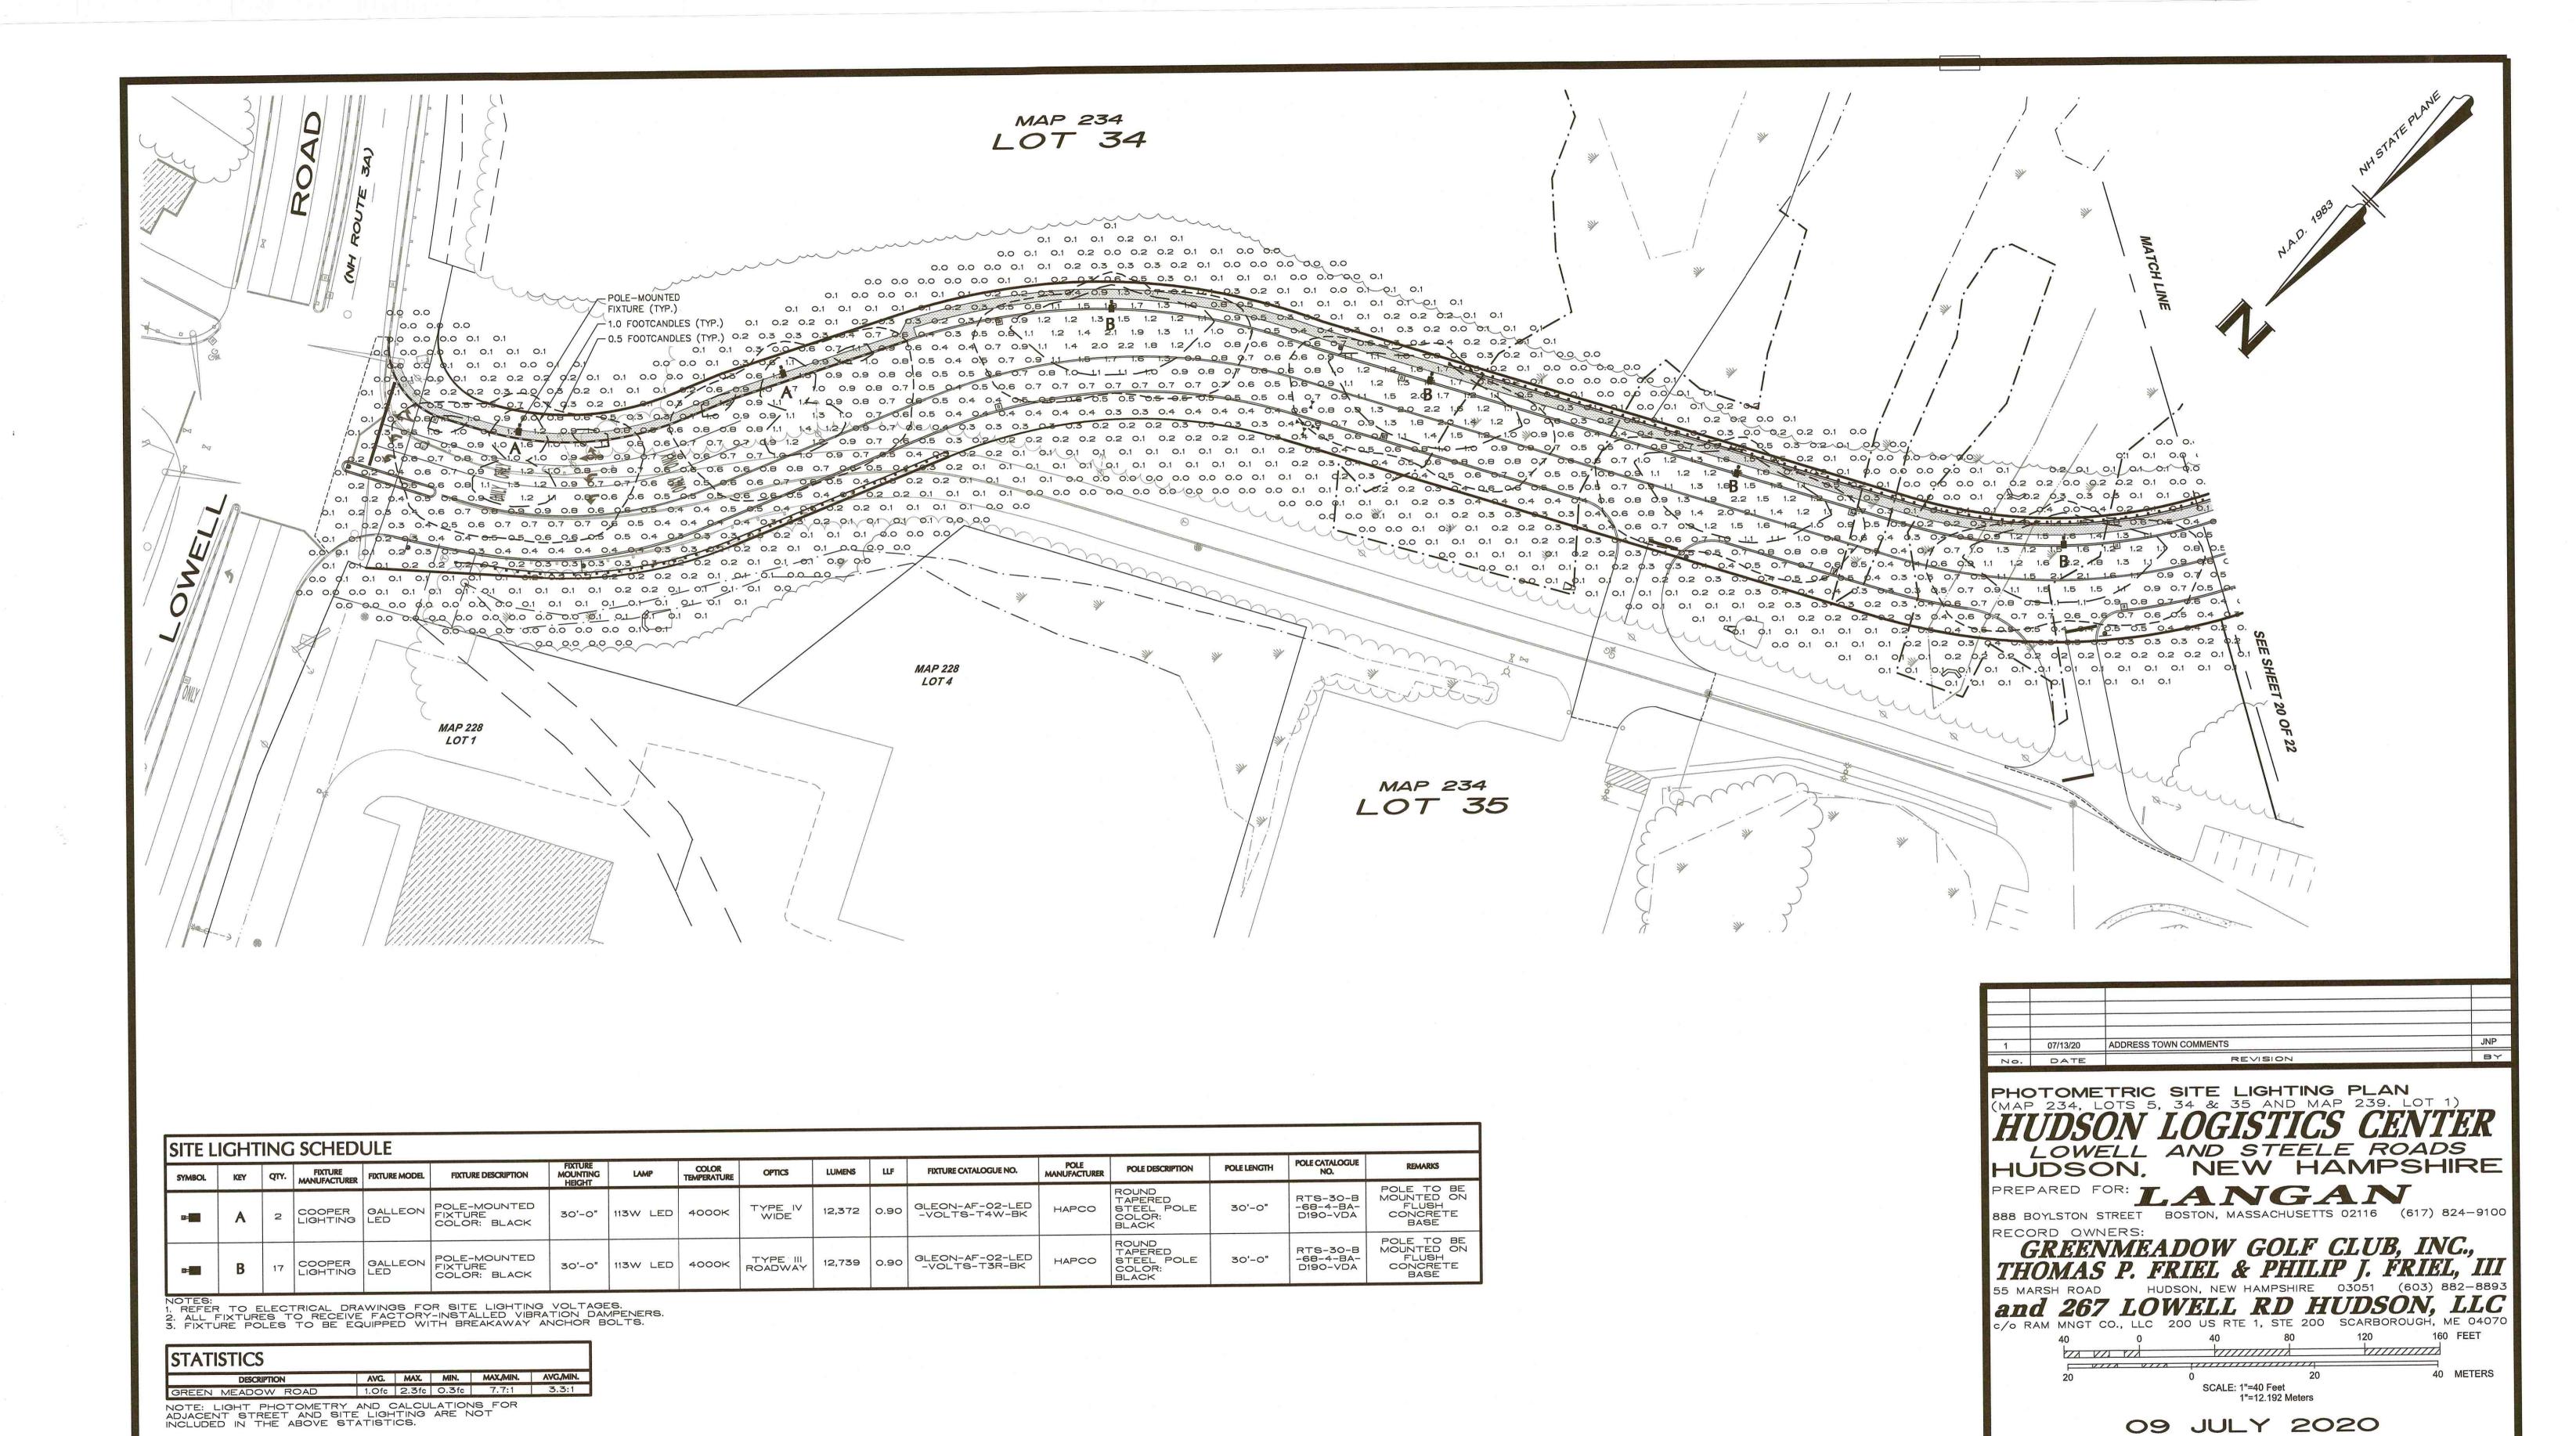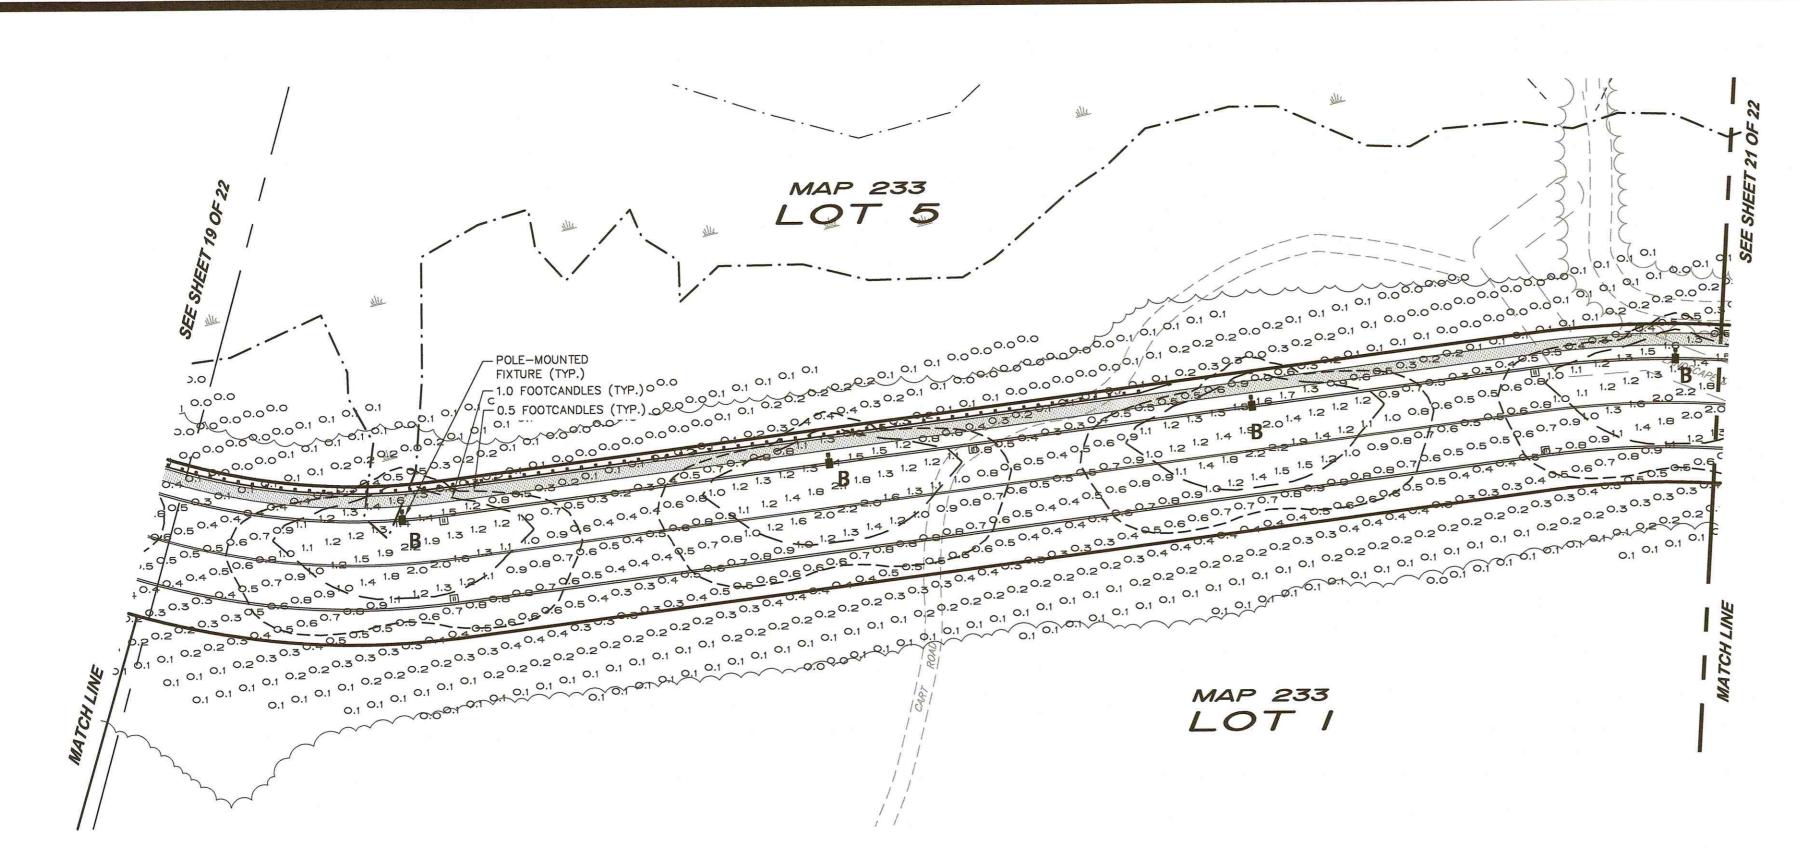DATE OF MEETING:



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REFER TO SHEET SL19 FOR SITE LIGHTING SCHEDULE

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FIELD BOOK: DRAWING NAME: 151010101—LL101—0102 20 OF 22

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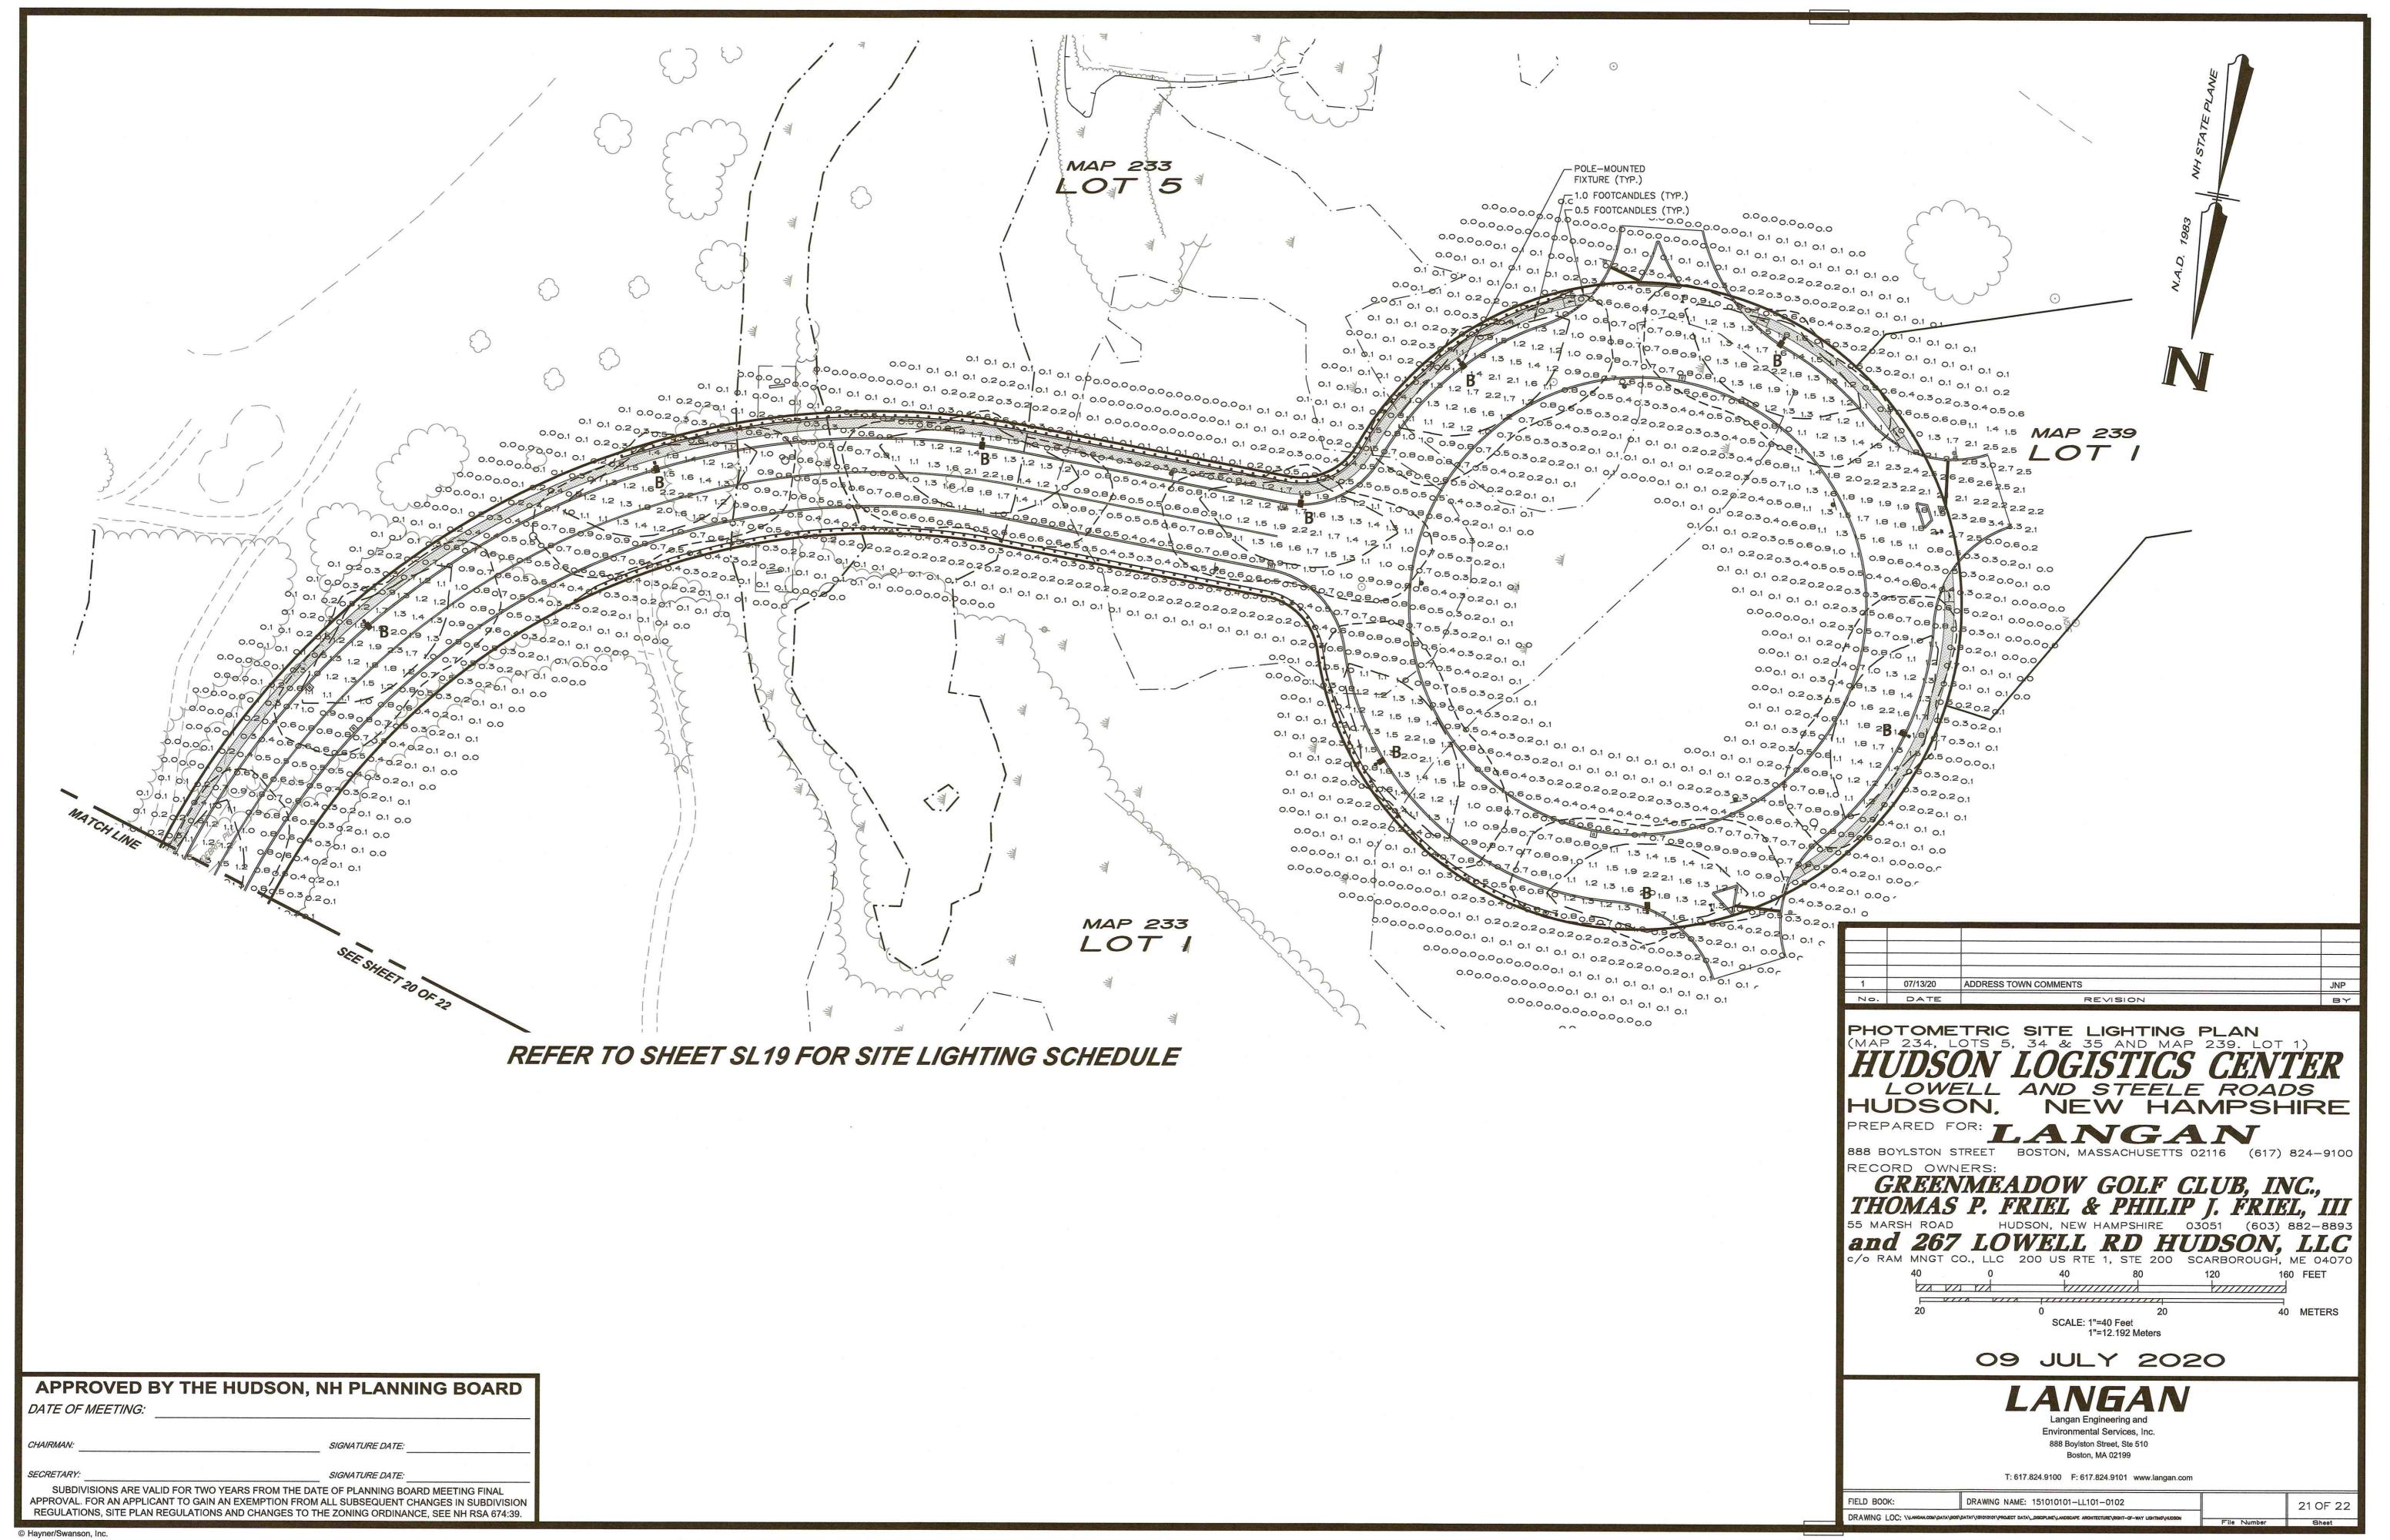
APPROVED BY THE HUDSON, NH PLANNING BOARD

DATE OF MEETING:

CHAIRMAN:

SIGNATURE DATE:

SUBDIVISIONS ARE VALID FOR TWO YEARS FROM THE DATE OF PLANNING BOARD MEETING FINAL APPROVAL. FOR AN APPLICANT TO GAIN AN EXEMPTION FROM ALL SUBSEQUENT CHANGES IN SUBDIVISION REGULATIONS, SITE PLAN REGULATIONS AND CHANGES TO THE ZONING ORDINANCE, SEE NH RSA 674:39.



LIGHTING NOTES:

- 1. POINT-BY-POINT CALCULATIONS PROVIDED WITHIN HAVE BEEN PREPARED IN ACCORDANCE TO IESNA STANDARDS AND IN CONSIDERATION OF THE VARIABLES WITHIN THESE NOTES AND SITE LIGHTING SCHEDULE. THE VALUES SHOWN ON THE PLANS ARE NOT AN INDICATION OF THE INITIAL LIGHT INTENSITIES OF THE LAMPS. THESE VALUES ARE AN APPROXIMATION OF THE MAINTAINED INTENSITIES DELIVERED TO THE GROUND PLANE USING INDUSTRY STANDARD LIGHT LOSS FACTORS (LLF) WHICH COVER LAMP DEGRADATION AND NATURAL BUILDUP/ DIRT DEGRADATION ON THE FIXTURE LENS. THE LIGHTING PLAN IS DESIGNED WITH AN INDUSTRY STANDARD LLF IN ACCORDANCE WITH GUIDANCE AS PROVIDED BY IESNA. MINOR VARIATIONS IN TOPOGRAPHY, PHYSICAL OBSTRUCTIONS, AMBIENT OR ADJACENT LIGHT SOURCES AND/OR OTHER POTENTIAL IMPACTS HAVE NOT BEEN INCLUDED IN THESE CALCULATIONS. THEREFORE, AS-BUILT LIGHT INTENSITIES MAY VARY, IN EITHER DIRECTION, FROM WHAT IS EXPLICITLY PORTRAYED WITHIN THESE DRAWINGS.NO GUARANTEE OF LIGHT LEVELS IS EXPRESSED OR IMPLIED BY THE POINT BY POINT CALCULATIONS SHOWN ON THESE
- 2. LIGHT LEVEL POINT SPACING IS 10 FT. LEFT TO RIGHT AND 10 FT. TOP TO BOTTOM. POINT BY POINT CALCULATIONS ARE BASED ON THE LIGHT LOSS FACTOR AS STATED IN THE LIGHTING SCHEDULE.
- 3. ALL LIGHTING IS TO BE FULL CUT-OFF.

- 3. ALL SITE LIGHTING RELATED WORK AND MATERIALS SHALL COMPLY WITH CITY, COUNTY, AND OTHER APPLICABLE GOVERNING AUTHORITY REQUIREMENTS.
- 4. LIGHTING LAYOUT COMPLIES WITH THE ILLUMINATING ENGINEERING SOCIETY OF NORTH AMERICA (IESNA) SAFETY STANDARDS FOR LIGHT LEVELS.

- 5. CONTRACTOR TO COORDINATE POWER SOURCE WITH LIGHT FIXTURES TO ENSURE ALL SITE LIGHTING IS OPERATING EFFECTIVELY, EFFICIENTLY AND SAFELY.
- 6. REFER TO ELECTRIFICATION PLAN FOR PROVIDING ADEQUATE POWER FOR SITE LIGHTING.
- 7. CONTRACTOR TO COORDINATE LOCATION OF EASEMENTS, UNDERGROUND UTILITIES AND DRAINAGE BEFORE DRILLING POLE BASES
- 8. INSTALLATION OF ALL LIGHTING FIXTURES, POLES, FOOTINGS, AND FEEDER CABLE TO BE COORDINATED WITH ALL SITE WORK TRADES TO AVOID CONFLICT WITH FINISHED AND PROPOSED WORK.
- CONTRACTOR TO COORDINATE INSTALLATION OF UNDERGROUND FEEDER CABLE FOR EXTERIOR LIGHTING WITH EXISTING AND PROPOSED UTILITIES, SITE DRAINAGE SYSTEMS, AND PAVING. CONTRACTOR SHALL PROMPTLY NOTIFY THE OWNER'S REPRESENTATIVE SHOULD ANY UTILITIES, NOT SHOWN ON THE PLANS, BE FOUND

POLES AND FOOTINGS

- 10. PROVIDE A CONCRETE BASE FOR EACH LIGHT POLE AT THE LOCATIONS INDICATED ON THE CONSTRUCTION DRAWINGS AND/OR IN ACCORDANCE WITH PROJECT PLANS AND SPECIFICATIONS RELATING DIRECTLY TO CAST-IN-PLACE CONCRETE. THE USE OF ALTERNATE LIGHTING FOUNDATIONS, SUCH AS PRECAST, MAY CHANGE THE SIZING AND REINFORCEMENT REQUIREMENTS FROM THOSE SHOWN ON THESE PLANS. CONTRACTOR TO SUBMIT SHOP DRAWINGS FOR REVIEW PRIOR TO ORDERING ANY SUBSTITUTED PRODUCTS.
- 11. CONTRACTOR SHALL EXAMINE AND VERIFY THAT SOIL CONDITIONS ARE SUITABLE TO SUPPORT LOADS EXERTED UPON THE FOUNDATIONS DURING EXCAVATION. CONTRACTOR SHALL NOTIFY ENGINEER OF ANY
- 12. POLE FOUNDATIONS SHALL NOT BE POURED IF FREE STANDING WATER IS PRESENT IN EXCAVATED AREA. 13. ALL POLES HIGHER THAN 25 FT. SHALL BE EQUIPPED WITH FACTORY INSTALLED VIBRATION DAMPENERS.

- 14. CONTRACTOR TO COORDINATE INSTALLATION OF ALL THE WALL MOUNTED FIXTURES AND ELECTRICAL CONNECTIONS TO SITE STRUCTURE(S) WITH BUILDING MEP, ARCHITECT, AND/OR OWNER.
- 15. INSTALLATION AND ELECTRICAL CONNECTIONS FOR WALL MOUNTED FIXTURES TO BE COORDINATED WITH ARCHITECTURAL, STRUCTURAL, UTILITY AND SITE PLANS AND TO BE IN ACCORDANCE WITH ALL APPLICABLE CODES.

POLE-TO-BASE PLATE WELD -

ADJUSTMENT AND INSPECTION

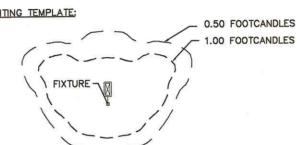
- 16. CONTRACTOR TO OPERATE EACH LUMINAIRE AFTER INSTALLATION AND CONNECTION. INSPECT FOR IMPROPER CONNECTIONS AND OPERATION.
- 17. CONTRACTOR TO AIM AND ADJUST ALL LUMINAIRES TO PROVIDE ILLUMINATION LEVELS AND DISTRIBUTION AS INDICATED ON THE CONSTRUCTION DRAWINGS OR AS DIRECTED BY THE LANDSCAPE ARCHITECT AND/OR
- 18. CONTRACTOR TO CONFIRM THAT LIGHT FIXTURES, TILT ANGLE AND AIMING MATCH SPECIFICATIONS ON THE

REQUIREMENTS FOR ALTERNATES

- 19. ALL LIGHTING SUBSTITUTIONS MUST BE MADE WITHIN 14 DAYS PRIOR TO THE BID DATE TO PROVIDE TIME FOR REVIEW AND TO ISSUE AN ADDENDUM INCORPORATING THE SUBSTITUTION WITH THE FOLLOWING REQUIREMENTS: A. ANY SUBSTITUTION TO LIGHTING FIXTURES, POLES, ETC. MUST BE APPROVED BY THE OWNER, ENGINEER
- AND TENANTS. ANY COST ASSOCIATED WITH REVIEW AND/OR APPROVAL OF THE SUBSTITUTIONS SHALL ENTIRELY BORNE BY THE CONTRACTOR B. COMPUTER PREPARED PHOTOMETRIC LAYOUT OF THE PROPOSED LIGHTED AREA WHICH INDICATES, BY
- ISOFOOTCANDLE, THE SYSTEM'S PERFORMANCE. C. A PHOTOMETRIC REPORT FROM A NATIONAL INDEPENDENT TESTING LABORATORY WITH REPORT C. A PHOTOMETRIC REPORT FROM A NATIONAL INDEPENDENT TESTING LABORATORY WITH REPORT NUMBER, DATE, FIXTURE CATALOG NUMBER, LUMINAIRE AND LAMP SPECIFICATIONS; IES CALCULATIONS, POINT BY POINT FOOT CANDLE PLAN, STATISTIC ZONES SHOWING AVERAGE, MAXIMUM, MINIMUM AND UNIFORMITY RATIOS, SUMMARY, ISOLUX PLOT, AND CATALOGUE CUTS. CATALOGUE CUTS MUST IDENTIFY OPTICS, LAMP TYPE, DISTRIBUTION TYPE, REFLECTOR, LENS, BALLASTS, WATTAGE, VOLTAGE, FINISH HOUSING DESCRIPTION AND ALL OTHER PERTINENT INFORMATION.

 D. POLE MANUFACTURER AASHTO CALCULATIONS INDICATING THE POLE AND ANCHOR BOLTS BEING SUBMITTED ARE CAPABLE OF SUPPORTING THE POLE AND FIXTURE SYSTEMS BEING UTILIZED IN ACCORDANCE WITH THE CONTRACT DOCUMENTS.
- E. THE UNDERWRITERS LABORATORY LISTING AND FILE NUMBER FOR THE SPECIFIC FIXTURE(S) TO BE F. A COLOR PHOTOGRAPH THAT CLEARLY SHOWS THE REPLACEMENT FIXTURE POLE MOUNTED, THE


PHOTOMETRIC LIGHTING TEMPLATE:




NOTE: THE PHOTOMETRIC TEMPLATE REPRESENTS LIGHT THROW FOR EACH INDIVIDUAL FIXTURE AND DOES NOT REPRESENT LIGHT COMING FROM OTHER SOURCES.

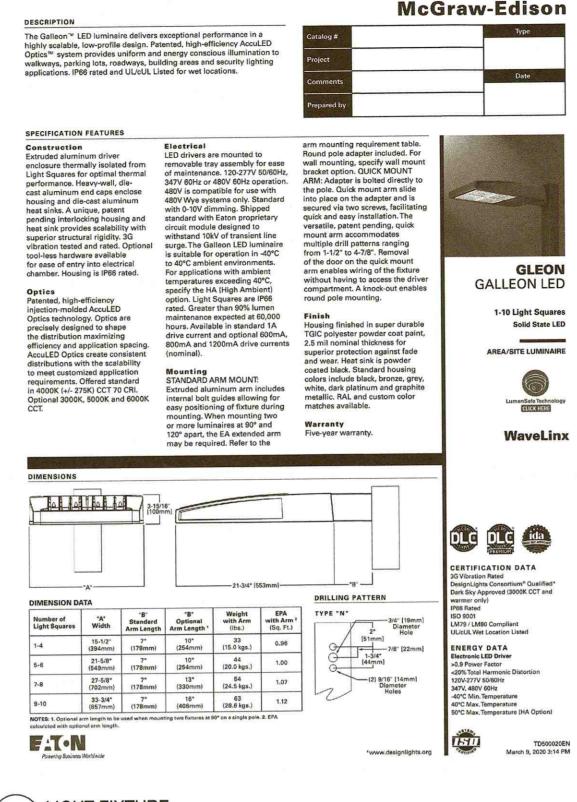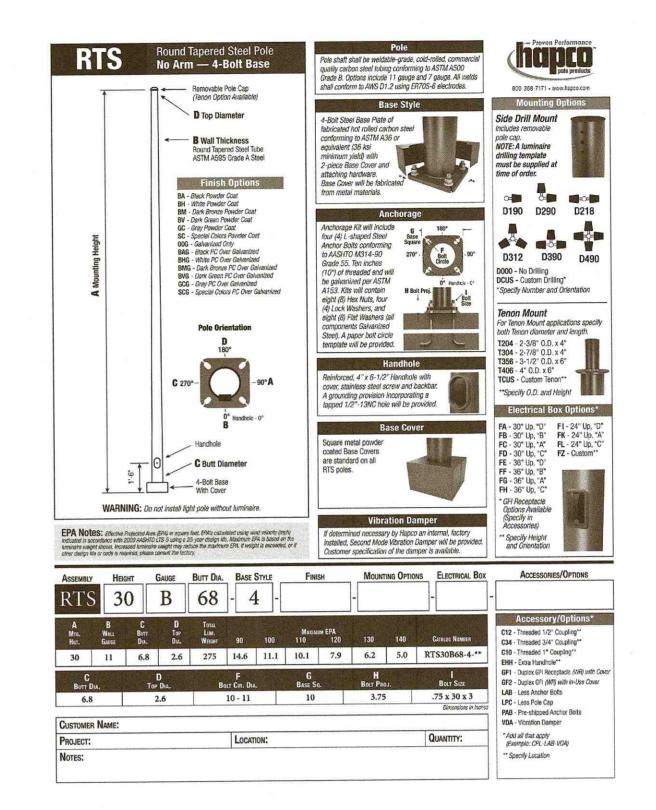FIXTURE'S COLOR, FINISH, AND PHYSICAL CHARACTERISTICS.

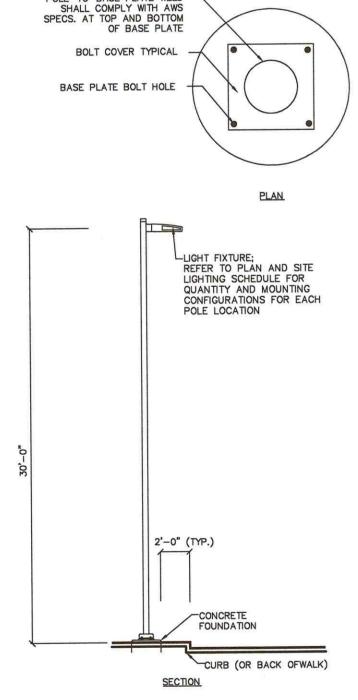




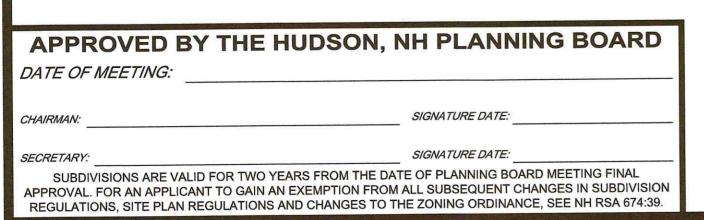


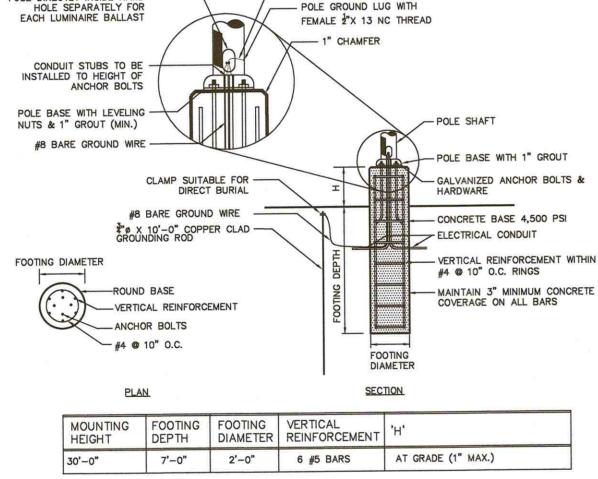













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- SHAFT CAP, ARMS, BASE FLANGE, ANCHOR BOLTS, LEVELING NUTS, CONNECTION HARDWARE, BOLT COVERS, HANDHOLE COVER, AND BOLT CIRCLE TEMPLATE SHALL BE FURNISHED BY POLE MANUFACTURER.
 EACH STANDARD TO BE PROTECTED AGAINST LIGHTNING WITH AN INTERCONNECTED GROUND ROD. THIS ROD SHALL BE BONDED PER SECTION NUMBER 250-86, N.E.C.
- 3. CONTRACTOR TO ENSURE CONCRETE POLE BASES ARE POURED / PLACED ABSOLUTELY VERTICAL & LEVEL.
 4. POLE BASE SHALL BE ONE CONTINUOUS POUR. EXPOSED PORTION OF BASE SHALL BE HAND-RUBBED
- 5. CONTRACTOR TO COMPACT SUBGRADE AROUND POLE BASE PER EARTHWORK SPECIFICATIONS / GEOTECH
- REPORT.

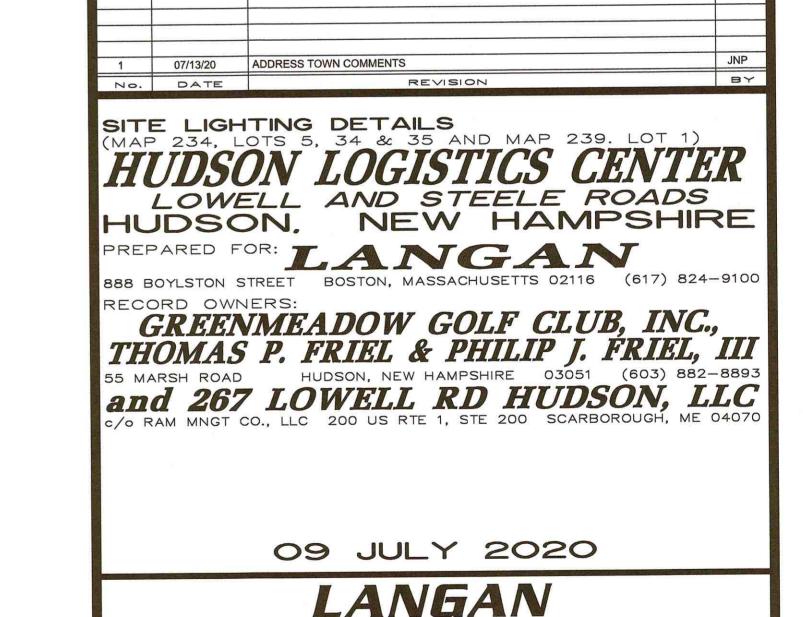 6. THE INFORMATION ILLUSTRATED IN THE LIGHT POLE FOUNDATION DETAIL HAS BEEN PROVIDED FOR GENERAL REFERENCE AND PRELIMINARY COST ESTIMATE PURPOSES. LIGHT POLE FOUNDATIONS SHOULD BE DESIGNED AND DETAILED BY A LICENSED STRUCTURAL ENGINEER BASED ON EXISTING SOIL CONDITIONS, LOCAL DESIGN STANDARDS AND MANUFACTURERS RECOMMENDATIONS.
 CONCRETE BASES SHALL NOT BE PAINTED.
- 8. CONTRACTOR TO CONFIRM GROUNDING SYSTEM WITH PROJECT MEP PRIOR TO BID.

4 LIGHT POLE FOOTING	
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